ARCHITECTUAL NARRATIVE:

THE WILLOUGHBY CORNER DEVELOPMENT IS LOCATED AT THE INTERSECTION OF SEVERAL DIVERSE NEIGHBORHOODS WITH A VARIETY OF DESIGN INFLUENCES. THE NORTH BOUNDARY OF THE PROPERTY IS FORMED BY THE EAST END OF EMMA STREET, ONE OF THE MAIN EAST-WEST ROADS IN THE HISTORIC OLD TOWN DISTRICT OF LAFAYETTE THE EAST BOUNDARY IS 120TH STREET WHICH IS A BUSY THOROUGHFARE WITH SMALL, DISPERSED RESIDENTIAL AND AGRICULTURAL BUILDINGS TO THE EAST. A LARGE INDUSTRIAL BUILDING ABUTS THE SOUTH EDGE OF THE PROPERTY, WHILE TO THE WEST-SOUTHWEST LIES THE PEAK-TO-PEAK CHARTER SCHOOL CAMPUS. WITHIN SUCH AN ECLECTIC NEIGHBORHOOD, WILLOUGHBY CORNER WILL EMPLOY A DECIDEDLY RESIDENTIAL AESTHETIC IN THE OVERALL FORM AND MATERIALS OF THE BUILDINGS.

MID-SIZE APARTMENT FLATS IN LAND USE AREA 'D' ARE LIMITED TO TWO STORIES IN HEIGHT WITH WALK-UP UNITS ON THE GROUND FLOOR AND PARKING UNDERNEATH A SECOND STORY OF UNITS. THE LARGEST APARTMENT BUILDINGS ARE LOCATED ALONG THE SOUTH EDGE OF THE SITE IN LAND USE AREAS 'E' AND 'F', AND ARE THREE STORIES IN HEIGHT IN LAND USE AREA 'C' IN THE CENTER OF WILLOUGHBY CORNER. THE COMMUNITY BUILDING PROVIDES ADMINISTRATIVE OFFICES AND COMMUNAL GATHERING SPACE ADJACENT TO A VARIETY OF OUTDOOR AMENITIES AND THE MAIN BUS STOP.

TO BETTER ENGAGE THE NEIGHBORHOOD AND CREATE A LIVABLE, CONNECTED COMMUNITY, EACH OF THE BUILDING TYPOLOGIES FEATURES PORCHES, PATIOS, AND/OR BALCONIES. THE MID-SIZE APARTMENT FLATS FEATURE PARTIALLY COVERED PATIOS AS A SECONDARY ENTRANCE TO EACH GROUND FLOOR UNIT, AND SECOND LEVEL BALCONIES FOR THE UPPER UNITS. THE LARGE APARTMENT BUILDINGS SIMILARLY INCLUDE PATIOS WITH PARTIALLY COVERED SECONDARY ENTRANCES TO THE GROUND FLOOR UNITS. THE UPPER-LEVEL APARTMENTS FEATURE LARGE PICTURE WINDOWS TO BRING IN AIR AND LIGHT TO THE UNITS WITHOUT DIRECT ACCESS TO THE GROUND FLOOR.

THE ARCHITECTURAL FEATURES ARE DIVERSE AND ECLECTIC WITH A CREATIVE USE OF COMMON ELEMENTS. PREDOMINANT ROOF FORMS FEATURE PITCHED ROOFS THROUGHOUT THE SITE, WITH A VARIETY OF SLOPES OFFERING DISTINCTIONS BETWEEN DIFFERENT BUILDING TYPES LARGE ROOF AREAS ARE BROKEN UP INTO SMALLER FORMS TO REDUCE THE OVERALL MASS OF THE BUILDINGS. THE APARTMENT BUILDINGS CONTAIN FLAT ROOF AREAS TO ACCOMMODATE MECHANICAL EQUIPMENT AND PHOTOVOLTAIC SYSTEMS, WITH PITCHED ROOFS FACING THE STREETS AND COMMUNITY SPACES. THE PRIMARY ROOFING MATERIALS ARE SHINGLES WITH METAL ROOF ACCENTS AND MEMBRANE ROOFING AT FLAT AREAS.

EXTERIOR BUILDING MATERIALS ARE PRIMARILY FIBER CEMENT SIDING IN KEEPING WITH THE RESIDENTIAL CHARACTER OF THE OVERALL NEIGHBORHOOD. A MIX OF HORIZONTAL LAP SIDING, VERTICAL BOARD-AND-BATTEN SIDING, PANEL SIDING, AND OTHER ACCENT SIDING MATERIALS AND TRIM PROVIDE VARIETY TO THE BUILDING TYPES. THE MID-SIZE APARTMENT FLATS INCLUDE COLOR ACCENTS AT THE PRIMARY ENTRANCES FOR WAYFINDING. THE LARGER APARTMENT BUILDINGS FEATURE BRICK MASONRY IN EARTHY COLORS TO FORM A SOLID, DURABLE BASE. RESIDENTIAL WINDOWS WILL BE VINYL OR FIBERGLASS AND COMMON AREA WINDOWS WILL BE OF ALUMINUM STOREFRONT, WITH ENERGY-EFFICIENT DETAILING. IN ADDITION TO THEIR AESTHETIC QUALITIES, THE EXTERIOR MATERIALS ARE SELECTED FOR DURABILITY AND FIRE-RESISTANT PROPERTIES.

PROJECT SUMMARY

THE PHASE 1 SITE PLAN FOR WILLOUGHBY CORNER INCLUDES 192 PERMANETLY AFFORDABLE APARTMENTS, INCLUDING 63 UNITS AGE-RESTRICTED FOR RESIDENTS 55+; SURFACE AND TUCK-UNDER PARKING; A 4300 SF COMMUNITY BUILDING; PARK, GARDEN AND RECREATION AREAS ON PARCELS C, D, E F; AND OUTLOTS I, J, AND K OF THE WILLOUGHBY CORNER PUD. THIS SITE PLAN INCLUDES AN RTD TRANSIT STOP ON CANTERBURY DR. AND OTHER MOBILITY INFRASTRUCTURE AMENITIES.

ZONING:

EXISTING ZONING: R-4 (RESIDENTIAL HIGH-DENSITY)

CODE MODIFICATIONS:

CODE MODIFICATIONS APPLICABLE TO THIS SITE PLAN ARE BASED ON THOSE APPROVED WITH THE FINAL PUD AND ALSO INCLUDES

1. PARKING STALL LENGTHS REDUCED FROM 19' TO 18'

2. STREET TREES MAY BE PLANTED AT DISTANCES VARYING FROM THE REQUIRED 40' SPACING.

		PHA	SE '	1 SIT	<u>E PLAN</u>	N PARKING	FABLE			
		REQU	IRED B	Y PUD	TOTAL REQUIRED	TOTAL PROPOSED	# ADA PARKING SPACES	# EV READY SPACES	# EV CAPABLE SPACES	# BICYCLE SPACES
PARCEL	USE	1 BRs	2 BRs	3 BRs						
D	MULTI-FAMILY	1.0	1.5	1.75	30	28				6
F	MULTI-FAMILY	1.0	1.5	1.75	123	59	3	6	12	
E	SENIOR HOUSING	0.75	1.25		54	97	4	10	20	
С	COMMUNITY CENTER		1/770 SF		6	34	3	4	7	6
	TOTAL:				213	218	10	20	39	12

* PER THE WILLOUGHBY CORNER PUD, SHARED PARKING IS ALLOWED ACROSS PARCELS WITHIN THE PUD.

PHASE 1 SITE DA	ATA TABLE
COMPREHENSIVE PLAN LAND USE	HOUSING AREA
ZONING	R4-HIGH DENSITY RESIDENTIAL
TOTAL PHASE 1 SITE AREA	16.27 ACRES
TOTAL ROW	6.90 ACRES
TOTAL LANDSCAPE / PARK AREAS IN OUTLOTS I, J, & K	3.39 ACRES

PARCEL	USE	SITE AREA	NO. OF RESIDENTIAL UNITS	TOTAL SQUARE FEET		LANDSCAPE/ SOFTSCAPE (SF +%)	HARDSCAPE		LOT COV	/ERAGE	HE	IGHT	NO. OF	FLOORS		DING RATION	FRONT SET	BACK	REAR SETBACK		SIDE S	ЕТВАСК	SETBAC CANTE	K FROM RBURY	SETBACK WILLOU	
AREA LOT									ALLOWED (%)		REQUIRED	PROPOSED	ALLOWED	PROPOSED	REQUIRED	PROPOSED	REQUIRED	PROPOSED	REQUIRED	PROPOSED	REQUIRED	PROPOSED	REQUIRED	PROPOSED	REQUIRED	PROPOS
159,160 &161	COMMUNITY BUILDING	30,431	0	4,515	4,515	3,387	1,529	11,275	90	57	45	26	3	1	30	30	0* (FRONTS OF BUILDINGS FACE PARKING LOT)	6	0*/6' FROM ALLEY FOR NORTH BUILDING/10' FROM CANTERBURY FOR SOUTH BUILDING	10	0*+++	o	10*	10	10*	10
164	MULTI-FAMILY	88,388	18	30,100 (1)	15,050 (1)	9,477	1,893		80	19	35	33	2	2	20	30	10*	10	1*	1	2*+++	10	10*	10	10*	10
165	SENIOR HOUSING	81,665	63	64,500	21,340	17,726	14,205	29,405	50	80	45	44	3	3	30	50	15++++	15	10*	85	20	30	15+++++	15	N/A	N/A
166 &167	MULTI-FAMILY	92,928	111	117,600	38,000	23,000	8,773	19,881	50	72	45	44	3	3	30	50	15+++++	15	10*	10	20	20	15+++++	15	N/A	N/A


UWN MAB WN BY:

(1) INCLUDES TUCK-UNDER PARKING * CODE MODIFICATION AS PER APPROVED PUD

*+++EXCEPT THE SIDES FACING WILLOUGHBY ST. +++++ FRONT PORCHES MAY ENCROACH 5 FT. INTO REQUIRED SETBACK.

WILLOUGHBY CORNER SITE PLAN - PHASE 1

LOTS 160, 161, 164, 165, 166 & 167, & OUTLOTS F, I, J & K OF THE WILLOUGHBY CORNER SUBDIVISION, CITY OF LAFAYETTE, COUNTY OF BOULDER, STATE OF COLORADO

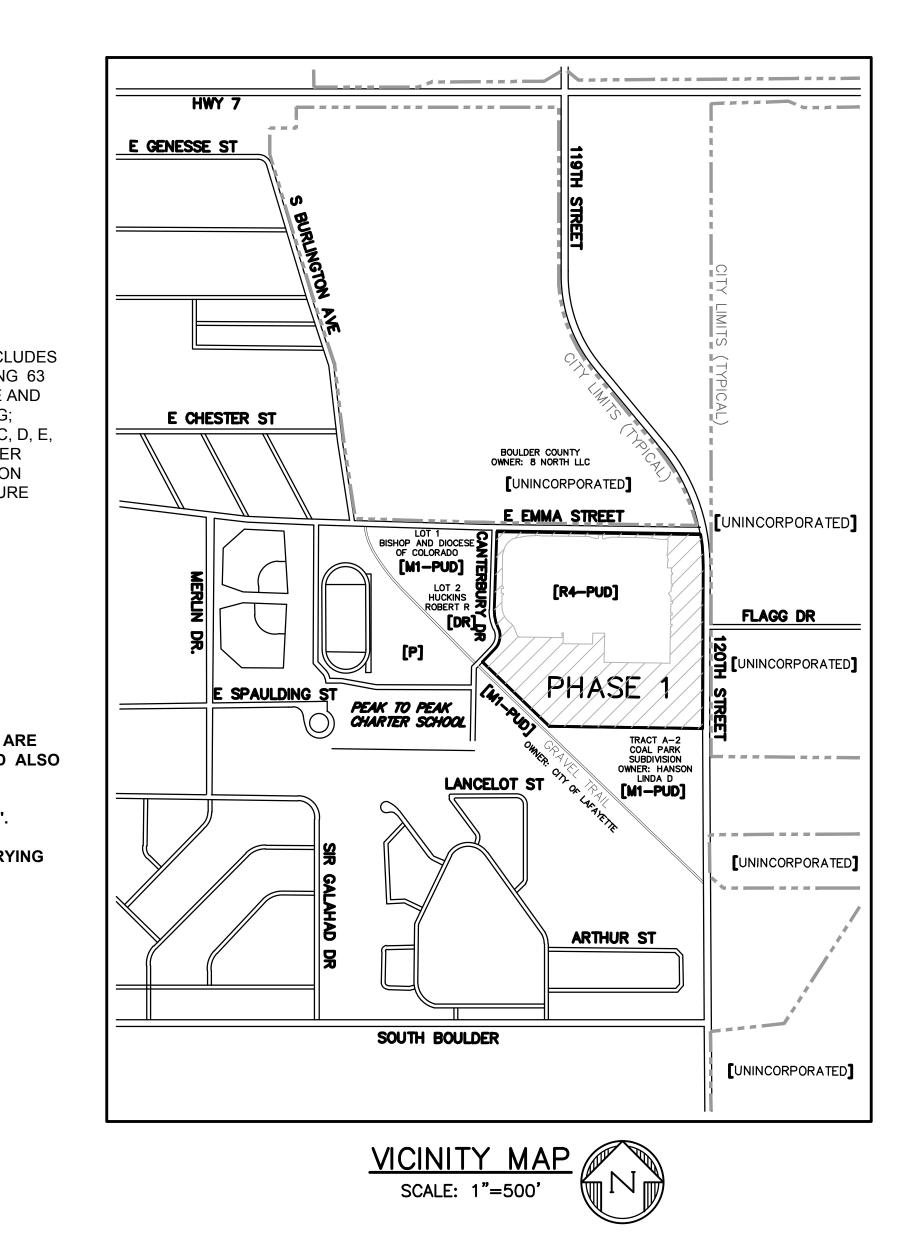

LEGAL DESCRIPTION:

A TRACT OF LAND LOCATED IN THE SE1/4 OF SECTION 2, T1S, R69W OF THE 6TH P.M., CITY OF LAFAYETTE, COUNTY OF BOULDER, STATE OF COLORADO. BEING MORE PARTICULARLY DESCRIBED AS FOLLOWS:

LOTS 160, 161, 164, 165, 166 & 167, & OUTLOTS F, I, J, K OF THE WILLOUGHBY CORNER SUBDIVISION, CITY OF LAFAYETTE, COUNTY OF **BOULDER, STATE OF COLORADO**

DEVELOPMENT TEAM:

OWNER: BOULDER COUNTY HOUSING AUTHORITY 3400 Broadway, Boulder, CO 80304 Phone: (303) 441-3861 **Contact: Molly Chiang, Senior Developer**

ARCHITECTURE: HB&A

102 E. Moreno Avenue, Colrado Springs, CO 80903 Phone: (719) 473-7063 www.hbaa.com Contact: Tino Leone, Principal & Architect

CIVIL-SURVEY:

DREXEL, BARRELL & CO. 1800 38th Street, Boulder, CO 80301 Phone: (303) 442-4338 www.drexelbarrell.com Contact Civil: Cameron Knapp, P.E. Contact Survey: Mathew Selders, P.L.S.



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SF	IEET INDEX TABLE
Sheet Number	Sheet Title
1	COVER SHEET
2	GENERAL NOTES
3	OVERALL SITE
4	SITE PLAN 1
5	SITE PLAN 2
6	GRADING PLAN 1
7	GRADING PLAN 2
8	UTILITY PLAN 1
9	UTILITY PLAN 2
10	EROSION CONTROL PLAN 1
11	EROSION CONTROL PLAN 2
12	LANDSCAPE NOTES
13	LANDSCAPE PLANT SCHEDULE
14	LANDSCAPE AMENITY/MATERIAL SCHEDULE
15	OVERALL LANDSCAPE PLAN
16	LANDSCAPE PLAN
17	LANDSCAPE PLAN
18	LANDSCAPE PLAN
19	LANDSCAPE PLAN
20	LANDSCAPE DETAILS
21	LANDSCAPE DETAILS
22	IRRIGATION SCHEDULE
23	OVERALL IRRIGATION PLAN
24	IRRIGATION PLAN
25	IRRIGATION PLAN
26	IRRIGATION PLAN
27	IRRIGATION PLAN
28	IRRIGATION DETAILS
29	IRRIGATION DETAILS
30	IRRIGATION DETAILS
31	SENIOR BUILDING ELEVATIONS
32	SENIOR BUILDING ELEVATIONS
33	SENIOR BUILDING ELEVATIONS
34	MULTI-FAMILY 1 BUILDING ELEVATIONS
35	MULTI-FAMILY 1 BUILDING ELEVATIONS
36	MULTI-FAMILY 2 BUILDING ELEVATIONS
37	MULTI-FAMILY 2 BUILDING ELEVATIONS
38	COMMUNITY BUILDING 1 ELEVATIONS
39	FLATS BUILDING 1 ELEVATIONS
40	FLATS BUILDING 2 ELEVATIONS
41	MISCELLANEOUS STRUCTURE ELEVATIONS
42	SITE PHOTOMETRICS
43	SITE PHOTOMETRICS (CANOPY ALT)
44	PHOTOMETRIC DETAILS

M ORNE GHBY

OWNER: BOULDER COUNTY HOUSING AUTHORITY 3400 BROADWAY BOULDER, CO - 80304 303.441.3861 CONTACT: MOLLY CHIANG

DATE:

06.17.22 - SITE PLAN 01

PLANNER-LANDSCAPE: NORRIS DESIGN 1101 Bannock Street, Denver, CO 80204 Phone: (303) 892-1166 www.norris-design.com Contact: Kristin Dean, Senior Associate

TRAFFIC ENGINEER: KIMLEY HORN 4582 S. Ulster Street, Suite 1500, Denver, CO 80237 Phone: (303) 228-2329 Contact: Chris Hopkins, P.E.

PHOTOMETRIC/LIGHTING: FARNSWORTH GROUP 5613 Dtc Prky, Suite 1100, Greenwood Village, CO 80111 Phone: (303) 692-8838 **Contact: Will Mettling**

SHEET TITLE:
COVER SHEET
& INDEX

81

APPROVED:

CITY ENGINEER

REVIEW IS FOR GENERAL CONFORMANCE WITH THE CITY OF LAFAYETTE "STANDARDS AND SPECIFICATIONS," LATEST EDITION. SOLE RESPONSIBILITY FOR COMPLETENESS AND/OR ACCURACY OF THESE DOCUMENTS SHALL REMAIN WITH THE REGISTERED PROFESSIONAL ENGINEER SEALING THESE PLANS. THE CITY DOES NOT ACCEPT LIABILITY FOR FACILITIES DESIGNED BY OTHERS.

DATE



GENERAL NOTES

1. ALL CONSTRUCTION IN THE PUBLIC RIGHT-OF-WAY, OR PUBLIC EASEMENTS SHALL CONFORM TO THE CITY OF LAFAYETTE STANDARDS AND SPECIFICATIONS.

2. SIGNS AND MARKINGS INSTALLED IN THE RIGHT-OF-WAY TO COMPLY WITH THE MANUAL OF UNIFORM TRAFFIC CONTROL DEVICES. LATEST REVISION EDITION.

3. THE LOCATION OF EXISTING UNDERGROUND UTILITIES ARE SHOWN IN AN APPROXIMATE WAY ONLY AND HAVE NOT BEEN INDEPENDENTLY VERIFIED BY THE OWNER OR ITS REPRESENTATIVE. THE CONTRACTOR SHALL DETERMINE THE EXACT LOCATION OF ALL EXISTING UTILITIES, WHETHER SHOWN ON THESE PLANS OR NOT, BEFORE COMMENCING WORK, AND AGREES TO BE FULLY RESPONSIBLE FOR ANY AND ALL DAMAGES WHICH MIGHT BE OCCASIONED BY THE CONTRACTOR'S FAILURE TO EXACTLY LOCATE AND PRESERVE ANY AND ALL UTILITIES.

4. ALL DAMAGED EXISTING CURB, GUTTER, AND SIDEWALK MUST BE BROUGHT TO CURRENT CITY STANDARDS PRIOR TO ISSUANCE OF CERTIFICATE OF OCCUPANCY.

5. PRIOR TO ANY CONSTRUCTION WITHIN THE PUBLIC RIGHT-OF-WAY, THE CONTRACTOR SHALL ACQUIRE ANY NECESSARY PERMITS FROM THE DEPARTMENT OF PUBLIC WORKS AS REQUIRED BY ORDINANCE.

6. CONTRACTOR SHALL CONTACT ALL APPROPRIATE UTILITY COMPANIES AND THE CITY OF LAFAYETTE TO OBTAIN ALL NECESSARY LOCATES 48 HOURS BEFORE CONSTRUCTION BEGINS.

7. NO VARIANCE FROM THE SPECIFICATIONS AND NOTES HEREIN SHALL BE ACCEPTED WITHOUT PRIOR WRITTEN APPROVAL BY THE CITY OF LAFAYETTE.

8. ALL PHASES OF THE WORK SHALL BE INSPECTED AND APPROVED BY THE CITY OF LAFAYETTE.

DEMOLITION NOTES

1. THE CONTRACTOR SHALL DOCUMENT THE CONDITION OF ALL EXISTING FEATURES TO REMAIN PRIOR TO THE BEGINNING OF WORK. ALL ITEMS DAMAGED OR DISTURBED SHALL BE REPAIRED OR REPLACED IN KIND TO THE SATISFACTION OF THE OWNER AT NO ADDITIONAL CONTRACT COST.

2. DRAINAGE STRUCTURES SHALL NOT BE REMOVED UNTIL SATISFACTORY ARRANGEMENTS HAVE BEEN MADE TO ACCOMMODATE TRAFFIC AND DRAINAGE.

3. WHERE PORTIONS OF IMPROVEMENTS ARE TO BE REMOVED, THE PORTIONS DESIGNATED TO REMAIN SHALL BE PROTECTED FROM DAMAGE. ALL DAMAGE TO STRUCTURES DESIGNATED TO REMAIN IN PLACE SHALL BE REPAIRED AT THE CONTRACTOR'S EXPENSE.

4. EXISTING IMPROVEMENTS, SUCH AS PAVEMENT, SIDEWALKS, CURBS, THE CONTRACTOR SHALL SAW CUT AT LIMITS OF REMOVAL TO A TRUE LINE, WITH A VERTICAL FACE AND TO A MINIMUM DEPTH OF 2-INCHES OR TO THE DEPTH OF THE REINFORCING STEEL, WHICHEVER OCCURS FIRST. IF THE EDGE IS DAMAGED DURING CONSTRUCTION, IT SHALL BE RE-CUT PRIOR TO CONSTRUCTING THE NEW IMPROVEMENTS.

5. SAW CUTS MAY DEVIATE SLIGHTLY FROM THE DESIGN IF A CONTROL JOINT IS WITHIN A REASONABLE DISTANCE FROM THE SAW CUT AS SHOWN ON THIS PLAN. COSTS ASSOCIATED WITH THE REMOVAL AND REPLACEMENT OF ANY ADDITIONAL CURB. GUTTER. OR SIDEWALK THAT IS REQUIRED DUE TO DEVIATIONS IN THE SAW CUT LOCATION WILL BE THE RESPONSIBILITY OF THE CONTRACTOR.

5. COORDINATE ANY SHUTDOWN OF EXISTING UTILITIES WITH UTILITY OWNERS PRIOR TO PROCEEDING WITH THE WORK.

6. CONTRACTOR SHALL INSTALL EROSION AND SEDIMENT CONTROL MEASURES PRIOR TO SITE CLEARING OR DEMOLITION ACTIVITIES.

7. ABANDONMENT PROCEDURES SHALL CONFORM TO SECTION 1000, CITY OF LAFAYETTE STANDARDS & SPECIFICATIONS, LATEST VERSION.

ADJACENT PROPERTY - COORDINATION AND RESTORATION

1. THE PROPOSED CONSTRUCTION INCLUDES WORK OFF SITE AND IN PROPRIETIES OWNED BY PRIVATE PROPERTY OWNERS (WITHIN EASEMENTS) AND THE CITY. THE WORK IS WITHIN EASEMENTS DEDICATED FOR THE PROPOSED USE.

2. IF WORKING IN LANDS OWNED BY THE CITY, THE CONTRACTOR SHALL WORK UNDER THE REQUIREMENTS OF THE PERMIT FROM THE CITY.

3. IF WORKING IN LANDS OWNED BY PRIVATE PROPERTY OWNERS, THE CONTRACTOR SHALL NOTIFY SAID OWNER OF UPCOMING WORK AND ALLOW SAID OWNER A MINIMUM OF TWO WEEKS TO REMOVE ANY ITEMS WITHIN THE EASEMENT WHICH MAY IMPEDE CONSTRUCTION. THE CONTRACTOR SHALL PROVIDED ANY AND ALL MEANS NECESSARY TO MAINTAIN ANY FENCES OR ENCLOSURES FOR PROTECTION AND SECURITY OF THE PRIVATE HOMEOWNER. THE CONTRACTOR SHALL RESTORE THE AREA TO MATCH EXISTING CONDITIONS, OR BETTER, AND SHALL OBTAIN WRITTEN APPROVAL SIGN OFF FROM THE OWNER UPON COMPLETION.

4. THE CONTRACTOR SHALL PREPARE A TRAFFIC CONTROL PLAN FOR ANY ROAD CLOSURES.

WILLOUGHBY CORNER SITE PLAN - PHASE 1

LOTS 160, 161, 164, 165, 166 & 167, & OUTLOTS F, I, J & K OF THE WILLOUGHBY CORNER SUBDIVISION, CITY OF LAFAYETTE, COUNTY OF BOULDER, STATE OF COLORADO

UTILITY NOTES

1. ALL WATER AND SANITARY SEWER MATERIALS AND CONSTRUCTION SHALL CONFORM TO CITY OF LAFAYETTE STANDARDS AND SPECIFICATIONS, LATEST EDITION THEREOF.

2. WATER SERVICE LINE TAPS SHALL BE WET TAPS INSTALLED BY A CONTRACTOR OR PLUMBER LICENSED BY THE CITY WHO SPECIALIZES IN THE INSTALLATION OF WATER TAPS.

3. CONTRACTOR SHALL PROTECT ALL ADJACENT IMPROVEMENTS (BUILDINGS, PARKING LOTS, LANDSCAPE AREAS, ETC ...) FROM DAMAGE AND EROSION. ALL DISTURBED AREAS OFF-SITE SHALL BE RESTORED TO A MINIMUM OF THEIR ORIGINAL CONDITION AT THE CONTRACTOR'S EXPENSE.

4. THE CONTRACTOR SHALL OBTAIN ALL NECESSARY PERMITS TO COMPLETE THE PROPOSED WORK AND SHALL COMPLY WITH ALL LOCAL, STATE AND FEDERAL REGULATIONS.

5. PAVING CONTRACTOR SHALL ADJUST ALL VALVE BOXES AND MANHOLE COVERS TO FINAL GRADE. 6. ALL EXISTING UTILITY LINE LOCATIONS SHALL BE VERIFIED BY THE CONTRACTOR AND THE ENGINEER NOTIFIED PRIOR TO CONSTRUCTION. IT IS THE PLANS' INTENT TO SHOW ALL EXISTING UTILITIES, HOWEVER IT SHALL BE THE CONTRACTOR'S RESPONSIBILITY TO VERIFY THAT ALL EXISTING UTILITIES, WHETHER SHOWN ON THESE PLANS OR NOT, HAVE BEEN PROPERLY LOCATED.

7. PROVIDE CONCRETE THRUST BLOCKING AT ALL BENDS, TEES, PLUGS AND HYDRANTS.

8. WATER, STORM SEWER AND SANITARY SEWER PIPE SHALL BE BEDDED IN ACCORDANCE WITH CITY OF LAFAYETTE STANDARDS AND SPECIFICATIONS, LATEST EDITION THEREOF.

9. ALL WATER LINES SHALL HAVE A MINIMUM FOUR AND A HALF (4-1/2) FEET OF COVER BELOW FINISHED GRADE.

10. CONTRACTOR SHALL COORDINATE DRY UTILITY LOCATIONS WITH ARCHITECT AND PROVIDER AGENCY.

11. ALL STATIONING AND OFFSETS ARE FROM ROAD CENTERLINE ALIGNMENT TO THE CENTERLINES OF MANHOLES, INLETS AND UTILITY LINES UNLESS NOTED OTHERWISE.

12. SANITARY SEWER LINES SHALL BE POLYVINYL CHLORIDE (PVC) PIPE, SDR 35, IN ACCORDANCE WITH OR MEETING ASTM D3034.

13. SANITARY SEWER MAINS IN "ALLEY" MAY HAVE LESS THAN 9 FEET OF ELEVATION DIFFERENCE BETWEEN FINISHED LOT GRADE AT BUILDING LINE AND THE TOP OF THE SANITARY MAIN. SERVICE LINES SHALL BE INSTALLED WITH A MINIMUM OF 4 FEET OF COVER AND NO LESS THAN 2.0% SLOPE.

14. WATER LINES SHALL BE A.W.W.A. C-900 CLASS 200 PVC PRESSURE PIPE. ALL WATER SERVICES WITH PIPE DIAMETERS THROUGH 2 INCHES SHALL BE TYPE K COPPER IN ACCORDANCE WITH ASTM B88. ALL WATER SERVICE LINES LARGER THAN 2-INCH ARE TO BE C-900. SEE CITY DETAIL 200-4 FOR LOCATOR TAPE AND TRACER WIRE STANDARDS.

15. WATERLINE FITTINGS SHALL BE DUCTILE-IRON OR CAST-IRON CONFORMING TO THE REQUIREMENTS SET FORTH IN ANSI A21.10. A.W.W.A. C110. CAST-IRON FITTINGS 12-INCH SIZE AND SMALLER SHALL BE CLASS 250. ALL DUCTILE IRON PIPE FITTINGS AND APPURTENANCES WILL BE PROTECTED WITH A 10-MIL THICK POLYETHYLENE FILM WRAP.

16. MANHOLES SHALL BE STANDARD PRECAST CONCRETE. SEE CITY STANDARD DETAILS.

17. STANDARD FIRE HYDRANT ASSEMBLY SHALL INCLUDE THE SWIVEL TEE. VALVE, 6" PIPE TO THE HYDRANT AND THE HYDRANT.

18. STORM SEWER PIPE IN THE ROW SHALL BE REINFORCED CONCRETE PIPE (RCP) IN ACCORDANCE WITH ASTM C-76. PIPE SHALL BE CLASS III.

19. ALL STORM SEWER PIPE JOINTS SHALL BE INTEGRAL BELL AND SPIGOT WITH RUBBER O-RING TYPE GASKETS PER ASTM C-361.

20. ALL STORM SEWER PIPE FLARED END SECTIONS SHALL BE INSTALLED WITH PREFABRICATED TRASH RACKS APPROPRIATE FOR THE PIPE SIZE AND AS SPECIFIED OR SUPPLIED BY THE MANUFACTURER.

21. PIPING FOR UNDERDRAIN SYSTEM AND ROOF DRAINS SHALL BE PVC PIPE, SDR 35, OR APPROVED EQUIVALENT AND SHALL BE A COLOR OF PVC OTHER THAN GREEN OR BLUE.

22. PROVIDE APPROPRIATE WARNING TAPE FOR EACH UTILITY.

22. AS-BUILT DRAWINGS SHALL BE PROVIDED IN ACCORDANCE WITH SECTION 106.2.2 OF THE CITY OF LAFAYETTE STANDARDS AND SPECIFICATIONS. AS-BUILT INFORMATION MUST INCLUDE ELEVATIONS FOR WATER, SANITARY SEWER, STORM SEWER, AND UNDERDRAIN ELEVATIONS. AS-BUILTS SHALL BE PREPARED BY THE CONTRACTOR AND SUBMITTED TO THE CITY OF LAFAYETTE FOR APPROVAL.

TAKE PLACE.

2. ANY EARTH DISTURBANCE SHALL BE CONDUCTED IN SUCH MANNER SO AS TO EFFECTIVELY REDUCE ACCELERATED SOIL EROSION AND RESULTING SEDIMENTATION AND SHOULD NOT EXCEED THE EROSION EXPECTED TO OCCUR FOR THE SITE IN ITS TOTALLY UNDEVELOPED STATE.

3. ALL PERSONS ENGAGED IN EARTH DISTURBANCES SHALL DESIGN, IMPLEMENT AND MAINTAIN ACCEPTABLE SOIL EROSION AND SEDIMENTATION CONTROL MEASURES, IN CONFORMANCE WITH THE EROSION CONTROL TECHNICAL STANDARDS ADOPTED BY THE CITY.

4. ALL EARTH DISTURBANCES SHALL BE DESIGNED, CONSTRUCTED AND COMPLETED IN SUCH A MANNER SO THAT THE EXPOSED AREA OF ANY DISTURBED LAND SHALL BE LIMITED TO THE SHORTEST POSSIBLE PERIOD OF TIME.

5. SEDIMENT CAUSED BY ACCELERATED SOIL EROSION SHALL BE REMOVED FROM RUNOFF WATER BEFORE IT LEAVES THE SITE OF THE EARTH DISTURBANCE.

6. ANY TEMPORARY OR PERMANENT FACILITY DESIGNED AND CONSTRUCTED FOR THE CONVEYANCE OF WATER AROUND, THROUGH OR FROM THE EARTH DISTURBANCE AREA SHALL BE DESIGNED TO LIMIT THE WATER FLOW TO A NON-EROSIVE VELOCITY

7. TEMPORARY SOIL EROSION CONTROL FACILITIES SHALL BE REMOVED AND EARTH DISTURBANCE AREAS GRADED AND STABILIZED WITH PERMANENT SOIL EROSION CONTROL MEASURES PURSUANT TO THE CITY STANDARDS AND SPECIFICATIONS AND IN ACCORDANCE WITH THE PERMANENT EROSION CONTROL FEATURES SHOWN ON THE GRADING AND EROSION CONTROL PLAN.

8. PERMANENT SOIL EROSION CONTROL MEASURES FOR ALL SLOPES, CHANNELS, DITCHES OR ANY DISTURBED LAND AREA SHALL BE COMPLETED WITHIN FOURTEEN (14) CALENDAR DAYS AFTER FINAL GRADING OR THE EARTH DISTURBANCE HAS BEEN COMPLETED. WHEN IT IS NOT POSSIBLE TO PERMANENTLY STABILIZE A DISTURBED AREA AFTER AN EARTH DISTURBANCE HAS BEEN COMPLETED OR WHERE SIGNIFICANT EARTH DISTURBANCE ACTIVITY CEASES, TEMPORARY SOIL EROSION CONTROL MEASURES SHALL BE IMPLEMENTED WITHIN FOURTEEN (14) CALENDAR DAYS. ALL TEMPORARY SOIL EROSION CONTROL MEASURES SHALL BE MAINTAINED UNTIL PERMANENT SOIL EROSION MEASURES ARE IMPLEMENTED.

GRADING NOTES

1. ALL SPOT ELEVATIONS ARE FLOWLINE OF CURB AND GUTTER, TOP OF PAVING, OR FINISHED GRADE UNLESS OTHERWISE NOTED.

2. ALL PROPOSED CONTOURS ARE TO TOP OF FINISHED PAVING AND LANDSCAPED AREAS UNLESS OTHERWISE NOTED.

3. MAXIMUM LANDSCAPE SLOPE SHALL BE 4(HOR) TO 1(VERT) MINIMUM SLOPE ON LANDSCAPED AREAS SHALL BE 2.00% MINIMUM SLOPE ON ASPHALT SURFACES SHALL BE 1.00% MINIMUM SLOPE ON CONCRETE SURFACES SHALL BE 0.50% UNLESS OTHERWISE NOTED.

4. REFER TO SOILS REPORT FURNISHED BY OWNER FOR ALL COMPACTION REQUIREMENTS.

5. ADD 5100 TO ALL (TRUNCATED) SPOT ELEVATIONS AND CONTOUR ELEVATIONS TO REACH PROJECT VERTICAL DATUM.

6. PAVING CONTRACTOR SHALL ADJUST ALL VALVE BOXES AND MANHOLE COVERS TO THE FINAL GRADES INDICATED ON PLANS.

2017.

9. CONTRACTOR SHALL NOTIFY THE SURVEY AND/OR ENGINEER PRIOR TO CONSTRUCTION OF ALL CURB RAMPS TO VERIFY THAT DESIGN ELEVATIONS AT THE TOP OF THE RAMPS WILL MEET ADA REQUIREMENTS BASED ON CONSTRUCTED FLOWLINE ELEVATIONS.



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EROSION CONTROL NOTES

1. ALL TEMPORARY EROSION CONTROL FACILITIES AND ALL PERMANENT FACILITIES INTENDED TO CONTROL EROSION OF ANY EARTH DISTURBANCE OPERATION SHALL BE INSTALLED BEFORE ANY EARTH DISTURBANCE OPERATIONS

7. EXISTING SPOT ELEVATIONS AND TOPOGRAPHIC INFORMATION COMES FROM AN ALTA AND FIELD SURVEY CONDUCTED BY DREXEL, BARRELL & CO. COMPLETED IN JUNE 1,

8. CONCRETE WALKS SHALL HAVE A DESIGNED CROSS SLOPE NOT TO EXCEED 2% ONCE CONSTRUCTED PER ADA REQUIREMENTS.

10. IT SHALL BE THE RESPONSIBILITY OF THE CONTRACTOR TO MAINTAIN AND PROVIDE FOR ADEQUATE DRAINAGE THROUGH THE SITE DURING THE PROCESS OF EXCAVATION. GRADING AND EMBANKMENT. THE GRADE SHALL BE MAINTAINED IN SUCH CONDITION THAT IT IS WELL DRAINED AT ALL TIMES.



OWNER: BOULDER COUNTY HOUSING AUTHORITY 3400 BROADWAY BOULDER, CO - 80304 303.441.3861 CONTACT: MOLLY CHIANG

06.17.22 - SITE PLAN 01


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SHEET TITLE: NOTES SHEET




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WILLOUGHBY CORNER



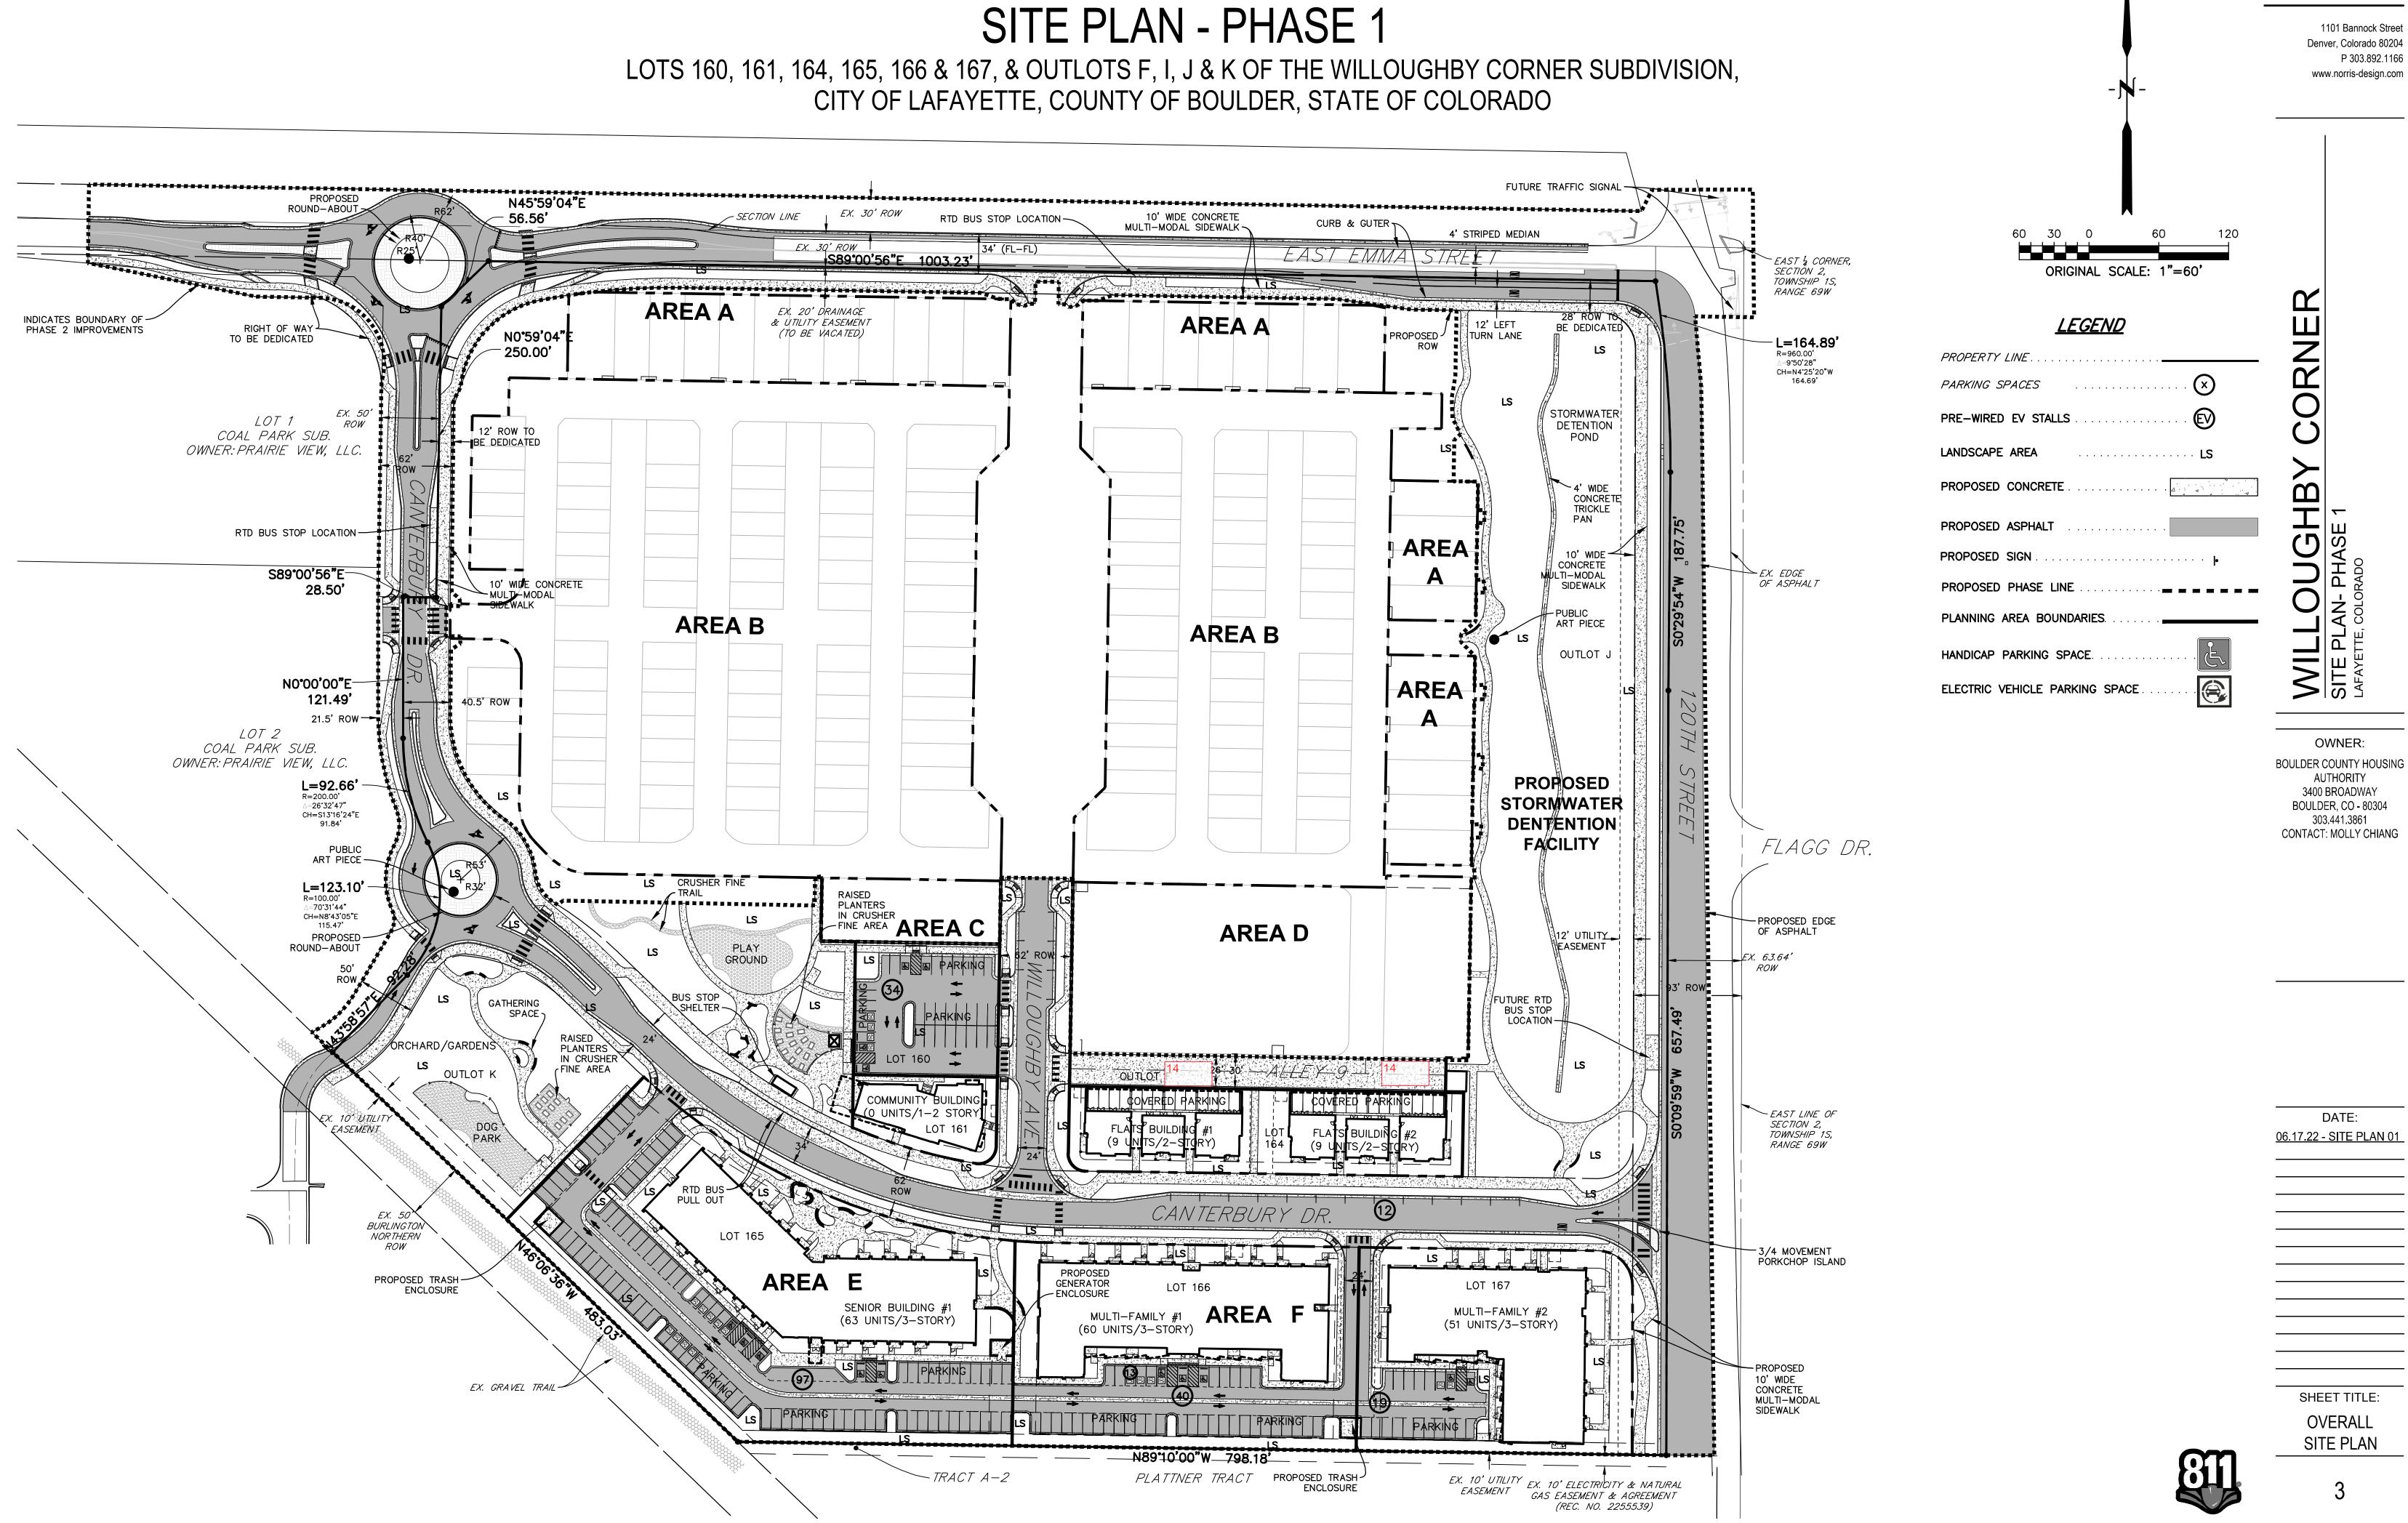


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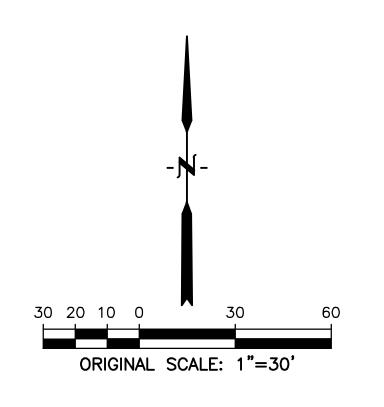
WILLOUGHBY CORNER SITE PLAN - PHASE 1

LOTS 160, 161, 164, 165, 166 & 167, & OUTLOTS F, I, J & K OF THE WILLOUGHBY CORNER SUBDIVISION, CITY OF LAFAYETTE, COUNTY OF BOULDER, STATE OF COLORADO

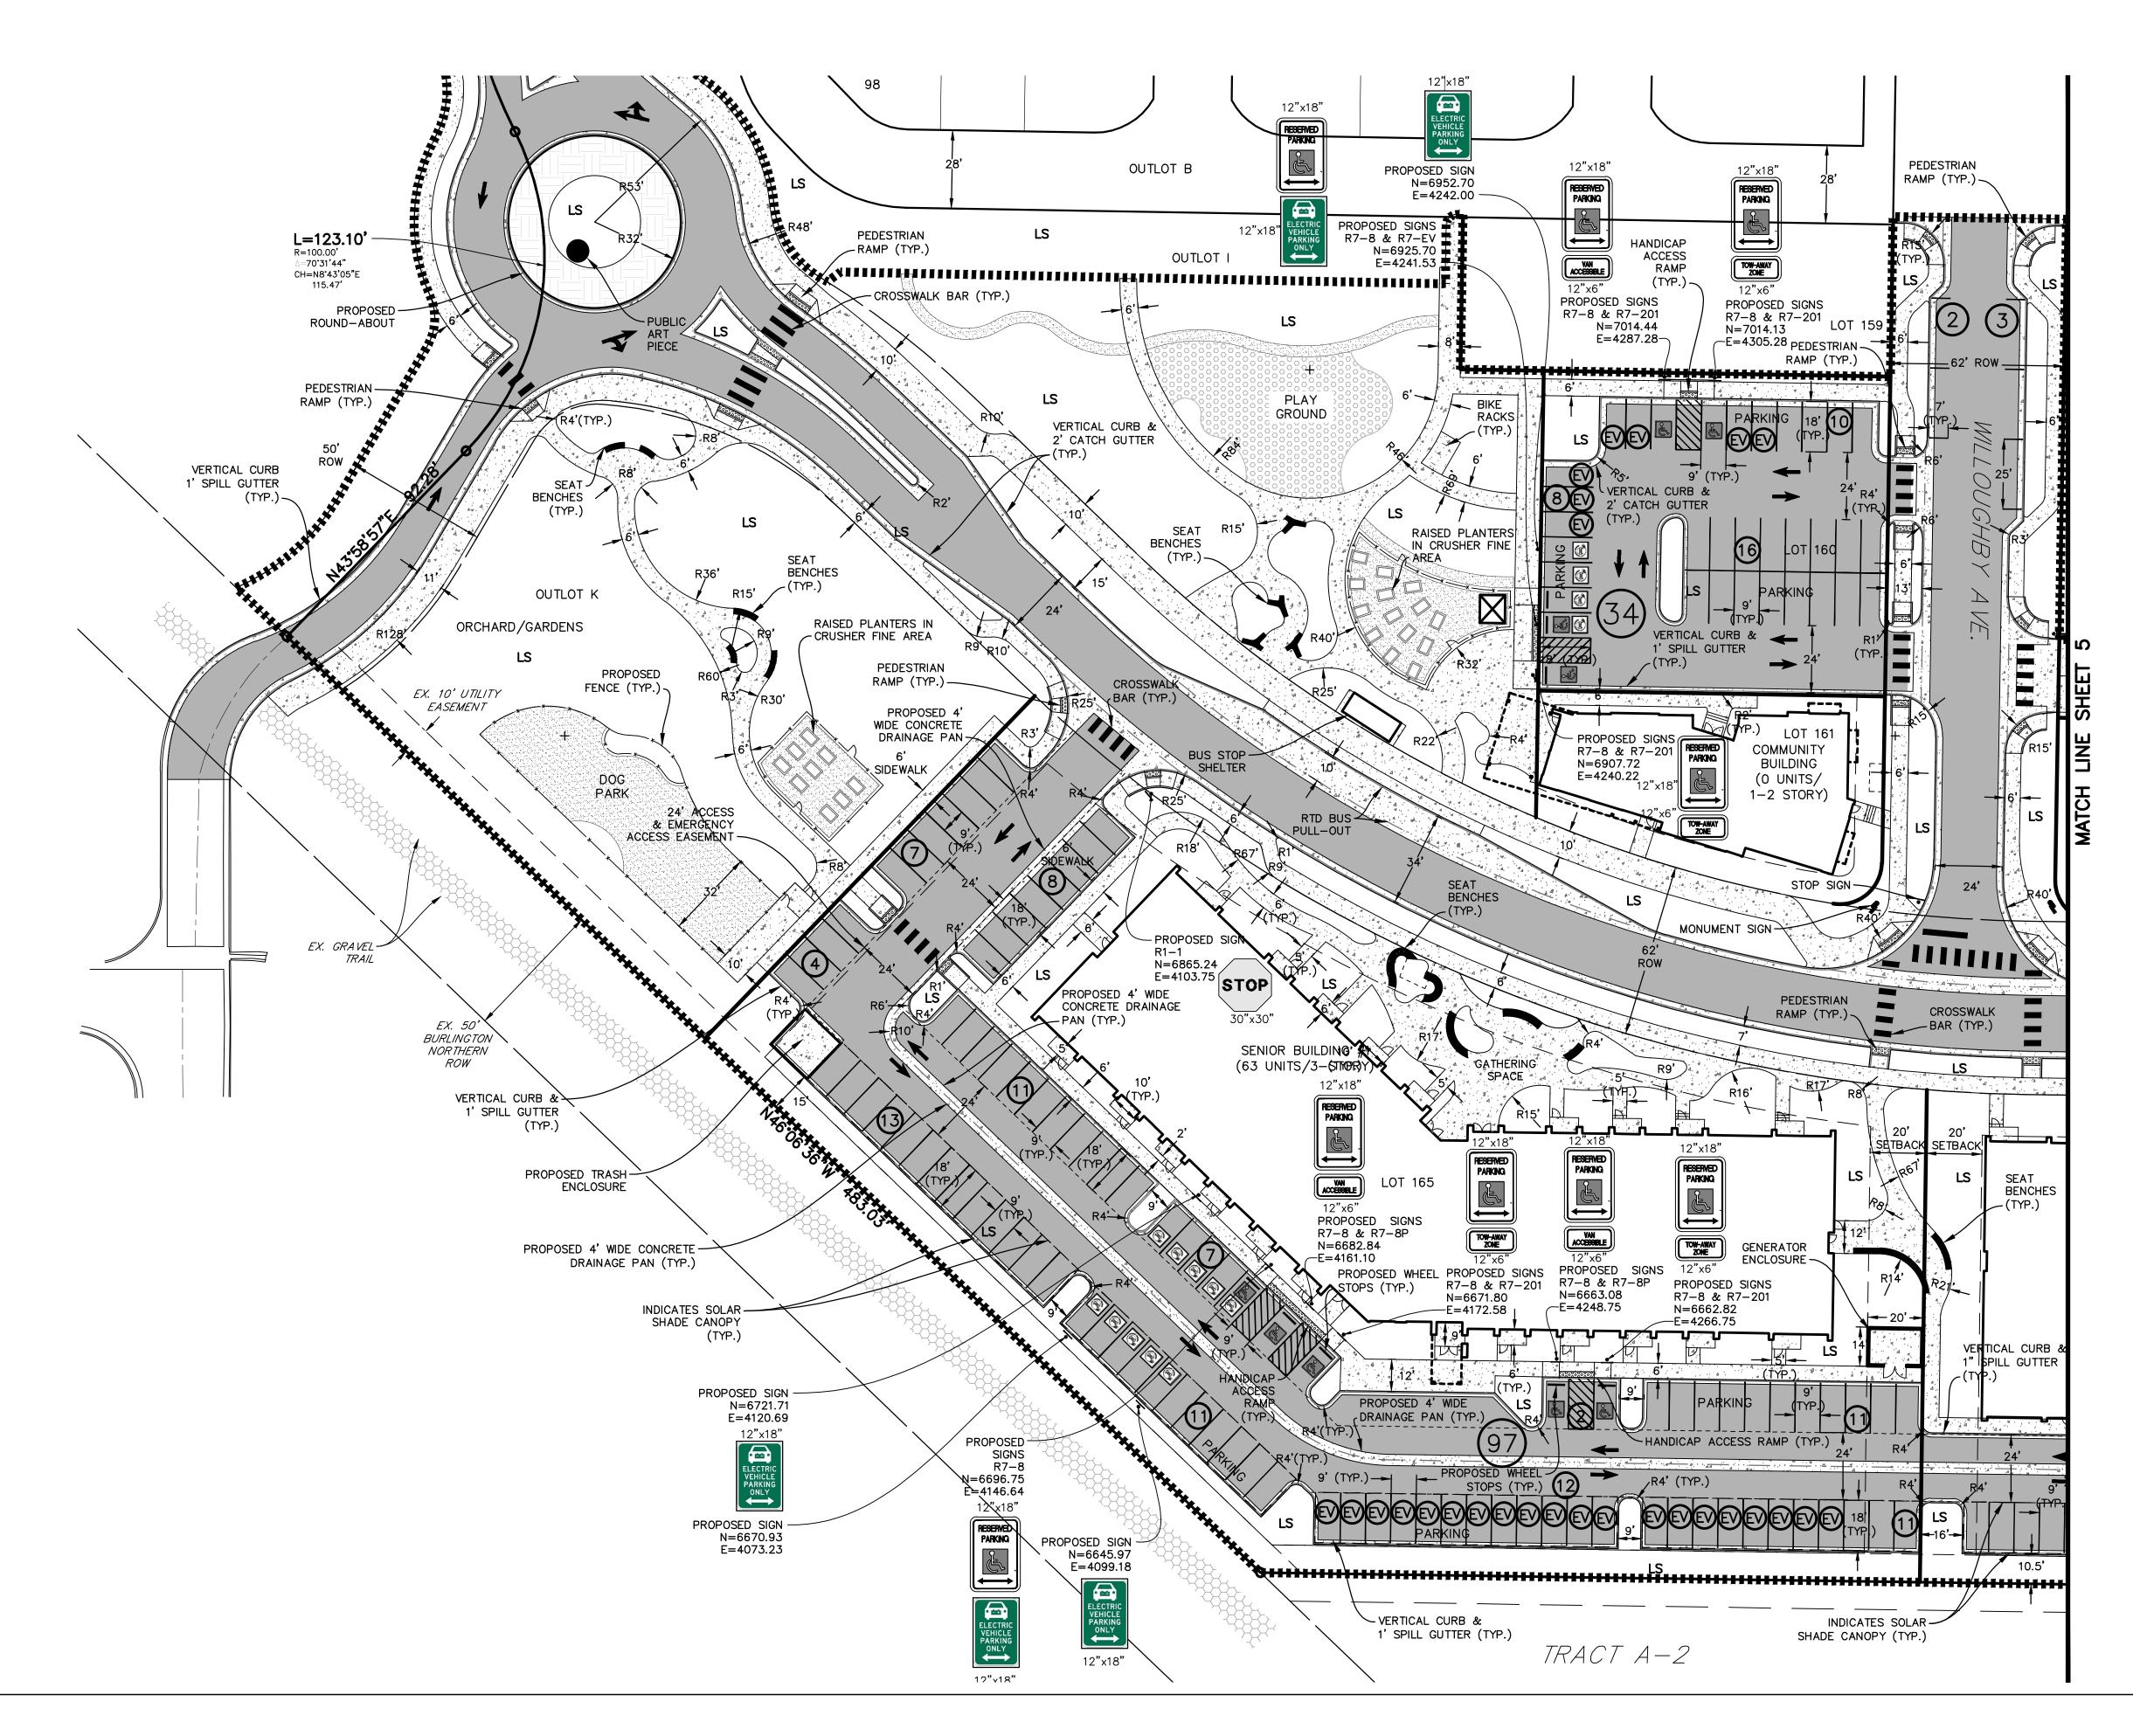



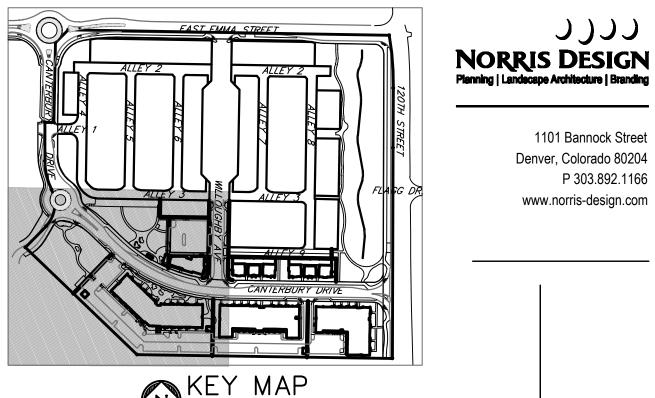





PROPERTY LINE
PARKING SPACES
PRE-WIRED EV STALLS
LANDSCAPE AREA LS
PROPOSED ASPHALT
PROPOSED SIGN
PROPOSED PHASE LINE
HANDICAP PARKING SPACE
ELECTRIC VEHICLE PARKING SPACE



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1101 Bannock Street Denver, Colorado 80204


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OWNER: BOULDER COUNTY HOUSING AUTHORITY 3400 BROADWAY BOULDER, CO - 80304 303.441.3861 CONTACT: MOLLY CHIANG

DATE:
<u>06.17.22 - SITE PLAN 01</u>
SHEET TITLE:
SITE
PLAN 1






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WILLOUGHBY CORNER SITE PLAN - PHASE 1

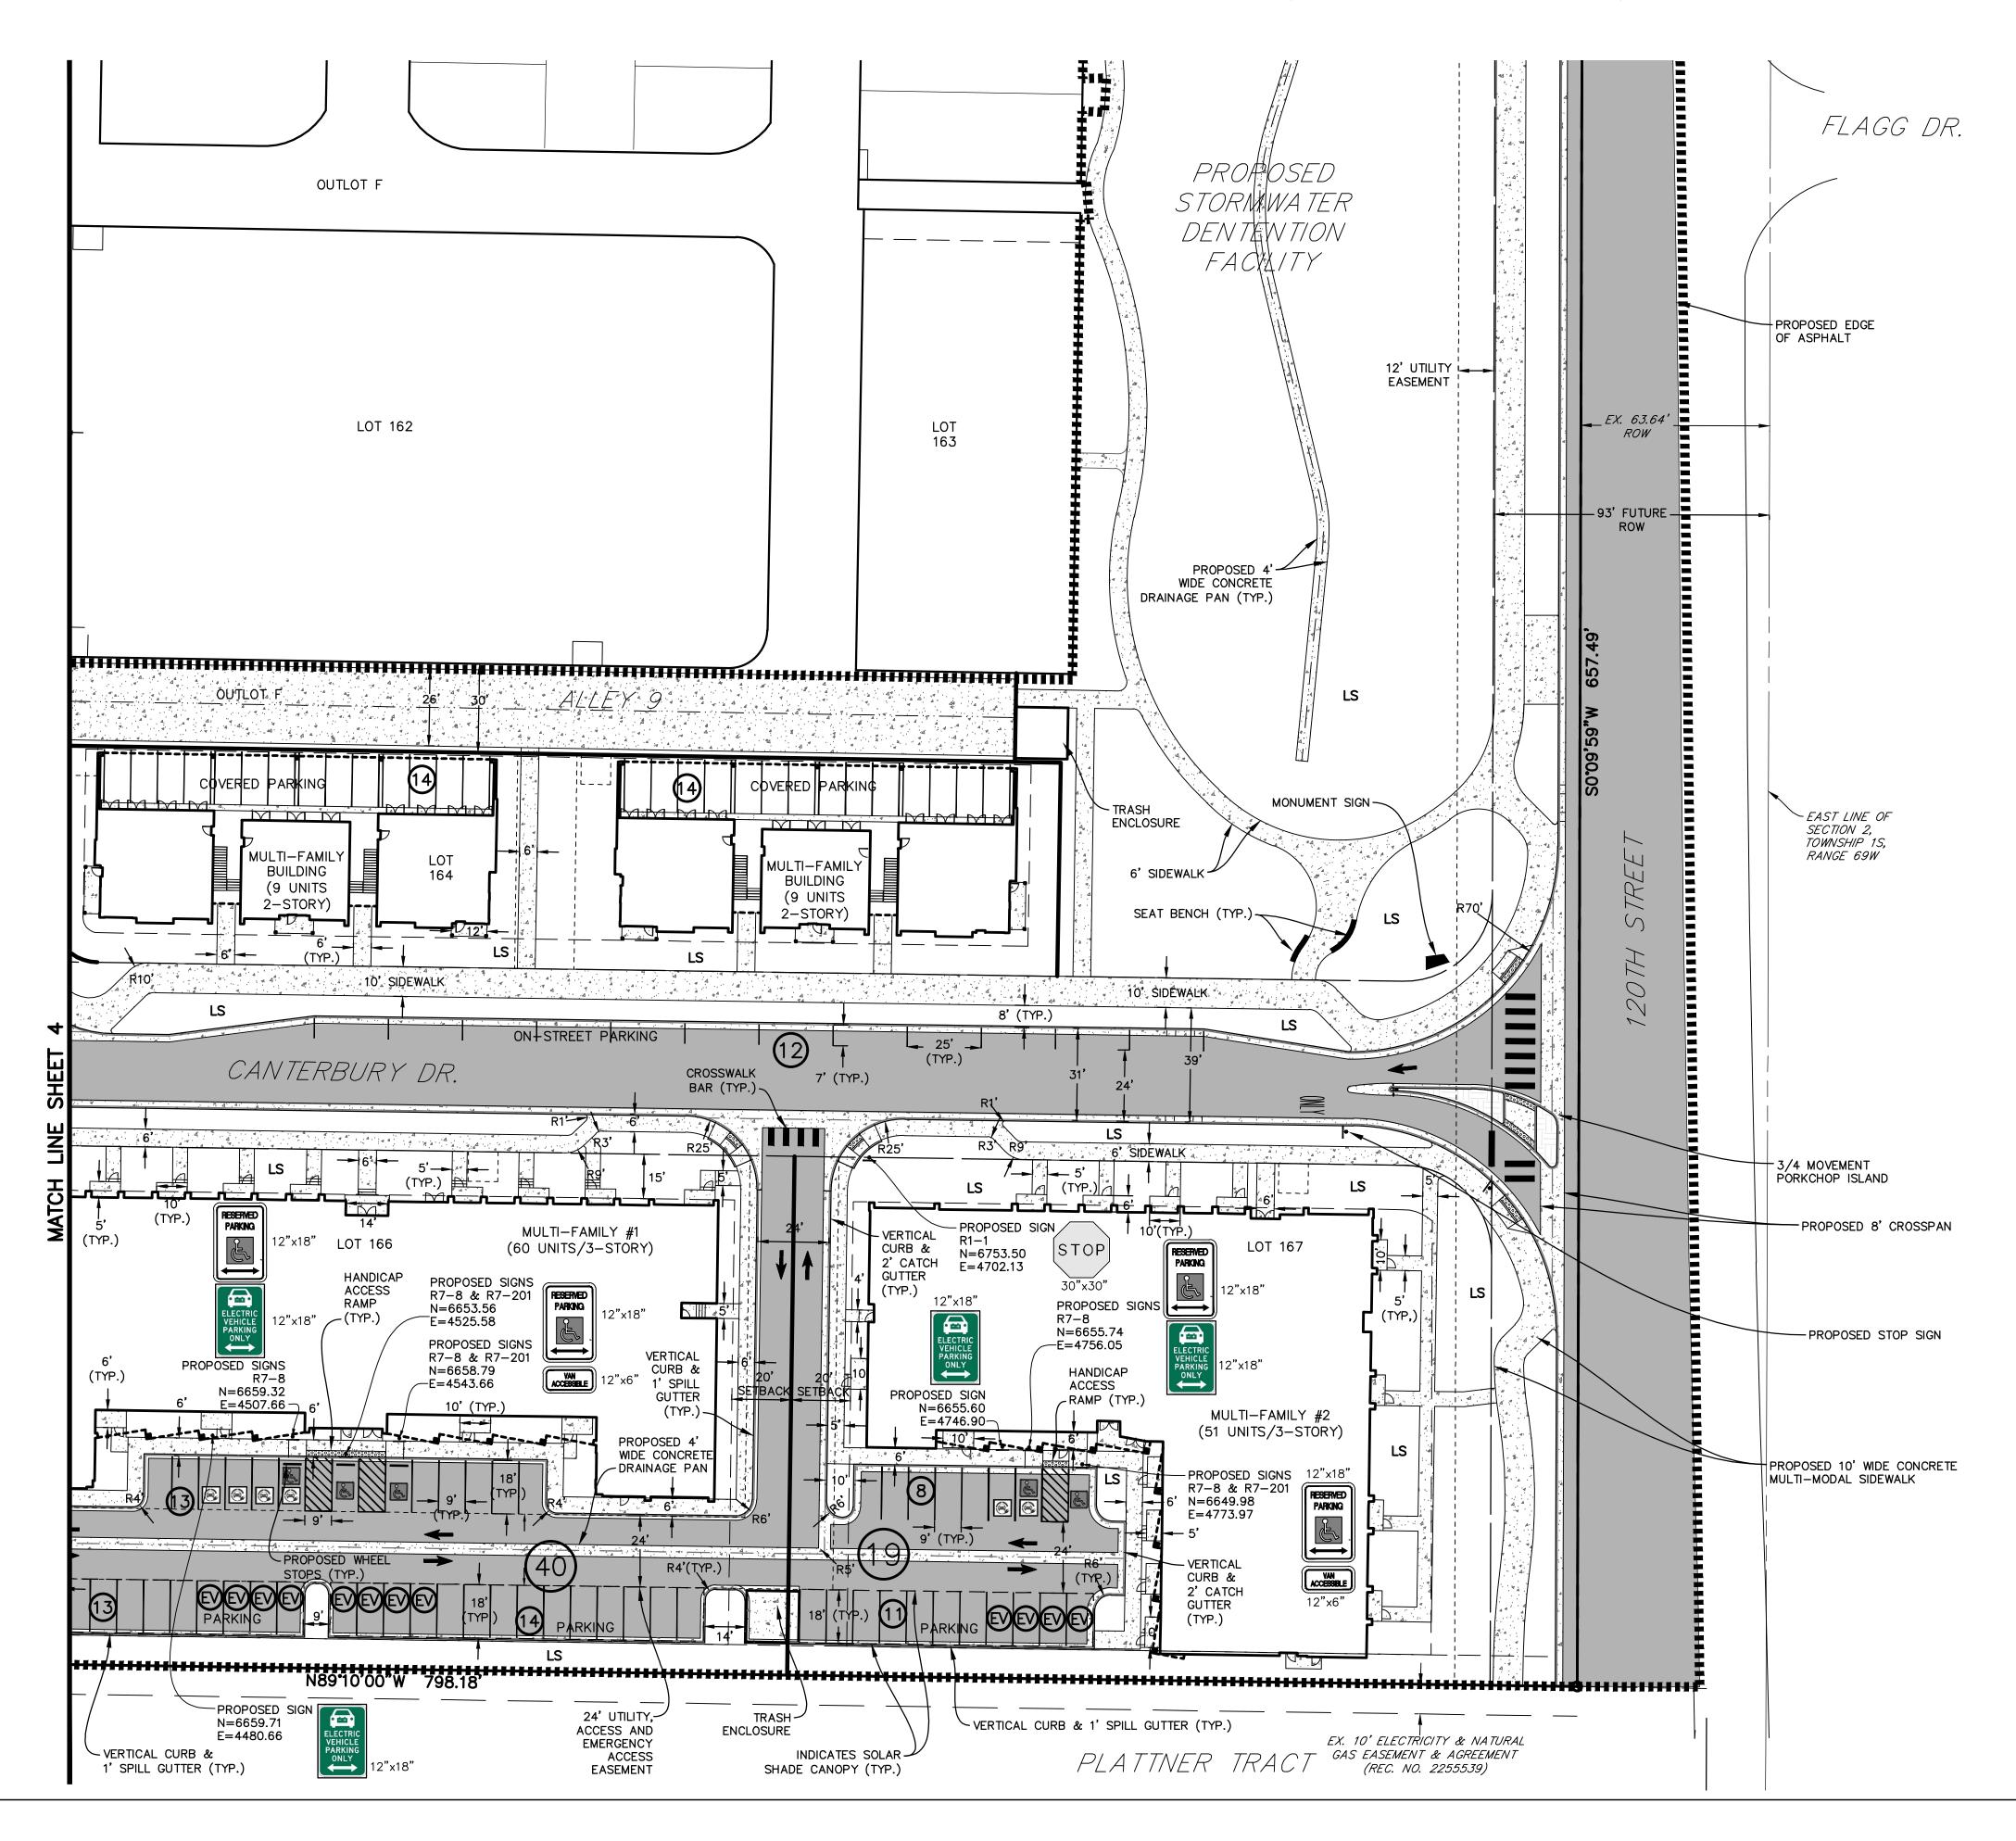
LOTS 160, 161, 164, 165, 166 & 167, & OUTLOTS F, I, J & K OF THE WILLOUGHBY CORNER SUBDIVISION, CITY OF LAFAYETTE, COUNTY OF BOULDER, STATE OF COLORADO

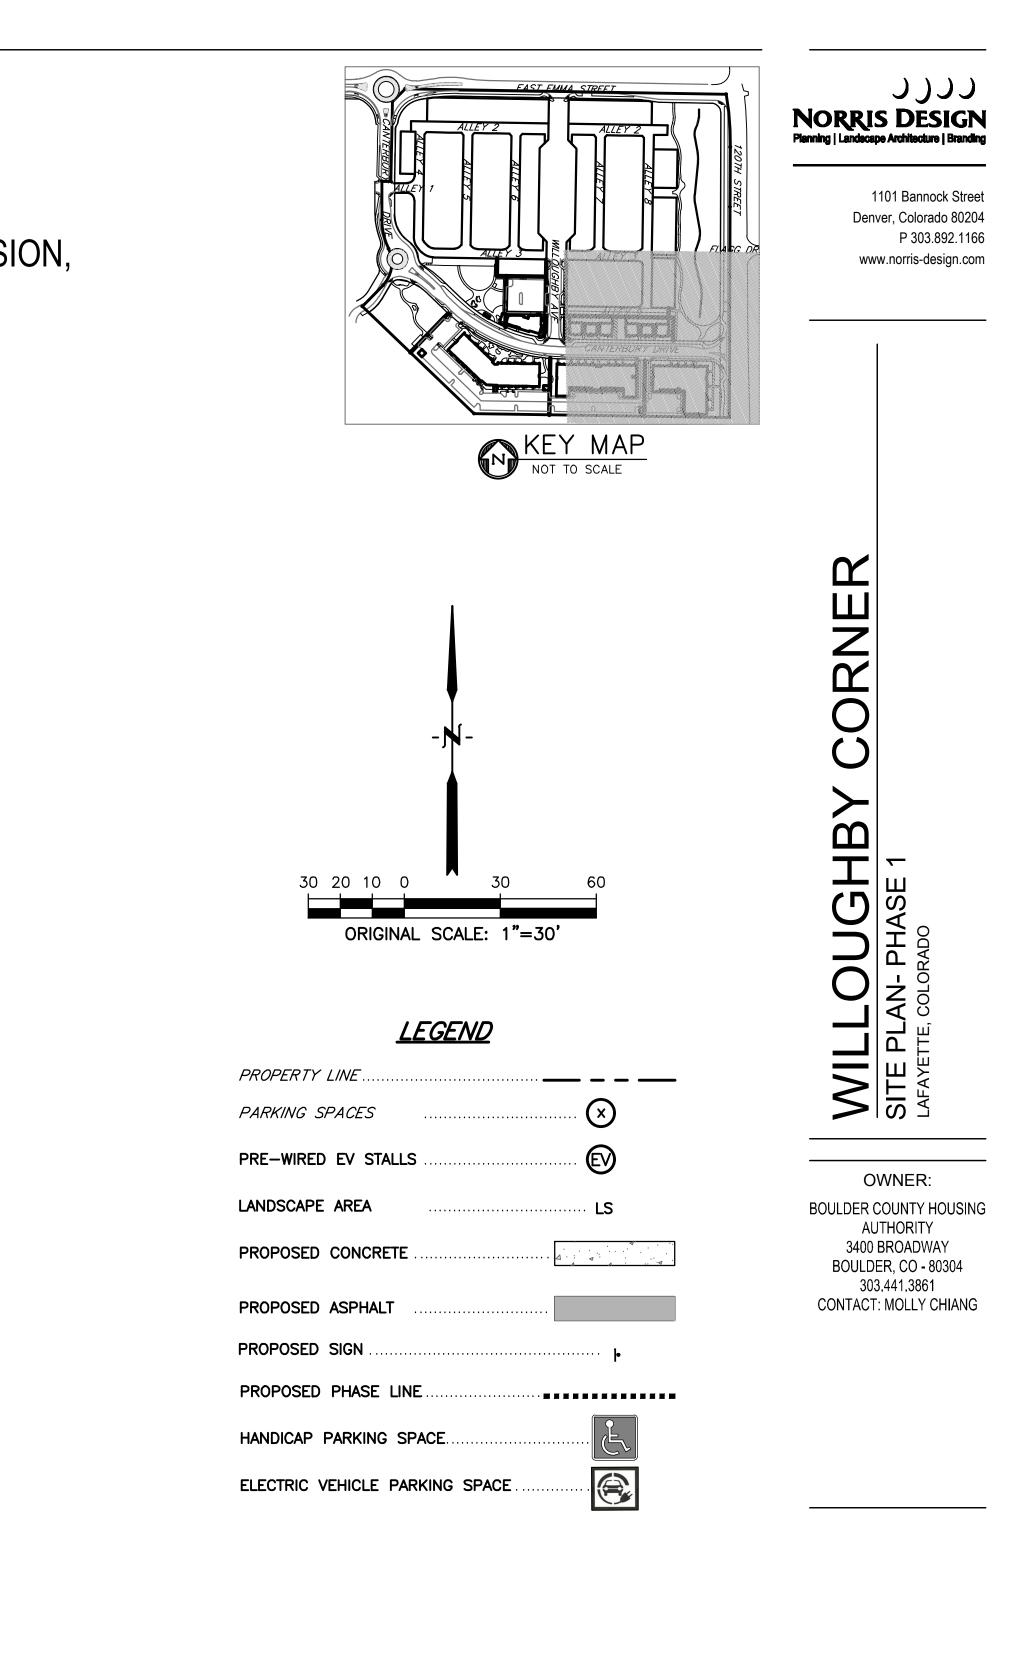

DATE:
<u>06.17.22 - SITE PLAN 01</u>
SHEET TITLE:
SITE
PLAN 2





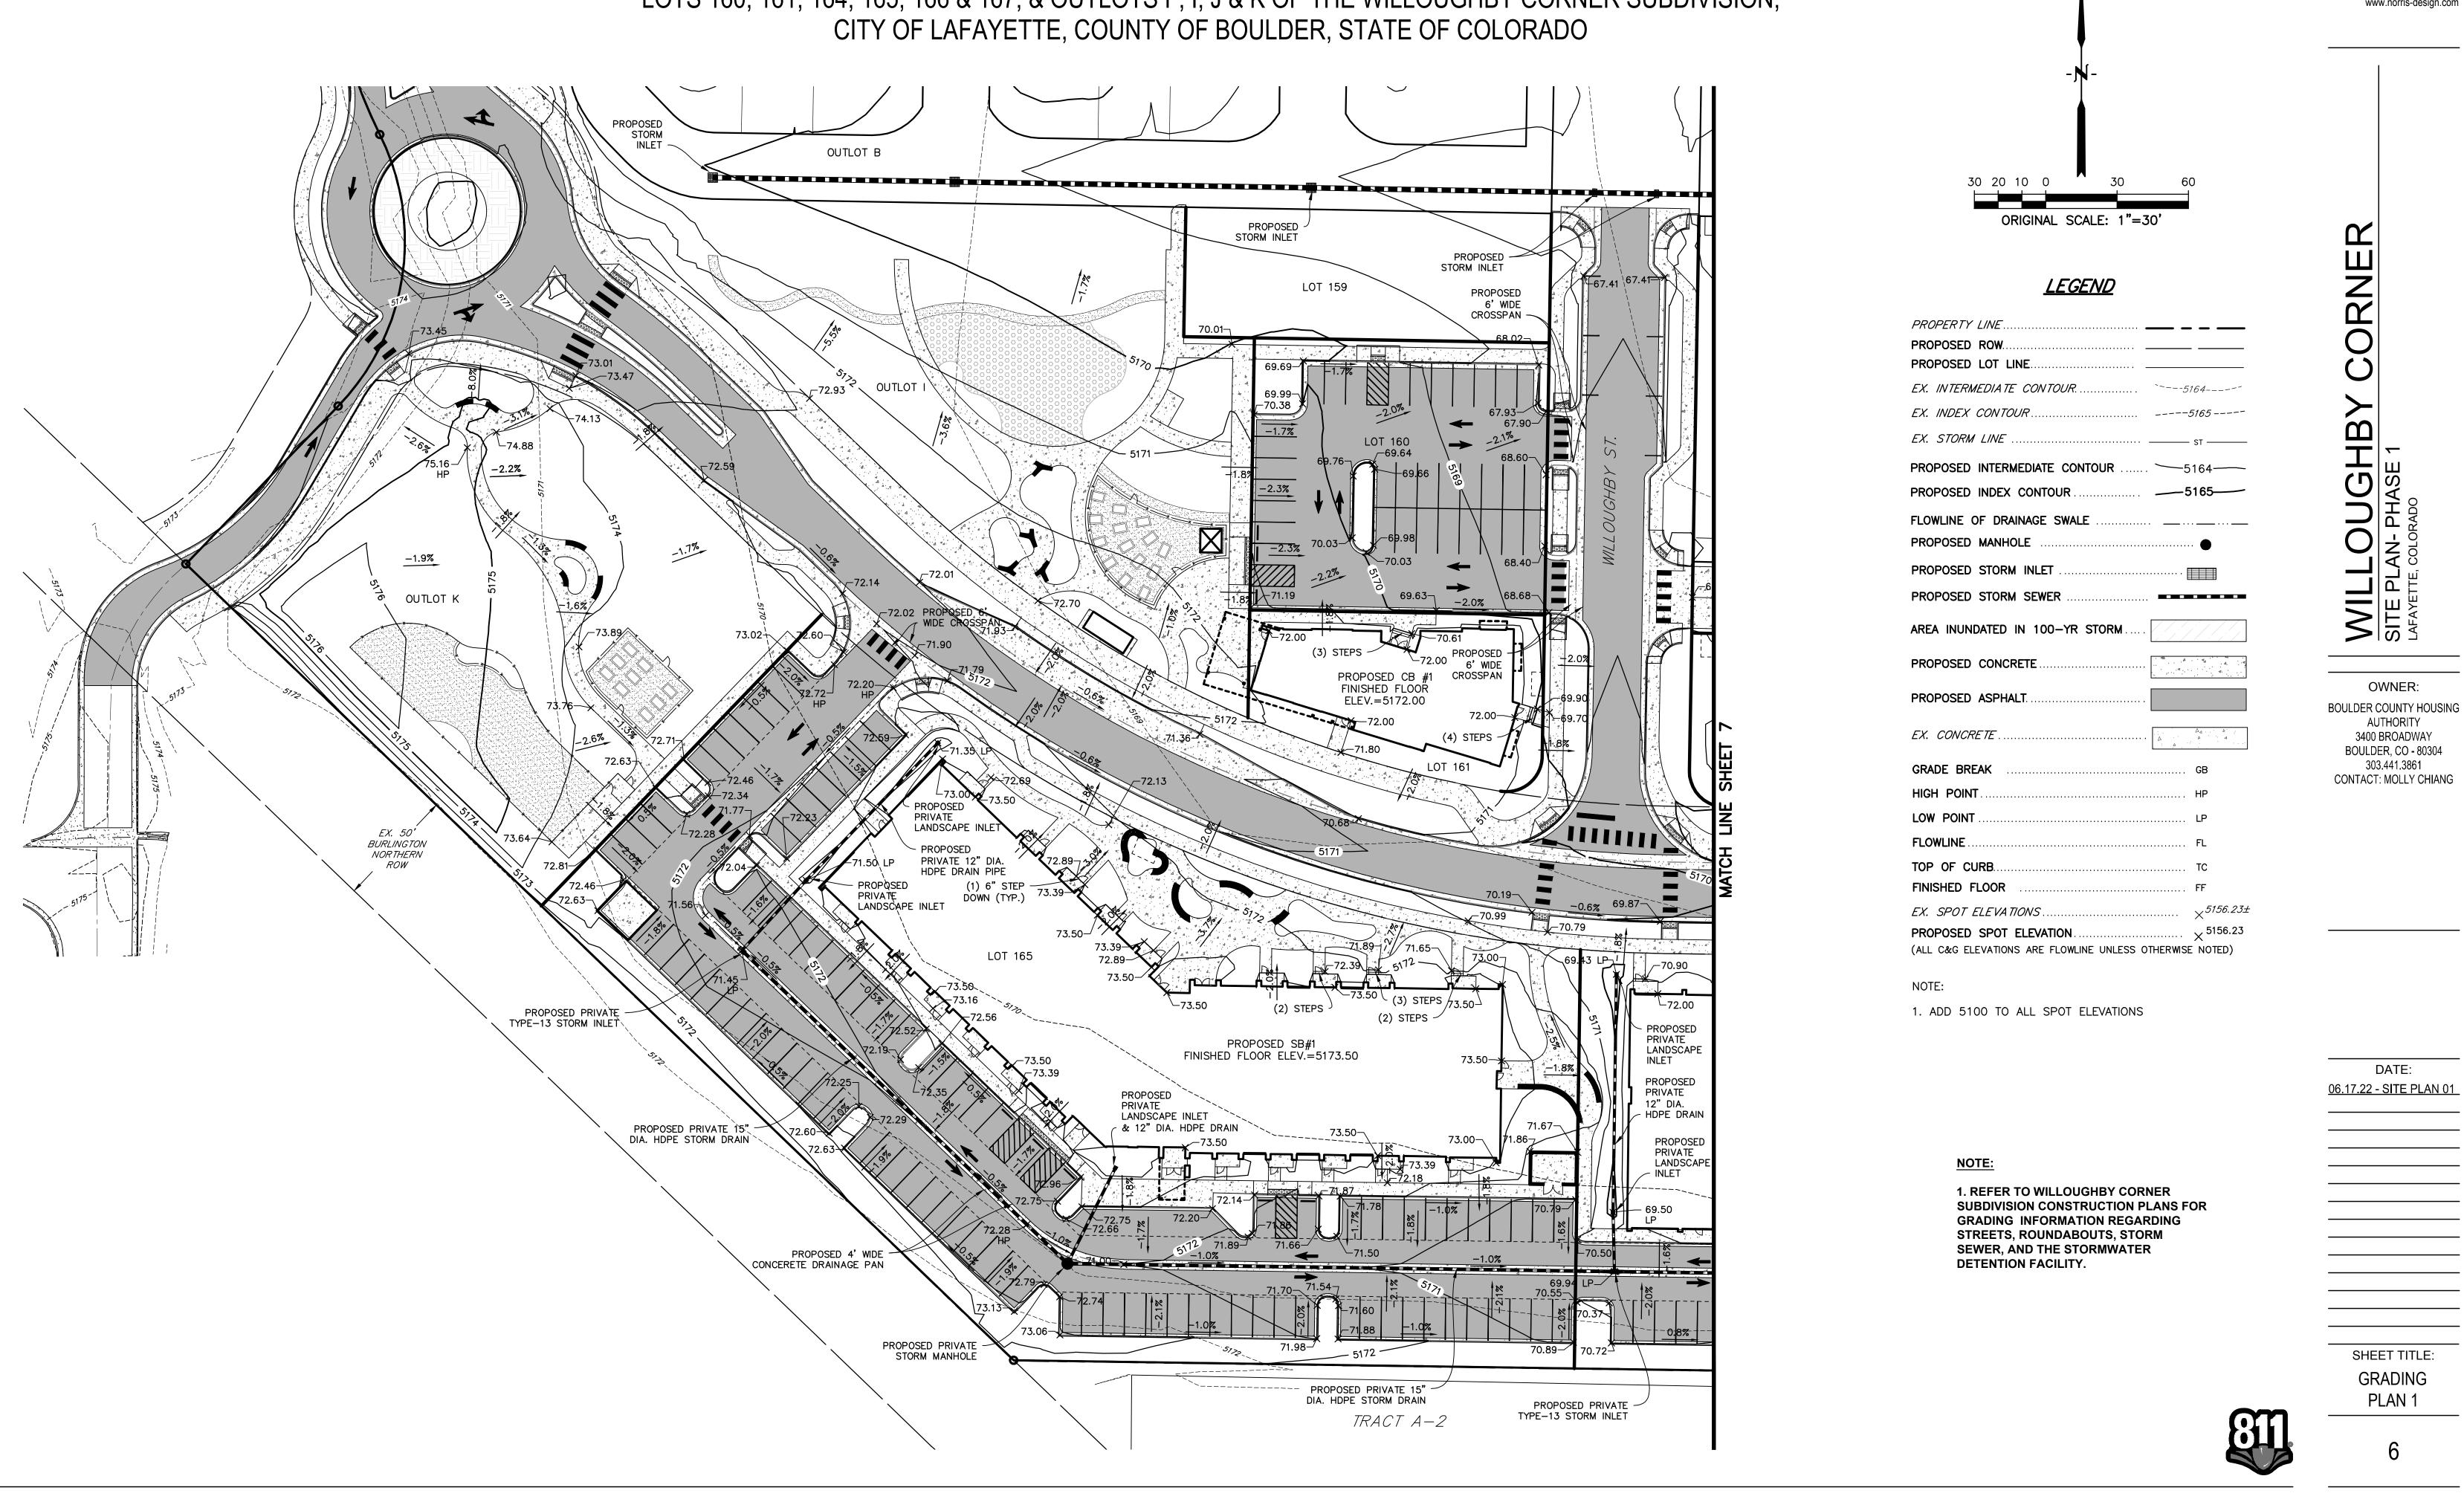


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WILLOUGHBY CORNER SITE PLAN - PHASE 1

LOTS 160, 161, 164, 165, 166 & 167, & OUTLOTS F, I, J & K OF THE WILLOUGHBY CORNER SUBDIVISION,

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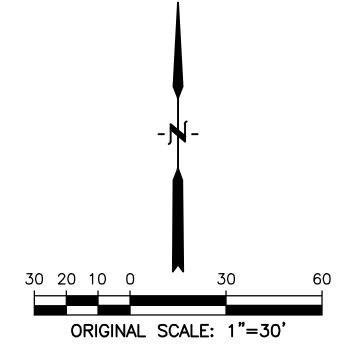
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<u>LEGEND</u>

PROPERTY LINE
PROPOSED ROW
PROPOSED LOT LINE
EX. INTERMEDIATE CONTOUR
EX. INDEX CONTOUR
EX. STORM LINE st st
PROPOSED INTERMEDIATE CONTOUR 5164-5164
PROPOSED INDEX CONTOUR
FLOWLINE OF DRAINAGE SWALE
PROPOSED MANHOLE
PROPOSED STORM INLET
PROPOSED STORM SEWER
AREA INUNDATED IN 100-YR STORM
PROPOSED CONCRETE
PROPOSED ASPHALT
GRADE BREAK GB
HIGH POINT HP
LOW POINT LP
FLOWLINE
TOP OF CURB TC
FINISHED FLOOR
EX. SPOT ELEVATIONS $\times^{5156.23\pm}$
PROPOSED SPOT ELEVATION $\times^{5156.23}$ (ALL C&G ELEVATIONS ARE FLOWLINE UNLESS OTHERWISE NOTED)

NOTE:

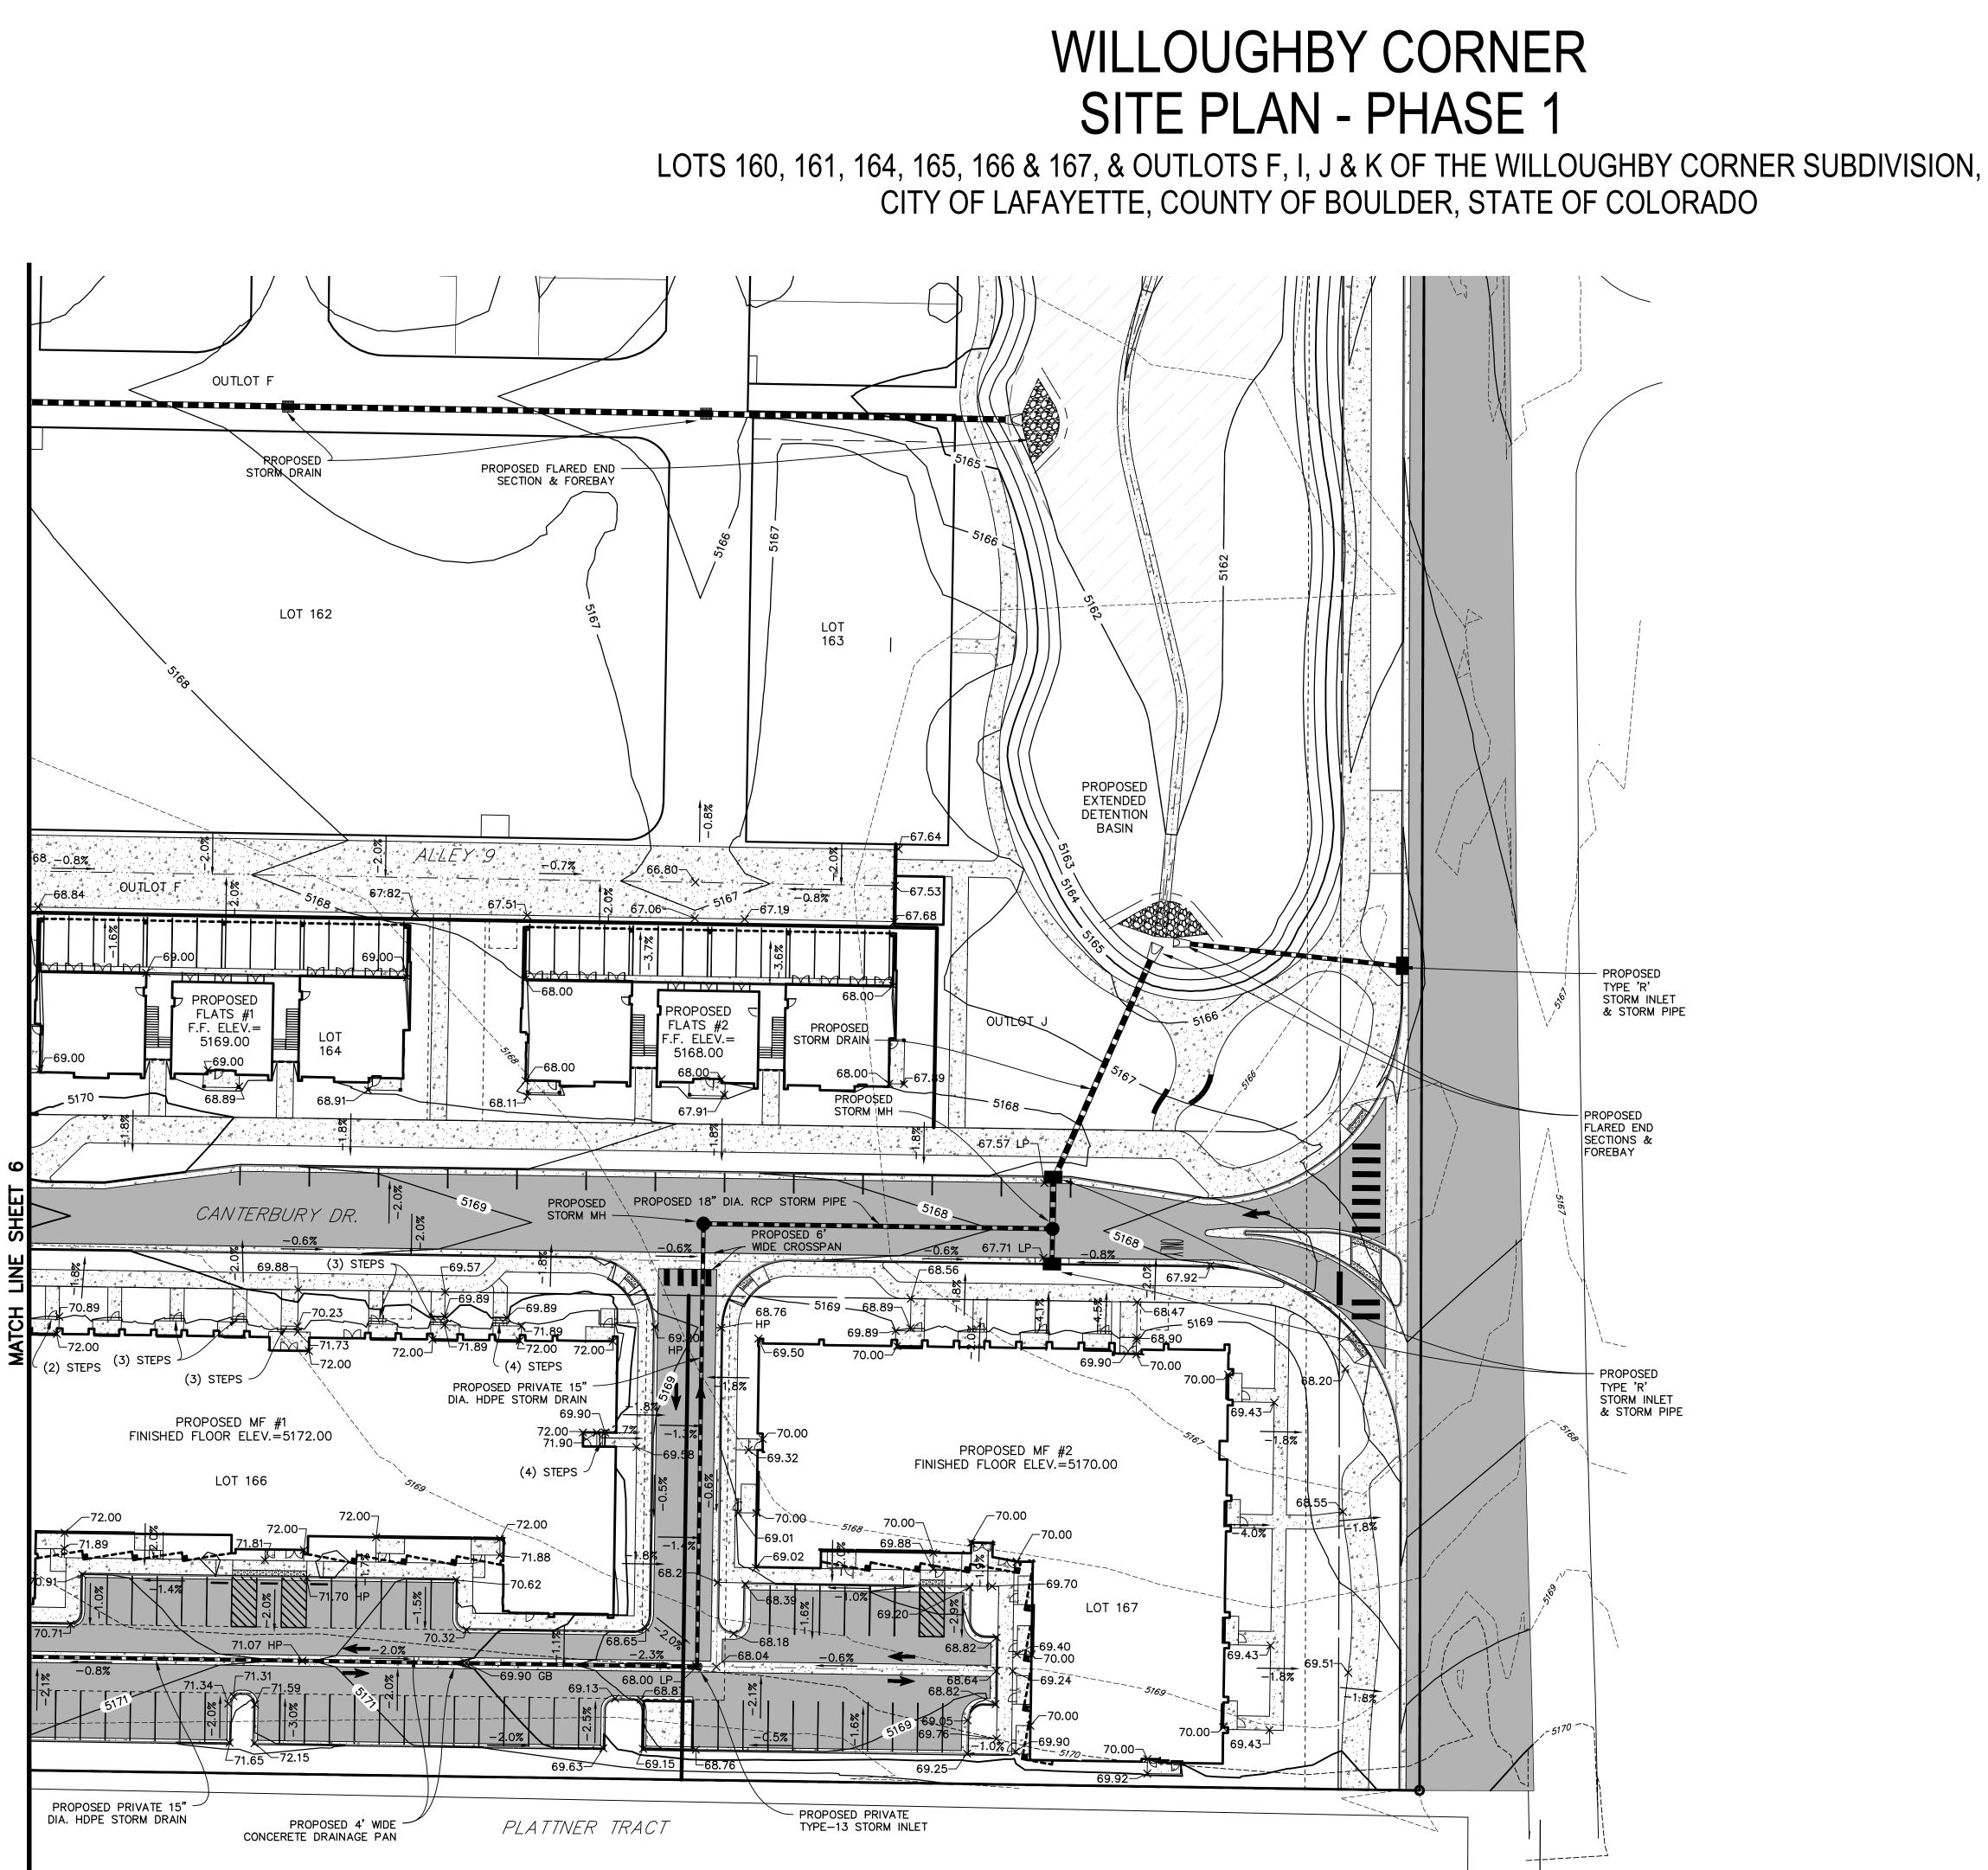1. ADD 5100 TO ALL SPOT ELEVATIONS

NOTE:

1. REFER TO WILLOUGHBY CORNER SUBDIVISION CONSTRUCTION PLANS FOR **GRADING INFORMATION REGARDING** STREETS, ROUNDABOUTS, STORM SEWER, AND THE STORMWATER DETENTION FACILITY.




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DATE:
<u>06.17.22 - SITE PLAN 01</u>
SHEET TITLE:
GRADING




PLAN 2

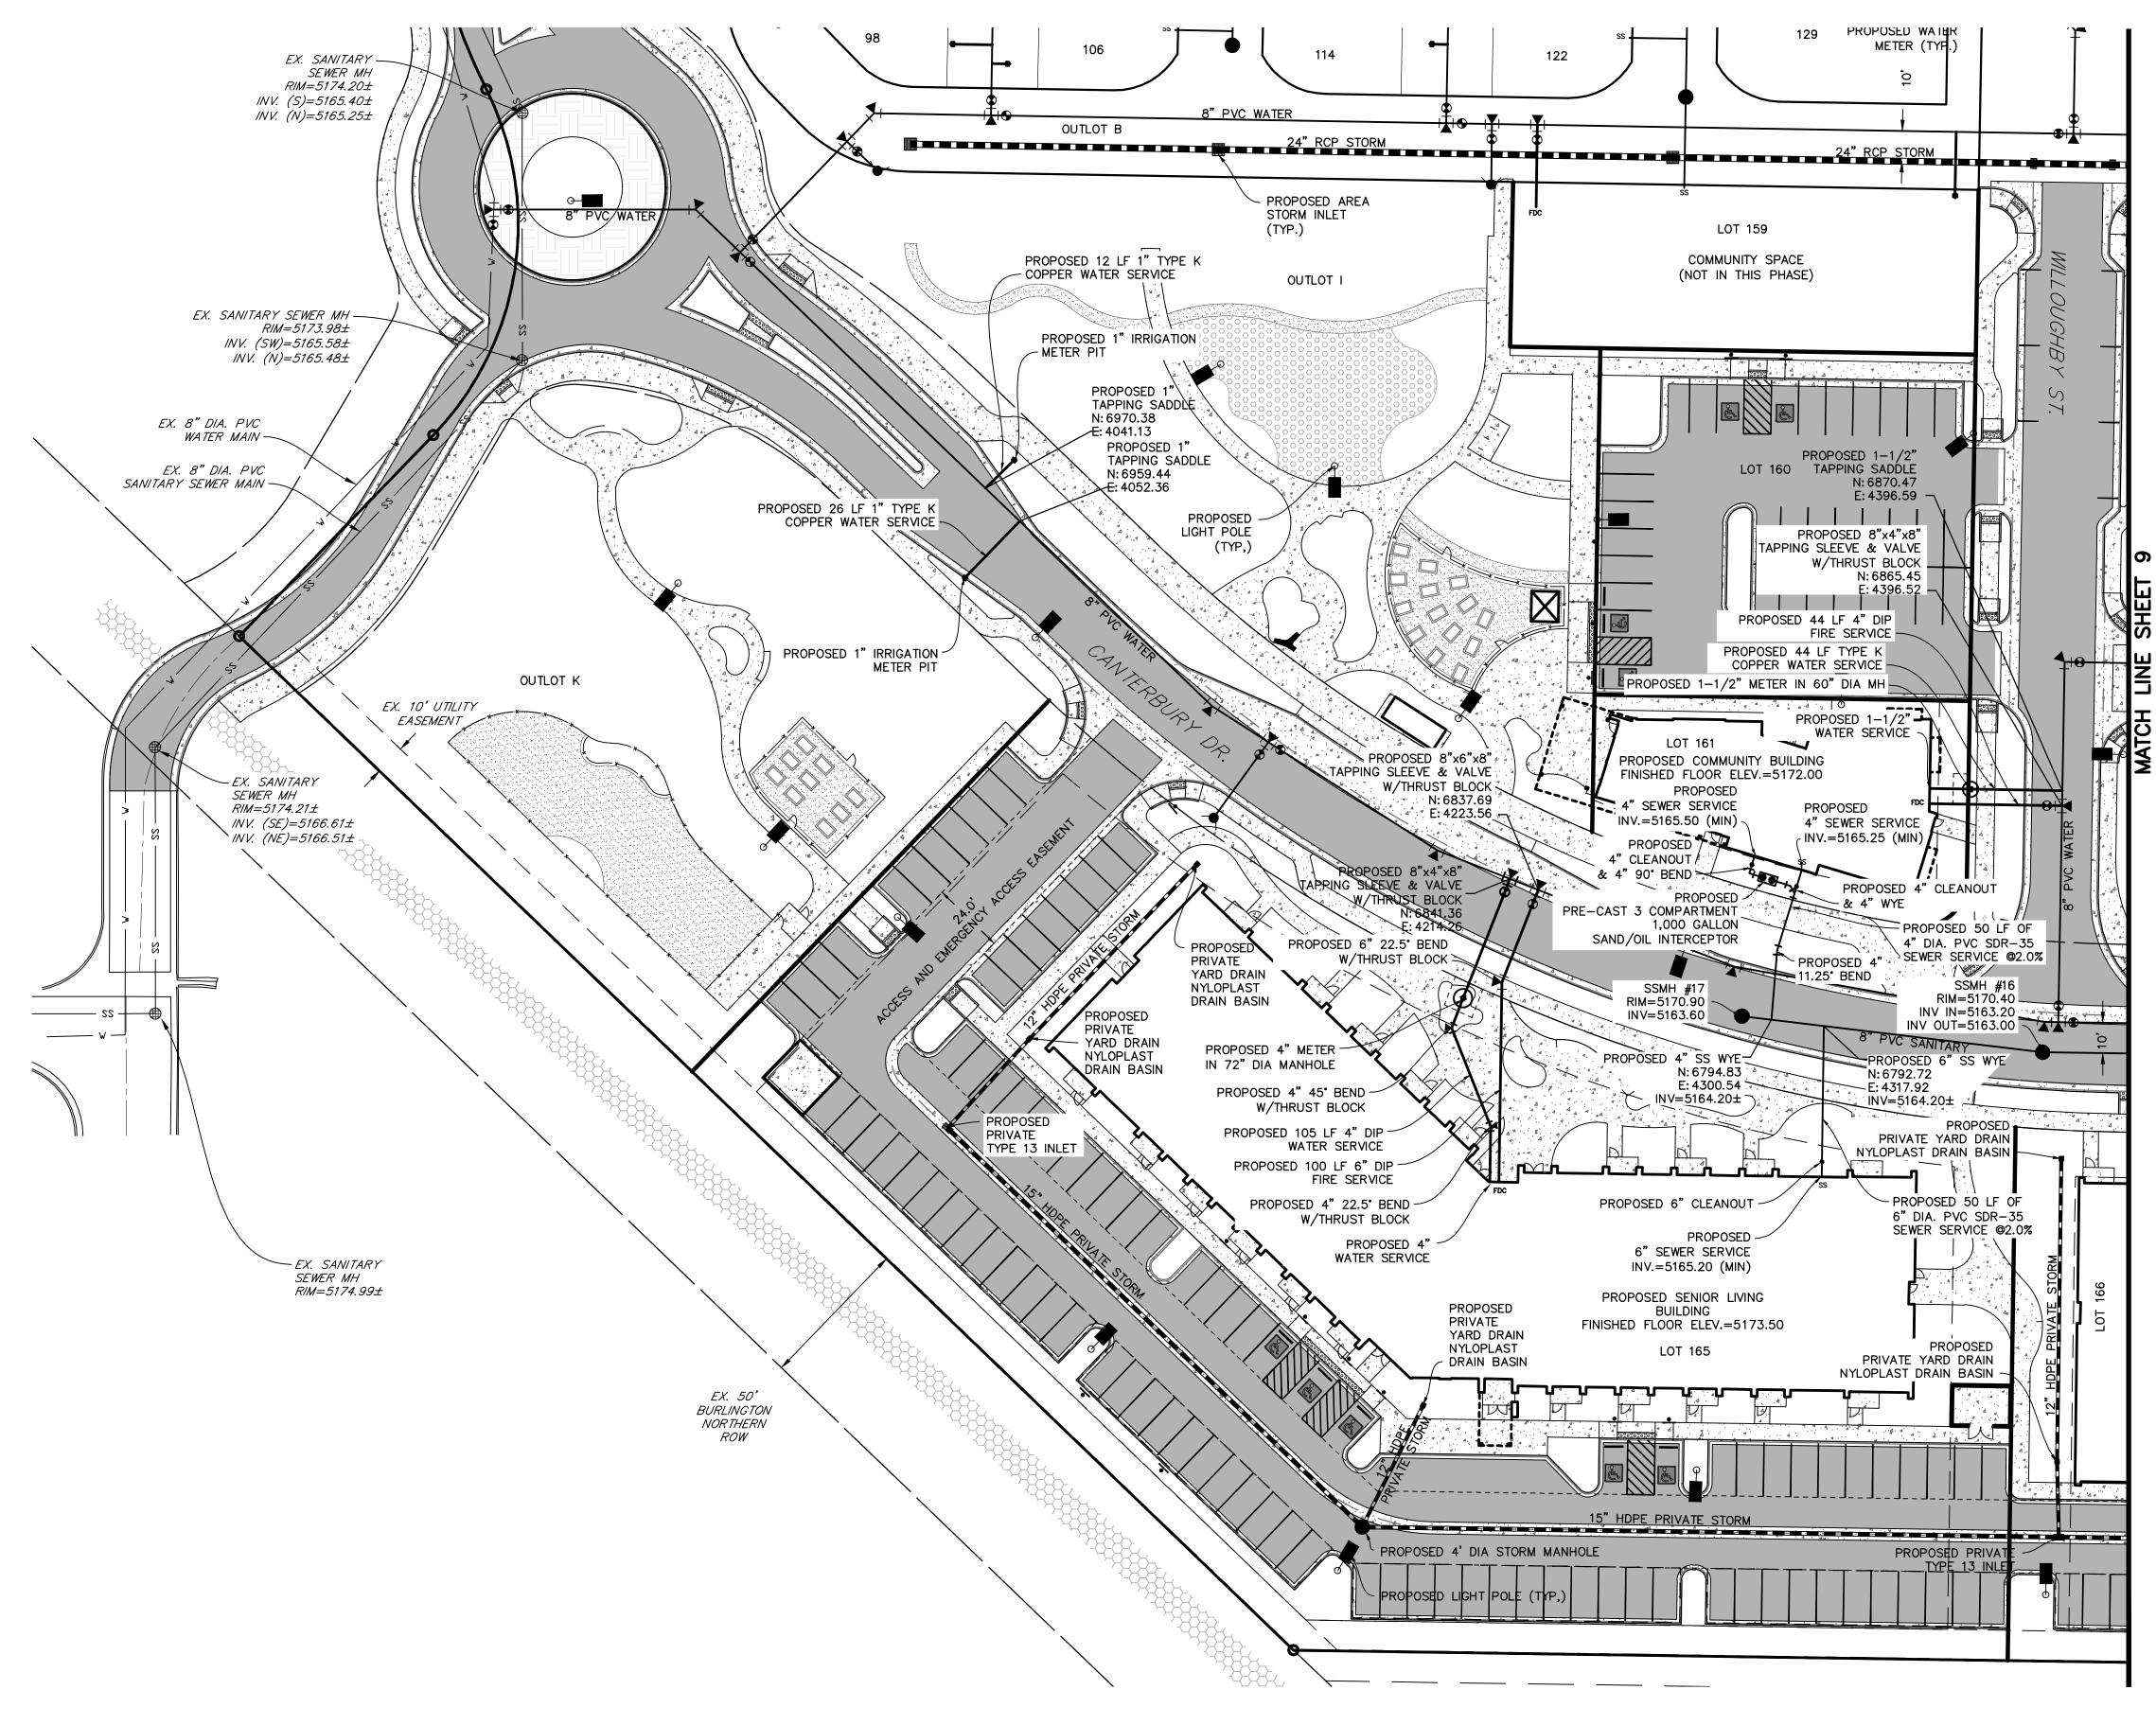

WILLOUGHBY CORNER SITE PLAN - PHASE 1

LOTS 160, 161, 164, 165, 166 & 167, & OUTLOTS F, I, J & K OF THE WILLOUGHBY CORNER SUBDIVISION, CITY OF LAFAYETTE, COUNTY OF BOULDER, STATE OF COLORADO

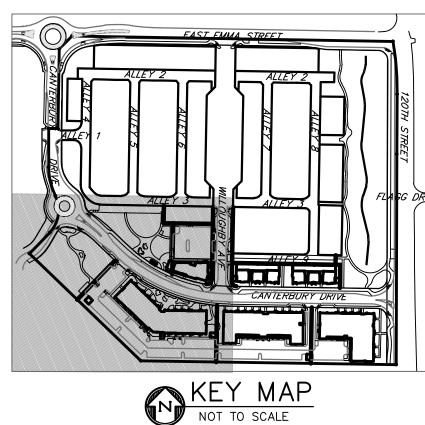



<u>LEGEND</u>

PROPERTY LINE
PROPOSED LOT LINE
EX. SANITARY SEWERssss
<i>EX. WATER LINE</i>
EX. STORM LINE st st
<i>EX. GAS LINE</i>
EX. BURIED ELECTRIC LINE e
EX. OVERHEAD ELECTRIC LINE
<i>EX. CABLE TV</i> ctv ctv
EX. FIRE HYDRANT
EX. WATER VALVE
EX. WATER METER
EX. MANHOLE
EX. LIGHT POLE $lpha$
EX. UTILITY POLE
PROPOSED LIGHT POLE
PROPOSED STORM SEWER
PROPOSED SANITARY SEWER
PROPOSED WATER LINE
PROPOSED FIRE HYDRANT
PROPOSED MANHOLE
PROPOSED STORM INLET
PROPOSED CONCRETE
PROPOSED ASPHALT



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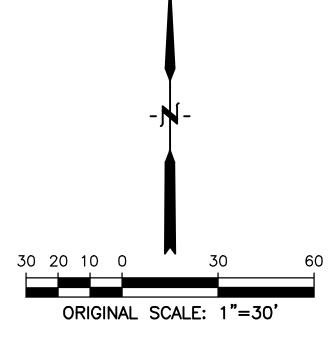
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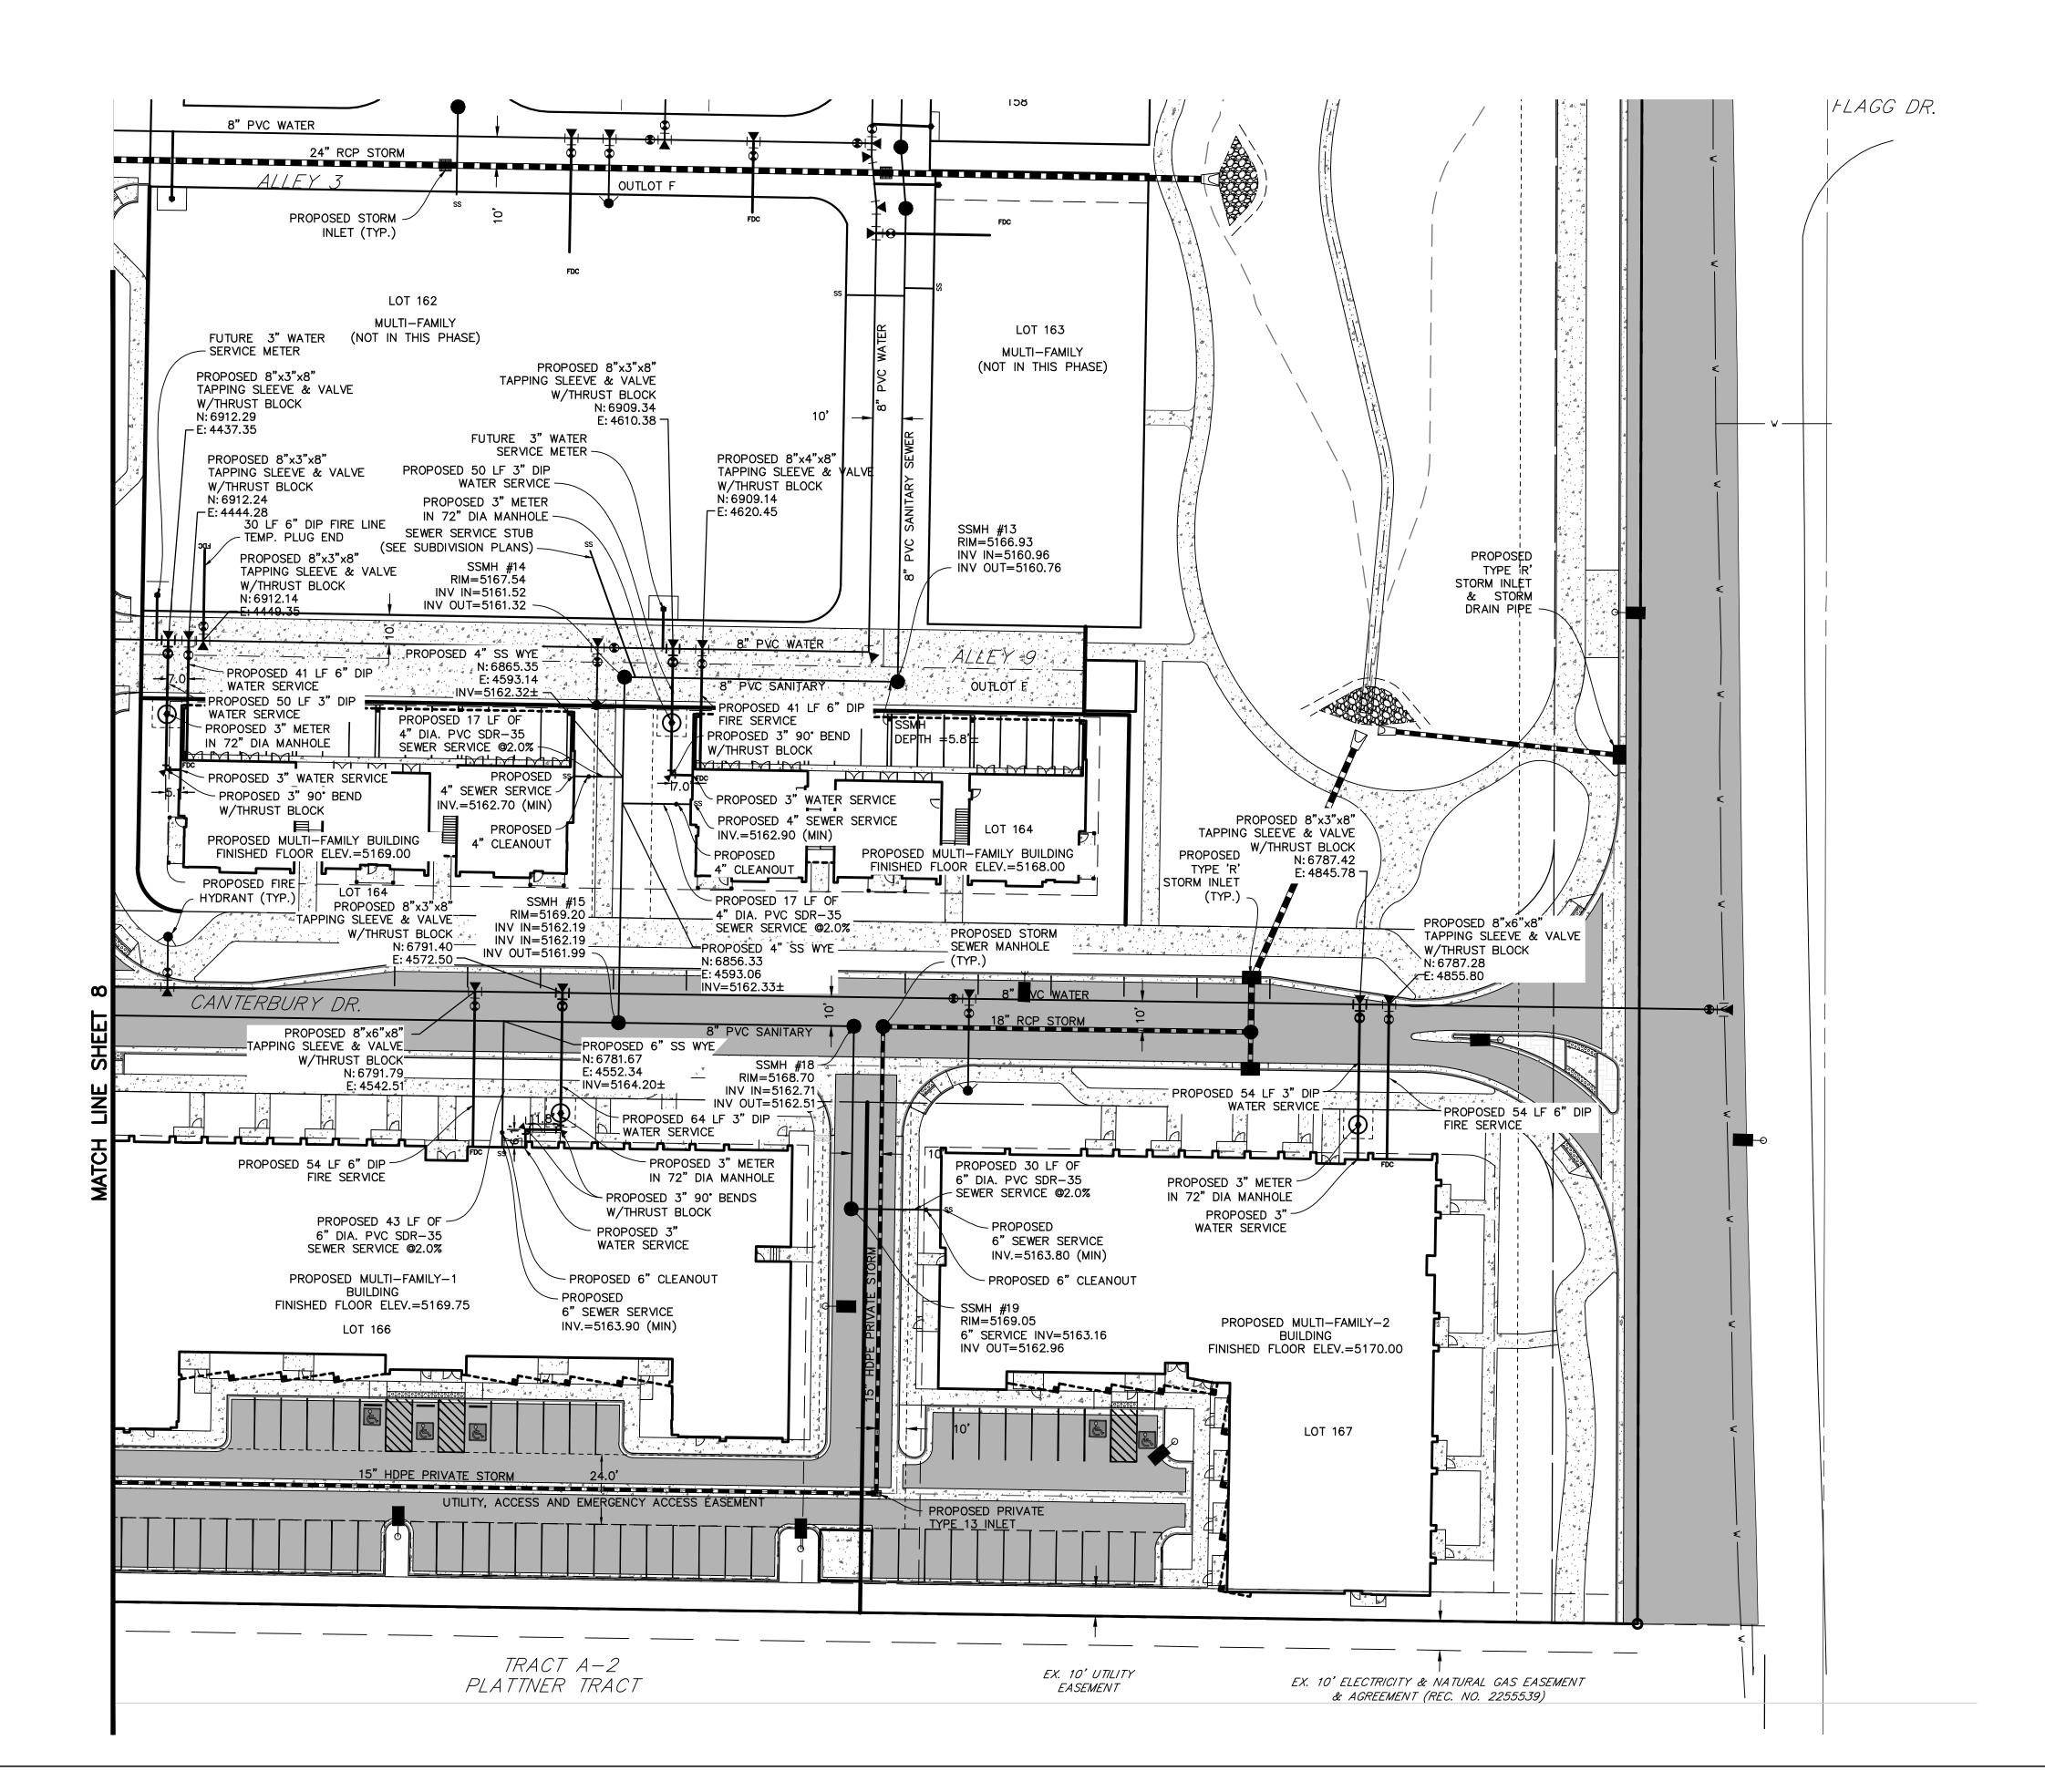


NOTE:

1. ALL STORM, SEWER AND WATER MAINS SHALL BE INSTALLED WITH PHASE 1. **REFER TO WILLOUGHBY CORNER** SUBDIVISION CONSTRUCTION PLANS FOR PLAN & PROFILES, HORIZONTAL LAYOUT, AND CONSTRUCTION LEVEL DETAILS.

DATE: 06.17.22 - SITE PLAN 01 SHEET TITLE: UTILITY PLAN 1






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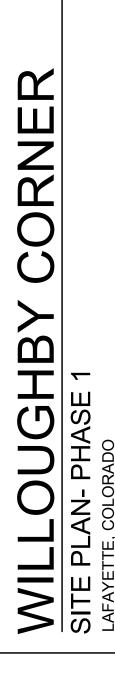
WILLOUGHBY CORNER SITE PLAN - PHASE 1

LOTS 160, 161, 164, 165, 166 & 167, & OUTLOTS F, I, J & K OF THE WILLOUGHBY CORNER SUBDIVISION, CITY OF LAFAYETTE, COUNTY OF BOULDER, STATE OF COLORADO

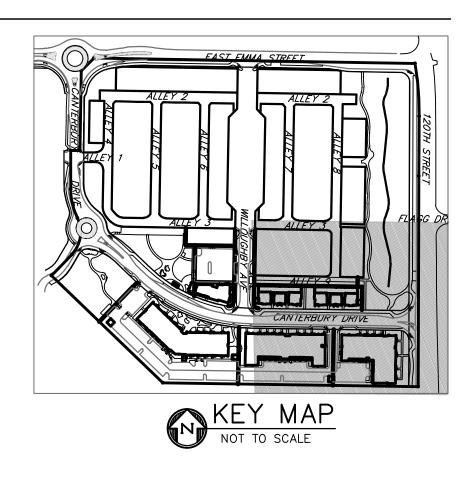

<u>LEGEND</u>

PROPERTY LINE
PROPOSED LOT LINE
EX. SANITARY SEWERssss
<i>EX. WATER LINE</i> w w
EX. STORM LINE st st
<i>EX. GAS LINE</i>
EX. BURIED ELECTRIC LINE E
EX. OVERHEAD ELECTRIC LINE
<i>EX. CABLE TV</i> ctv ctv
EX. FIRE HYDRANT
EX. WATER VALVE
EX. WATER METER
EX. MANHOLE
EX. LIGHT POLE \diamondsuit
EX. UTILITY POLE
PROPOSED LIGHT POLE
PROPOSED STORM SEWER
PROPOSED SANITARY SEWER
PROPOSED WATER LINE
PROPOSED FIRE HYDRANT
PROPOSED WATER VALVE
PROPOSED MANHOLE
PROPOSED STORM INLET
PROPOSED CONCRETE
PROPOSED ASPHALT



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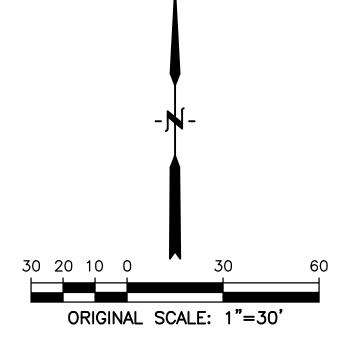
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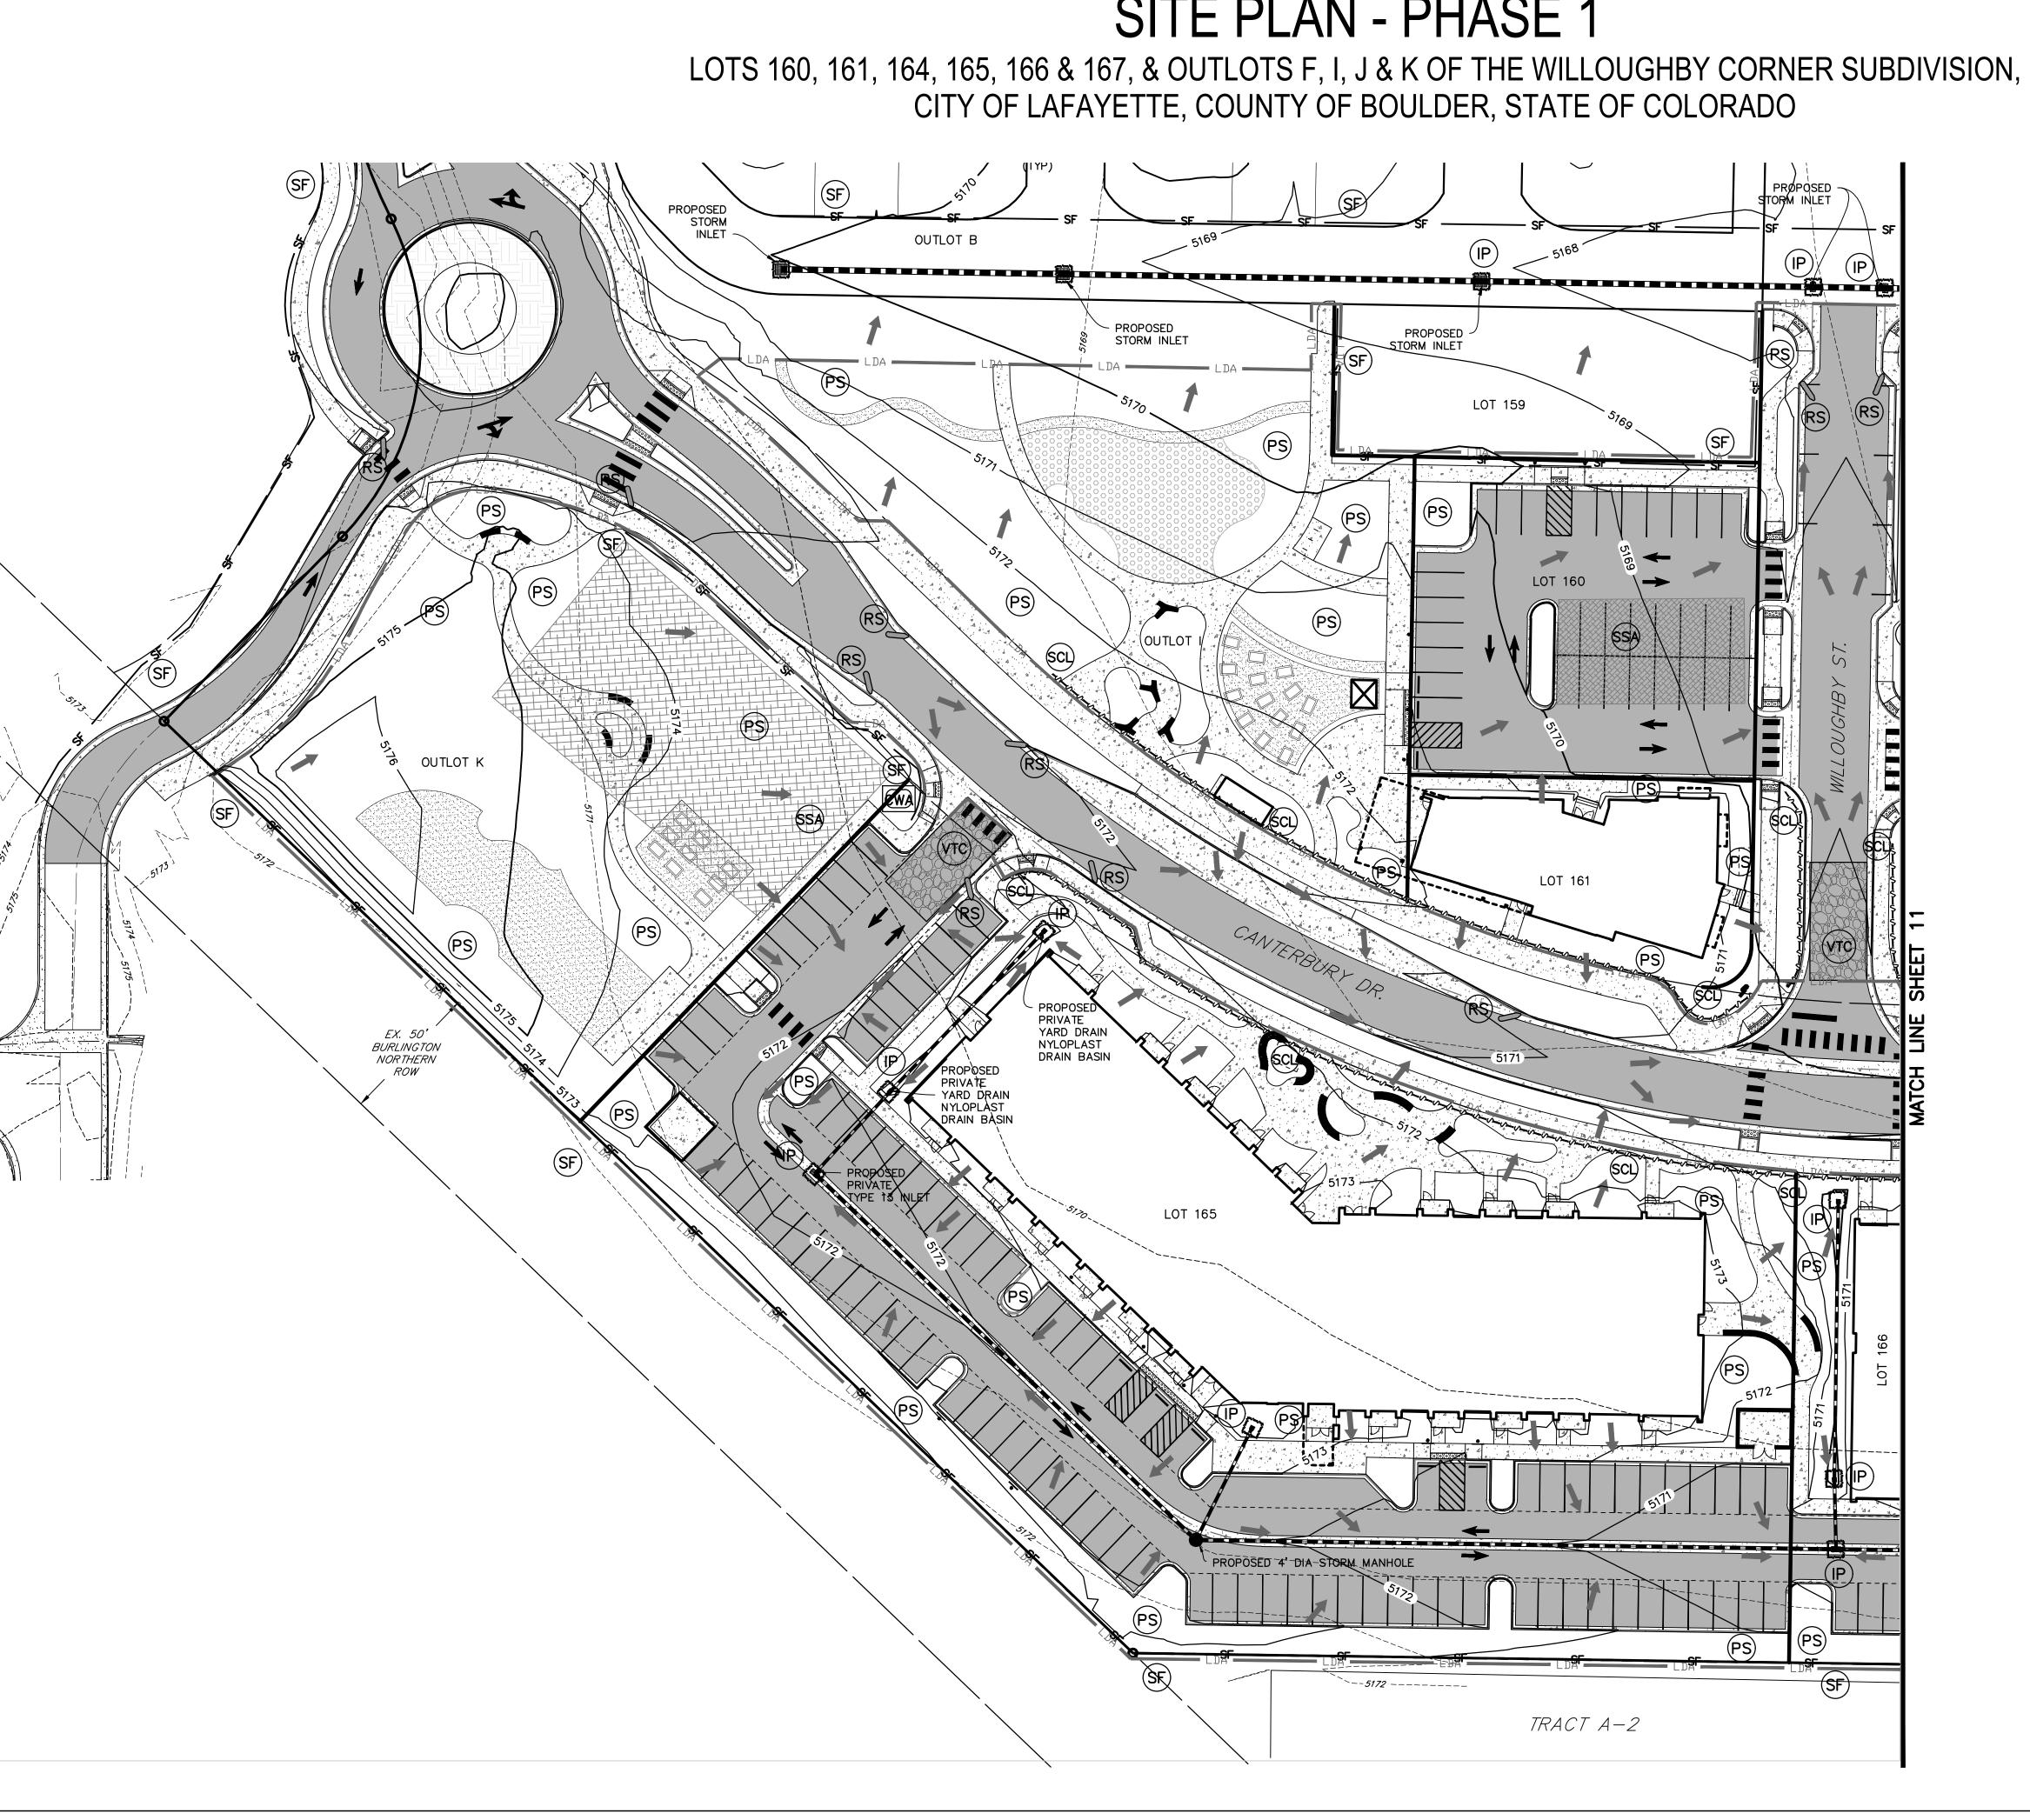
OWNER: BOULDER COUNTY HOUSING AUTHORITY 3400 BROADWAY BOULDER, CO - 80304 303.441.3861 CONTACT: MOLLY CHIANG




NOTE:

1. ALL STORM, SEWER AND WATER MAINS SHALL BE INSTALLED WITH PHASE 1. **REFER TO WILLOUGHBY CORNER** SUBDIVISION CONSTRUCTION PLANS FOR PLAN & PROFILES, HORIZONTAL LAYOUT, AND CONSTRUCTION LEVEL DETAILS.

	DATE:
<u>06.17.2</u>	22 - SITE PLAN 01
S	HEET TITLE:
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	PLAN 2
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WILLOUGHBY CORNER SITE PLAN - PHASE 1



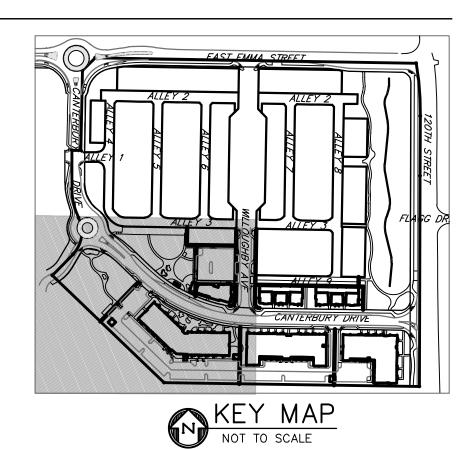


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<u>LEGEND</u>

PROPERTY LINE
EX. INTERMEDIATE CONTOUR
EX. INDEX CONTOUR
PROPOSED INTERMEDIATE CONTOUR 5164-5164-
PROPOSED INDEX CONTOUR
FLOWLINE OF DRAINAGE SWALE
PROPOSED FENCE
PROPOSED CONCRETE
PROPOSED ASPHALT
DIRECTION OF FLOW
LIMITS OF CONSTRUCTION
LIMITS OF DISTURBED AREA
SILT FENCE
STABILIZED STAGING AREA
SEDIMENT CONTROL LOG
ROCK SOCKS
OUTLET PROTECTION
EROSION CONTROL BLANKET
CONCRETE WASHOUT AREA
PERMANENT SEEDING
VEHICLE TRACKING CONTROL PAD



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<u>06.17.22 - SITE PLAN 01</u> SHEET TITLE: EROSION


DATE:

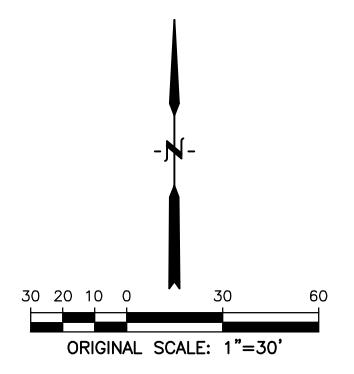NOTE:

1. ALL PUBLIC STORM, SEWER, WATER MAINS SHALL **BE INSTALLED WITH SUBDIVISION IMPROVEMENTS. REFER TO WILLOUGHBY CORNER SUBDIVISION** CONSTRUCTION PLANS FOR SUBDIVISION EROSION CONTROL PLANS.




CONTROL PLAN 1

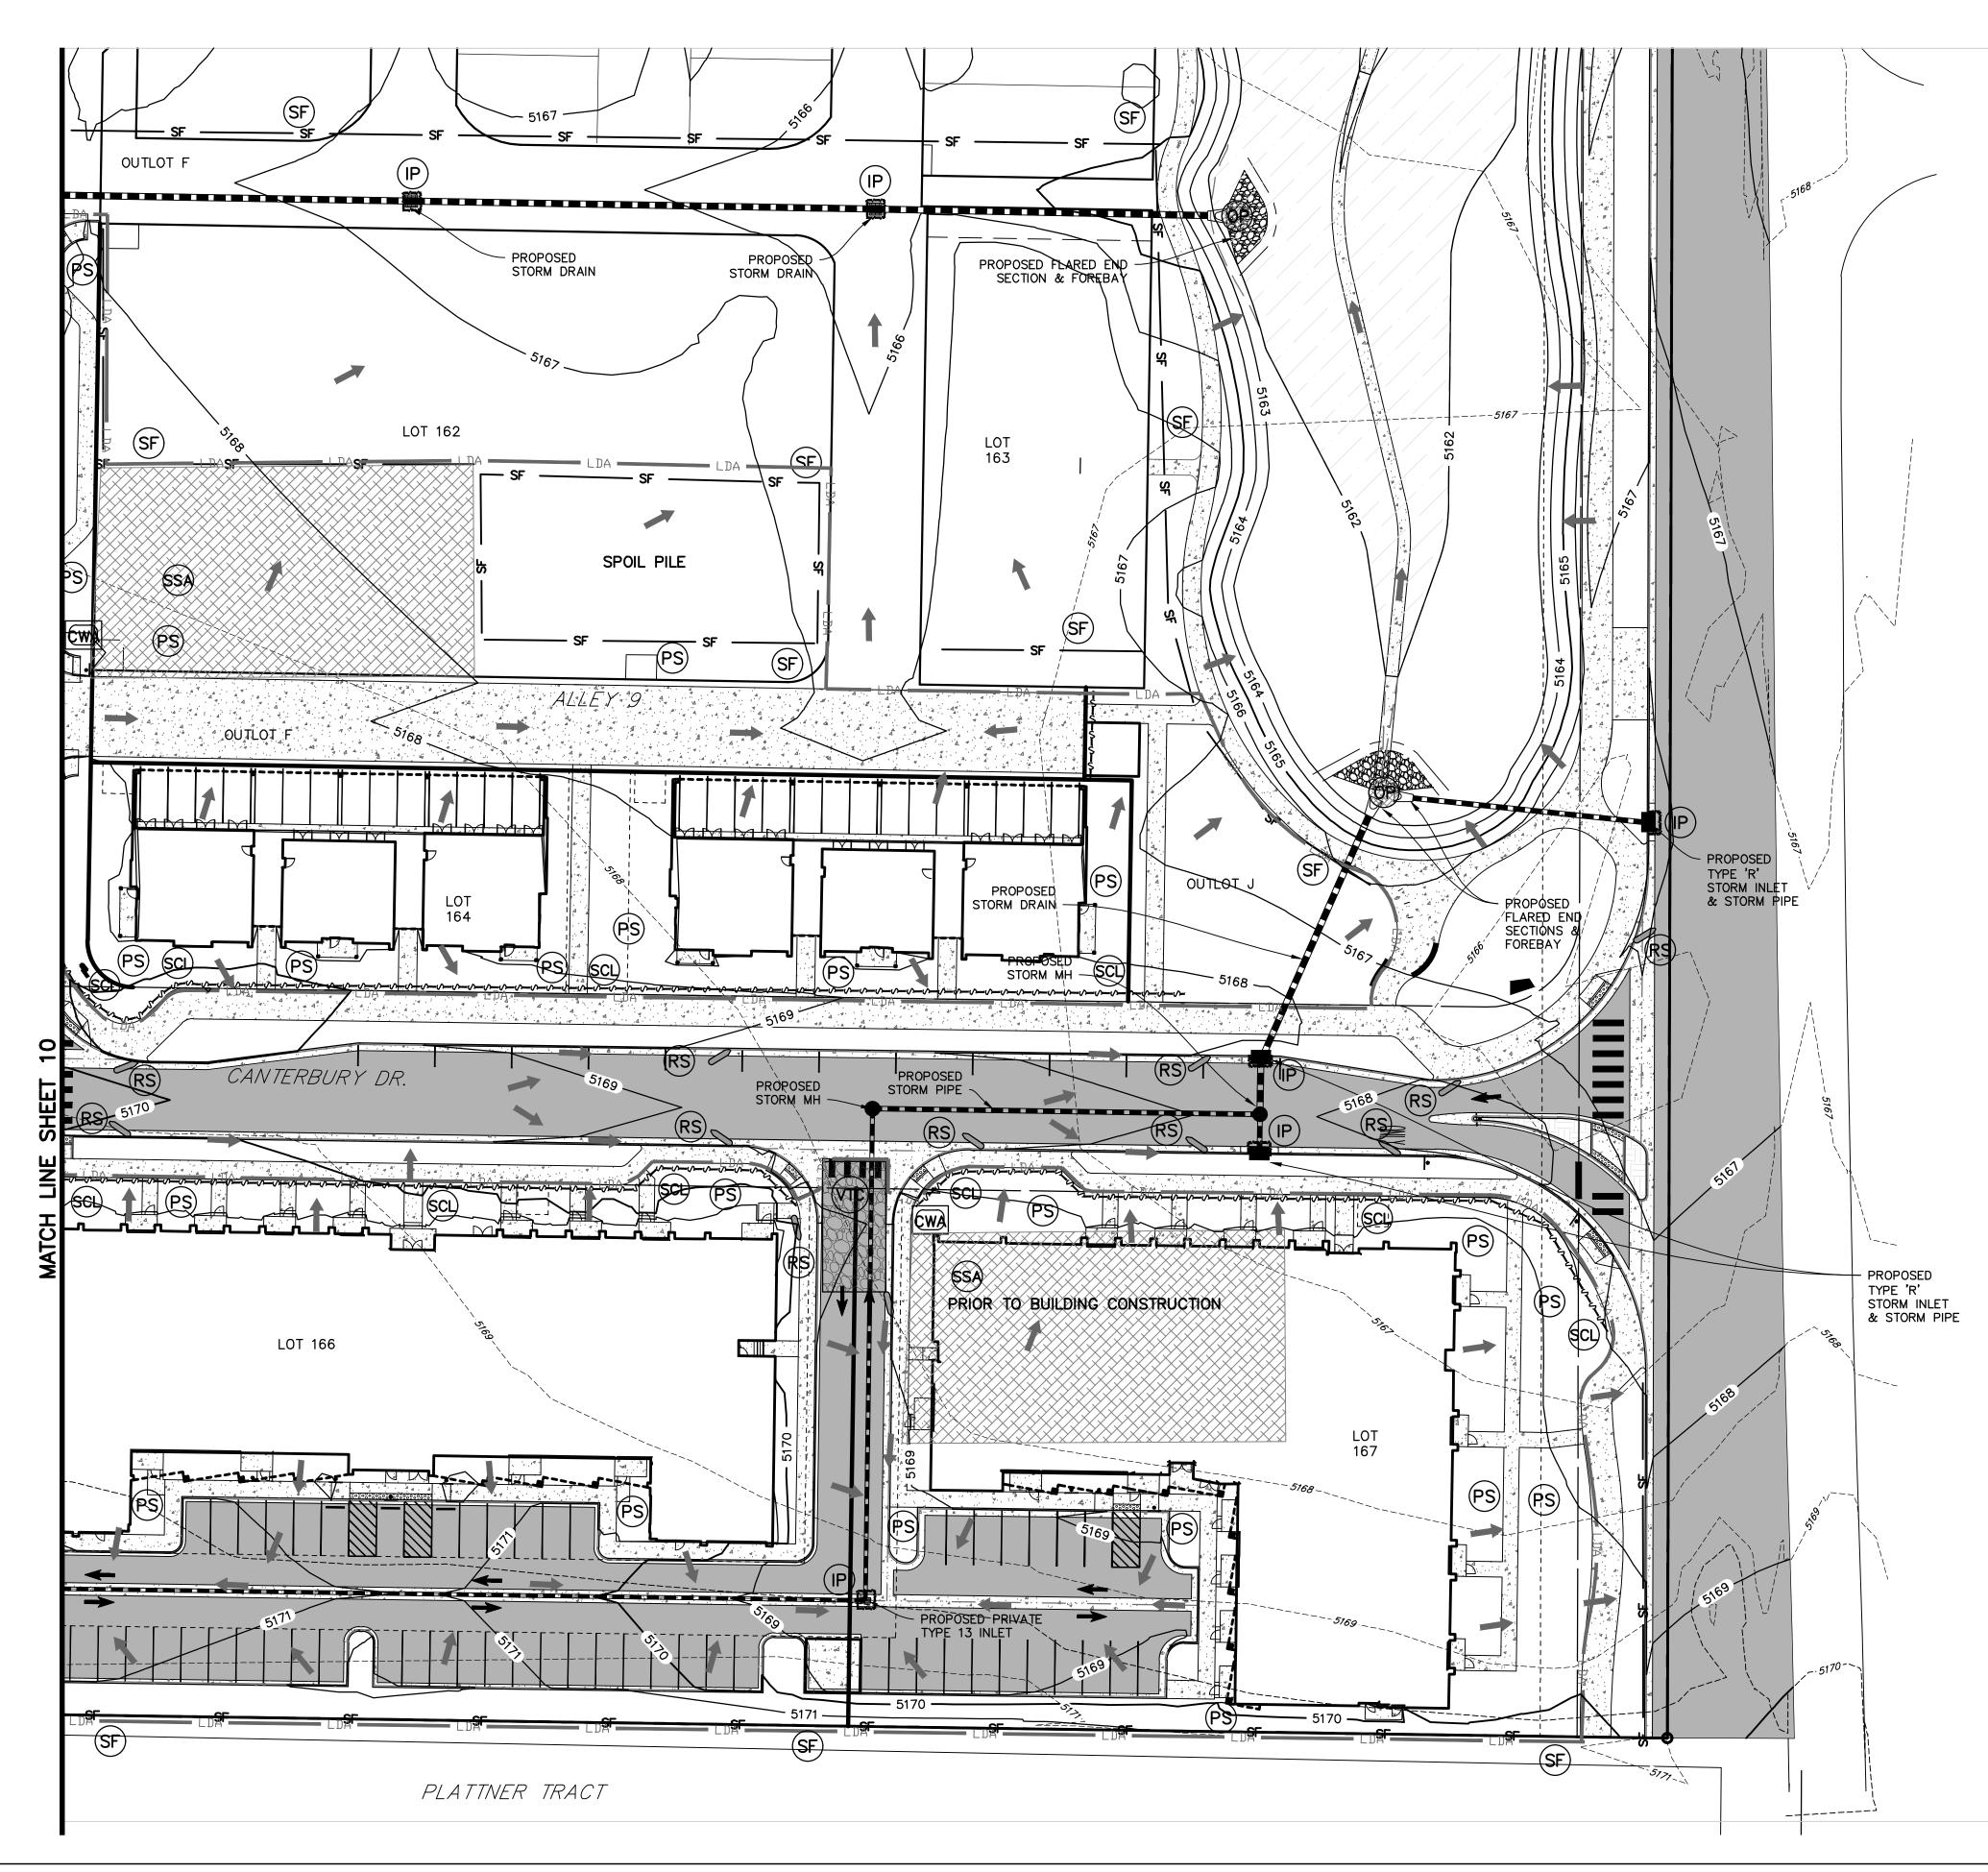

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WILLOUGHBY CORNER SITE PLAN - PHASE 1




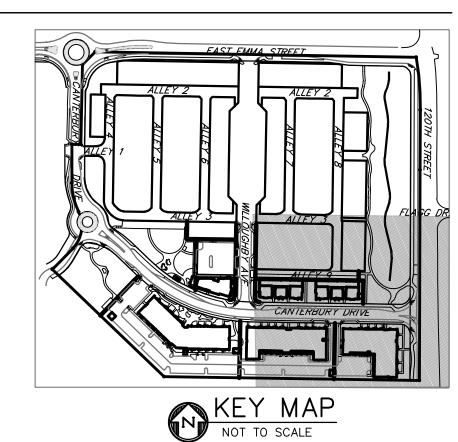

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<u>LEGEND</u>

PROPERTY LINE
EX. INTERMEDIATE CONTOUR
EX. INDEX CONTOUR
PROPOSED INTERMEDIATE CONTOUR 5164-5164
PROPOSED INDEX CONTOUR
FLOWLINE OF DRAINAGE SWALE
PROPOSED FENCE
PROPOSED CONCRETE
PROPOSED ASPHALT
DIRECTION OF FLOW
LIMITS OF CONSTRUCTION
LIMITS OF DISTURBED AREA
SILT FENCE
SILT FENCE SF
SILT FENCE SF
SILT FENCE SF
SILT FENCE
SILT FENCE SF SF SF STABILIZED STAGING AREA SSA SEDIMENT CONTROL LOG SCL
SILT FENCE
SILT FENCESF — SF — SF — STABILIZED STAGING AREASSA SSA SEDIMENT CONTROL LOGSCL ROCK SOCKSRS SCL ROCK SOCKSRS SCL INLET PROTECTION



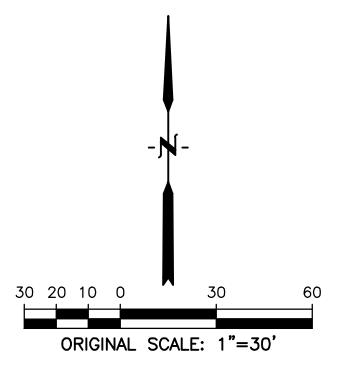

OWNER: BOULDER COUNTY HOUSING AUTHORITY 3400 BROADWAY BOULDER, CO - 80304 303.441.3861 CONTACT: MOLLY CHIANG



EROSION CONTROL PLAN 2

NOTE:

1. ALL PUBLIC STORM, SEWER, WATER MAINS SHALL BE INSTALLED WITH SUBDIVISION IMPROVEMENTS. REFER TO WILLOUGHBY CORNER SUBDIVISION CONSTRUCTION PLANS FOR SUBDIVISION EROSION CONTROL PLANS.



GENERAL NOTES

- 1. THESE PLANS SHALL NOT BE UTILIZED FOR CONSTRUCTION OR PERMITTING UNLESS STATED FOR SUCH USE IN THE TITLE BLOCK
- 2. DRAWINGS ARE INTENDED TO BE PRINTED ON 24" X 36" PAPER. PRINTING THESE DRAWINGS AT A DIFFERENT SIZE WILL IMPACT THE SCALE. VERIFY THE GRAPHIC SCALE BEFORE REFERENCING ANY MEASUREMENTS ON THESE SHEETS. THE RECIPIENT OF THESE DRAWINGS SHALL BE RESPONSIBLE FOR ANY ERRORS RESULTING FROM INCORREC PRINTING, COPYING, OR ANY OTHER CHANGES THAT ALTER THE SCALE OF THE DRAWINGS
- VERIFY ALL PLAN DIMENSIONS PRIOR TO START OF CONSTRUCTION. NOTIFY THE OWNER'S REPRESENTATIVE TO ADDRESS ANY QUESTIONS OR CLARIFY ANY DISCREPANCIES. 4. WRITTEN DIMENSIONS TAKE PRECEDENCE OVER SCALED DIMENSIONS
- SUBMIT A CHANGE ORDER FOR APPROVAL FOR ANY CHANGES TO WORK SCOPE RESULTING FROM FIELD CONDITIONS OR DIRECTION BY OWNER'S REPRESENTATIVE WHICH REQUIRE ADDITIONAL COST TO THE OWNER PRIOR TO PERFORMANCE OF WORK
- 6. THE CONTRACTOR SHALL PROVIDE A STAKED LAYOUT OF ALL SITE IMPROVEMENTS FOR INSPECTION BY THE OWNER'S REPRESENTATIVE AND MAKE MODIFICATIONS AS REQUIRED ALL LAYOUT INFORMATION IS AVAILABLE IN DIGITAL FORMAT FOR USE BY THE CONTRACTOR
- IF A GEOTECHNICAL SOILS REPORT IS NOT AVAILABLE AT THE TIME OF CONSTRUCTION, NORRIS DESIGN RECOMMENDS A REPORT BE AUTHORIZED BY THE OWNER AND THAT ALL RECOMMENDATIONS OF THE REPORT ARE FOLLOWED DURING CONSTRUCTION. THE CONTRACTOR SHALL USE THESE CONTRACT DOCUMENTS AS A BASIS FOR THE BID. IF THE OWNER ELECTS TO PROVIDE A GEOTECHNICAL REPORT, THE CONTRACTOR SHALL REVIEW THE REPORT AND SUBMIT AN APPROPRIATE CHANGE ORDER TO THE OWNER'S REPRESENTATIVE IF ADDITIONAL COSTS ARE REQUESTED
- 8. CONTRACTOR SHALL CONFIRM THAT SITE CONDITIONS ARE SIMILAR TO THE PLANS, WITHIN TOLERANCES STATED IN THE CONTRACT DOCUMENTS. AND SATISFACTORY TO THE CONTRACTOR PRIOR TO START OF WORK. SHOULD SITE CONDITIONS BE DIFFERENT THAN REPRESENTED ON THE PLANS OR UNSATISFACTORY TO THE CONTRACTOR, THE CONTRACTOR SHALL CONTACT THE OWNER'S REPRESENTATIVE FOR CLARIFICATION AND FURTHER DIRECTION
- CONTRACTOR IS RESPONSIBLE TO PAY FOR, AND OBTAIN, ANY REQUIRED APPLICATIONS, PERMITTING, LICENSES, INSPECTIONS AND METERS ASSOCIATED WITH WORK
- 10. THE CONTRACTOR SHALL BE RESPONSIBLE FOR ANY FINES OR PENALTIES ASSESSED TO THE OWNER RELATING TO ANY VIOLATIONS OR NON-CONFORMANCE WITH THE PLANS SPECIFICATIONS, CONTRACT DOCUMENTS, JURISDICTIONAL CODES, AND REGULATORY AGENCIES
- 11. THE CONTRACTOR SHALL BE RESPONSIBLE FOR COORDINATION OF ALL UTILITY LOCATES PRIOR TO ANY EXCAVATION. REFER TO ENGINEERING UTILITY PLANS FOR ALL PROPOSED UTILITY LOCATIONS AND DETAILS. NOTIFY OWNER'S REPRESENTATIVE IF EXISTING OR PROPOSED UTILITIES INTERFERE WITH THE ABILITY TO PERFORM WORK.
- 12. UNLESS IDENTIFIED ON THE PLANS FOR DEMOLITION OR REMOVAL, THE CONTRACTOR IS RESPONSIBLE FOR THE COST TO REPAIR UTILITIES, ADJACENT OR EXISTING LANDSCAPE, ADJACENT OR EXISTING PAVING, OR ANY PUBLIC AND PRIVATE PROPERTY THAT IS DAMAGED BY THE CONTRACTOR OR THEIR SUBCONTRACTOR'S OPERATIONS DURING INSTALLATION. ESTABLISHMENT OR DURING THE SPECIFIED MAINTENANCE PERIOD. ALL DAMAGES SHALL BE REPAIRED TO PRE-CONSTRUCTION CONDITIONS AS DETERMINED BY THE OWNER'S REPRESENTATIVE. CONTRACTOR SHALL BE RESPONSIBLE FOR LOGGING ANY DAMAGES PRIOR TO START OF CONSTRUCTION AND DURING THE CONTRACT PERIOD.
- 13. ALL WORK SHALL BE CONFINED TO THE AREA WITHIN THE CONSTRUCTION LIMITS AS SHOWN ON THE PLANS. ANY AREAS OR IMPROVEMENTS DISTURBED OUTSIDE THESE LIMITS SHALL BE RETURNED TO THEIR ORIGINAL CONDITION AT THE CONTRACTOR'S EXPENSE. IN THE EVENT THE CONTRACTOR REQUIRES A MODIFICATION TO THE CONSTRUCTION LIMITS, WRITTEN PERMISSION MUST BE OBTAINED FROM THE OWNER'S REPRESENTATIVE PRIOR TO ANY DISTURBANCE OUTSIDE OF THE LIMITS OF WORK.
- 14. THE CONTRACTOR SHALL BE RESPONSIBLE FOR THE REPAIR OF ANY OF THEIR TRENCHES OR EXCAVATIONS THAT SETTLE.
- 15. THE CONTRACTOR SHALL BE RESPONSIBLE TO PREPARE AND SUBMIT A TRAFFIC CONTROL PLAN TO THE APPROPRIATE JURISDICTIONAL AGENCIES AND THE OWNER'S REPRESENTATIVE IF THEIR WORK AND OPERATIONS AFFECT OR IMPACT THE PUBLIC RIGHTS-OF-WAY. OBTAIN APPROVAL PRIOR TO ANY WORK WHICH AFFECTS OR IMPACTS THE PUBLIC RIGHTS-OF-WAY. THE CONTRACTOR SHALL BE RESPONSIBLE FOR ANY FINES OR PENALTIES ASSESSED TO THE OWNER RELATING TO THIS REQUIREMENT DURING THE CONTRACT PERIOD.
- 16. SIGHT TRIANGLES AND SIGHT LINES SHALL REMAIN UNOBSTRUCTED BY EQUIPMENT CONSTRUCTION MATERIALS, PLANT MATERIAL OR ANY OTHER VISUAL OBSTACLE DURING THE CONTRACT PERIOD AND AT MATURITY OF PLANTS PER LOCAL JURISDICTIONAL REQUIREMENTS. NO PLANT MATERIAL OTHER THAN GROUND COVER IS ALLOWED TO BE PLANTED ADJACENT TO FIRE HYDRANTS AS STIPULATED BY JURISDICTIONAL REQUIREMENTS. 17. COORDINATE SITE ACCESS, STAGING, STORAGE AND CLEANOUT AREAS WITH OWNER'S
- REPRESENTATIVE. 18. CONTRACTOR IS RESPONSIBLE FOR PROVIDING TEMPORARY SAFETY FENCING AND BARRIERS
- AROUND ALL IMPROVEMENTS SUCH AS WALLS, PLAY STRUCTURES, EXCAVATIONS, ETC. ASSOCIATED WITH THEIR WORK UNTIL SUCH FACILITIES ARE COMPLETELY INSTALLED PER THE PLANS, SPECIFICATIONS AND MANUFACTURER'S RECOMMENDATIONS.
- 19. CONTRACTOR SHALL BE RESPONSIBLE FOR PROTECTION OF THEIR MATERIAL STOCK PILES AND WORK FROM VANDALISM, EROSION OR UNINTENDED DISTURBANCE DURING THE CONSTRUCTION PERIOD AND UNTIL FINAL ACCEPTANCE IS ISSUED.

- 20. THE CONTRACTOR SHALL KNOW, UNDERSTAND AND ABIDE BY ANY STORM WATER POLLUTION PREVENTION PLAN (SWPPP) ASSOCIATED WITH THE SITE. IF A STORM WATER POLLUTION PREVENTION PLAN IS NOT PROVIDED BY THE OWNER'S REPRESENTATIVE, REQUEST A COPY BEFORE PERFORMANCE OF ANY SITE WORK.
- 21. MAINTAIN ANY STORM WATER MANAGEMENT FACILITIES THAT EXIST ON SITE FOR FULL FUNCTIONALITY. THE CONTRACTOR SHALL INSTALL AND MAINTAIN ANY NEW STORM WATER MANAGEMENT FACILITIES THAT ARE IDENTIFIED IN THE SCOPE OF WORK TO FULL FUNCTIONALITY. THE CONTRACTOR SHALL BE RESPONSIBLE FOR ANY FINES OR PENALTIES ASSESSED TO THE OWNER FOR FAILURE TO MAINTAIN STORM WATER MANAGEMENT FACILITIES DURING THE CONTRACT PERIOD.
- 22. THE CONTRACTOR SHALL PREVENT SEDIMENT, DEBRIS AND ALL OTHER POLLUTANTS FROM EXITING THE SITE OR ENTERING THE STORM SEWER SYSTEM DURING ALL DEMOLITION OR CONSTRUCTION OPERATIONS THAT ARE PART OF THIS PROJECT. THE CONTRACTOR SHALL BE RESPONSIBLE FOR ANY FINES OR PENALTIES ASSESSED TO THE OWNER RELATING TO THESE REQUIREMENTS DURING THEIR CONTRACTED COURSE OF WORK.
- 23. THE CONTRACTOR SHALL BE RESPONSIBLE TO PREVENT ANY IMPACTS TO ADJACENT WATERWAYS, WETLANDS, OR OTHER ENVIRONMENTALLY SENSITIVE AREAS RESULTING FROM WORK DONE AS PART OF THIS PROJECT. THE CONTRACTOR SHALL BE RESPONSIBLE FOR ANY FINES OR PENALTIES ASSESSED TO THE OWNER RELATING TO THESE STANDARDS DURING THEIR CONTRACTED COURSE OF WORK.
- 24. THE CONTRACTOR AND/OR THEIR AUTHORIZED AGENTS SHALL INSURE THAT ALL LOADS OF CONSTRUCTION MATERIAL IMPORTED TO OR EXPORTED FROM THE PROJECT SITE SHALL BE PROPERLY COVERED TO PREVENT LOSS OF MATERIAL DURING TRANSPORT TRANSPORTATION METHODS ON PUBLIC RIGHT-OF WAYS SHALL CONFORM TO JURISDICTIONAL REQUIREMENTS. THE CONTRACTOR SHALL BE RESPONSIBLE FOR ANY FINES OR PENALTIES ASSESSED TO THE OWNER RELATING TO THESE REQUIREMENTS
- 25. THE CLEANING OF EQUIPMENT IS PROHIBITED AT THE JOB SITE UNLESS AUTHORIZED BY THE OWNER'S REPRESENTATIVE IN A DESIGNATED AREA. THE DISCHARGE OF WATER, WASTE CONCRETE, POLLUTANTS, OR OTHER MATERIALS SHALL ONLY OCCUR IN AREAS DESIGNED FOR SUCH USE AND APPROVED BY THE OWNER'S REPRESENTATIVE
- 26. THE CLEANING OF CONCRETE EQUIPMENT IS PROHIBITED AT THE JOB SITE EXCEPT IN DESIGNATED CONCRETE WASHOUT AREAS. THE DISCHARGE OF WATER CONTAINING WASTE CONCRETE IN THE STORM SEWER IS PROHIBITED
- 27. OPEN SPACE SWALES: IF SWALES ARE EXISTING ON SITE AND ARE NOT INTENDED TO BE MODIFIED AS PART OF THE PLANS, THE CONTRACTOR SHALL BE RESPONSIBLE TO MAINTAIN THE CONVEYANCE OF WATER WITHIN THE SWALES DURING THE CONTRACT PERIOD. THE CONTRACTOR SHALL BE RESPONSIBLE FOR ANY DIVERSION OR PUMPING OF WATER IF REQUIRED TO COMPLETE WORK. ANY SWALES DISTURBED BY THE CONTRACTOR SHALL BE REPAIRED/RESTORED TO THEIR ORIGINAL CONDITION. IF THE SWALE NEEDS TO BE DISTURBED OR MODIFIED FOR ANY REASON, THE CONTRACTOR SHALL NOTIFY THE OWNER'S REPRESENTATIVE FOR APPROVAL PRIOR TO DISTURBANCE.
- 28. DETENTION AND WATER QUALITY PONDS: IF DETENTION PONDS AND WATER QUALITY PONDS ARE EXISTING ON SITE AND ARE NOT INTENDED TO BE MODIFIED AS PART OF THE PLANS, THE CONTRACTOR SHALL MINIMIZE DISTURBANCE TO THE PONDS, DRAINAGE STRUCTURES AND SPILLWAYS DURING CONSTRUCTION. ALL PONDS, DRAINAGE STRUCTURES AND SPILLWAYS SHALL BE MAINTAINED IN OPERABLE CONDITIONS AT ALL TIMES. ANY POND OR SPILLWAY AREAS DISTURBED BY THE CONTRACTOR SHALL BE REPAIRED/RESTORED TO THEIR ORIGINAL CONDITION. IF THE POND NEEDS TO BE DISTURBED OR MODIFIED FOR ANY REASON, THE CONTRACTOR SHALL NOTIFY THE OWNER'S REPRESENTATIVE FOR APPROVAL PRIOR TO DISTURBANCE.
- 29. MAINTENANCE ACCESS BENCHES: IF MAINTENANCE BENCHES OR ACCESS ROADS EXIST ON SITE AND ARE NOT INTENDED TO BE MODIFIED AS PART OF THE PLANS, THE CONTRACTOR SHALL MINIMIZE DISTURBANCE TO THE BENCHES OR ACCESS ROADS DURING CONSTRUCTION. ANY BENCHES OR ACCESS ROADS DISTURBED BY THE CONTRACTOR SHALL BE REPAIRED/RESTORED TO THEIR ORIGINAL CONDITION. THE CONTRACTOR SHALL MAINTAIN ACCESS TO ALL EXISTING BENCHES AND ACCESS ROADS DURING THE CONSTRUCTION PERIOD. IF ACCESS NEEDS TO BE BLOCKED FOR ANY REASON, THE CONTRACTOR SHALL NOTIFY THE OWNER'S REPRESENTATIVE FOR APPROVAL PRIOR TO INTERRUPTION OF ACCESS.
- 30. LOCAL, STATE AND FEDERAL JURISDICTIONAL REQUIREMENTS, RESTRICTIONS OR PROCEDURES SHALL SUPERSEDE THESE PLANS, NOTES AND SPECIFICATIONS WHEN MORE STRINGENT. NOTIFY THE OWNER'S REPRESENTATIVE IF CONFLICTS OCCUR.

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WILLOUGHBY CORNER SITE PLAN - PHASE 1

LOTS 160, 161, 164, 165, 166 & 167, & OUTLOTS F, I, J & K OF THE WILLOUGHBY CORNER SUBDIVISION, CITY OF LAFAYETTE, COUNTY OF BOULDER, STATE OF COLORADO

LANDSCAPE NOTES

- THE CONTRACTOR SHALL FOLLOW THE LANDSCAPE PLANS AND SPECIFICATIONS AS CLOSELY AS POSSIBLE. ANY SUBSTITUTION OR ALTERATION SHALL NOT BE ALLOWED WITHOUT APPROVAL OF THE OWNER'S REPRESENTATIVE. OVERALL PLANT QUANTITY AND QUALITY SHALL BE CONSISTENT WITH THE PLANS.
- THE CONTRACTOR IS RESPONSIBLE FOR VERIFYING ALL PLANT QUANTITIES. GRAPHIC QUANTITIES TAKES PRECEDENCE OVER WRITTEN QUANTITIES
- THE OWNER'S REPRESENTATIVE RESERVES THE RIGHT TO INSPECT AND TAG ALL PLANT MATERIAL PRIOR TO SHIPPING TO THE SITE. IN ALL CASES, THE OWNER'S REPRESENTATIVE MAY REJECT PLANT MATERIAL AT THE SITE IF MATERIAL IS DAMAGED. DISEASED. OR DECLINING IN HEALTH AT THE TIME OF ONSITE INSPECTIONS OR IF THE PLANT MATERIAI DOES NOT MEET THE MINIMUM SPECIFIED STANDARD IDENTIFIED ON THE PLANS AND IN THE SPECIFICATIONS. THE CONTRACTOR SHALL COORDINATE WITH THE OWNER'S REPRESENTATIVE FOR INSPECTION AND APPROVAL OF ALL MATERIALS AND PRODUCTS PRIOR TO INSTALLATION.
- THE OWNER'S REPRESENTATIVE MAY ELECT TO UPSIZE PLANT MATERIAL AT THEIR DISCRETION BASED ON SELECTION, AVAILABILITY, OR TO ENHANCE SPECIFIC AREAS OF THE PROJECT. THE CONTRACTOR SHALL VERIFY PLANT MATERIAL SIZES WITH OWNER'S REPRESENTATIVE PRIOR TO PURCHASING, SHIPPING OR STOCKING OF PLANT MATERIALS. SUBMIT CHANGE ORDER REQUEST TO OWNER'S REPRESENTATIVE FOR APPROVAL IF ADDITIONAL COST IS REQUESTED BY THE CONTRACTOR PRIOR TO INSTALLATION RE-STOCKING CHARGES WILL NOT BE APPROVED IF THE CONTRACTOR FAILS TO SUBMIT A REQUEST FOR MATERIAL CHANGES
- THE CONTRACTOR SHALL WARRANTY ALL CONTRACTED WORK AND MATERIALS FOR A PERIOD OF ONE YEAR AFTER SUBSTANTIAL COMPLETION HAS BEEN ISSUED BY THE OWNER'S REPRESENTATIVE FOR THE ENTIRE PROJECT UNLESS OTHERWISE SPECIFIED IN THE CONTRACT DOCUMENTS OR SPECIFICATIONS.
- REFER TO IRRIGATION PLANS FOR LIMITS AND TYPES OF IRRIGATION DESIGNED FOR THE LANDSCAPE. IN NO CASE SHALL IRRIGATION BE EMITTED WITHIN THE MINIMUM DISTANCE FROM BUILDING OR WALL FOUNDATIONS AS STIPULATED IN THE GEOTECHNICAL REPORT. ALL IRRIGATION DISTRIBUTION LINES, HEADS AND EMITTERS SHALL BE KEPT OUTSIDE THE MINIMUM DISTANCE AWAY FROM ALL BUILDING AND WALL FOUNDATIONS AS STIPULATED IN THE GEOTECHNICAL REPORT.
- LANDSCAPE MATERIAL LOCATIONS SHALL HAVE PRECEDENCE OVER IRRIGATION MAINLINE AND LATERAL LOCATIONS. COORDINATE INSTALLATION OF IRRIGATION EQUIPMENT SO THAT IT DOES NOT INTERFERE WITH THE PLANTING OF TREES OR OTHER LANDSCAPE MATERIAL
- THE LANDSCAPE CONTRACTOR SHALL BE RESPONSIBLE FOR ENSURING POSITIVE DRAINAGE EXISTS IN ALL LANDSCAPE AREAS. SURFACE DRAINAGE ON LANDSCAPE AREAS SHALL NOT FLOW TOWARD STRUCTURES AND FOUNDATIONS. MAINTAIN SLOPE AWAY FROM FOUNDATIONS PER THE GEOTECHNICAL REPORT RECOMMENDATIONS. ALL LANDSCAPE AREAS BETWEEN WALKS AND CURBS SHALL DRAIN FREELY TO THE CURB UNLESS OTHERWISE IDENTIFIED ON THE GRADING PLAN. IN NO CASE SHALL THE GRADE, TURF THATCH. OR OTHER LANDSCAPE MATERIALS DAM WATER AGAINST WALKS. MINIMUM SLOPES ON LANDSCAPE AREAS SHALL BE 2%; MAXIMUM SLOPE SHALL BE 25% UNLESS SPECIFICALLY IDENTIFIED ON THE PLANS OR APPROVED BY THE OWNER'S REPRESENTATIVE.
- PRIOR TO INSTALLATION OF PLANT MATERIALS, AREAS THAT HAVE BEEN COMPACTED OR DISTURBED BY CONSTRUCTION ACTIVITY SHALL BE THOROUGHLY LOOSENED TO A DEPTH OF 8" - 12" AND AMENDED PER SPECIFICATIONS.
- 10. ALL LANDSCAPED AREAS ARE TO RECEIVE ORGANIC SOIL PREPARATION AT 4 cu.yrds/1,000sf OR AS NOTED IN THE TECHNICAL SPECIFICATIONS.
- 11. TREES SHALL NOT BE LOCATED IN DRAINAGE SWALES, DRAINAGE AREAS, OR UTILITY EASEMENTS. CONTACT OWNER'S REPRESENTATIVE FOR RELOCATION OF PLANTS IN QUESTIONABLE AREAS PRIOR TO INSTALLATION.
- 12. THE CENTER OF EVERGREEN TREES SHALL NOT BE PLACED CLOSER THAN 8' AND THE CENTER OF ORNAMENTAL TREES CLOSER THAN 6' FROM A SIDEWALK, STREET OR DRIVE LANE. EVERGREEN TREES SHALL NOT BE LOCATED ANY CLOSER THAN 15' FROM IRRIGATION ROTOR HEADS. NOTIFY OWNER'S REPRESENTATIVE IF TREE LOCATIONS CONFLICT WITH THESE STANDARDS FOR FURTHER DIRECTION.
- 13. ALL EVERGREEN TREES SHALL BE FULLY BRANCHED TO THE GROUND AND SHALL NOT EXHIBIT SIGNS OF ACCELERATED GROWTH AS DETERMINED BY THE OWNER'S REPRESENTATIVE.
- 14. ALL TREES ARE TO BE STAKED AND GUYED PER DETAILS FOR A PERIOD OF 1 YEAR. THE CONTRACTOR SHALL BE RESPONSIBLE FOR REMOVING STAKES AT THE END OF 1 YEAR FROM ACCEPTANCE OF LANDSCAPE INSTALLATION BY THE OWNER'S REPRESENTATIVE. OBTAIN APPROVAL BY OWNER'S REPRESENTATIVE PRIOR TO REMOVAL
- 15. ALL TREES INSTALLED ABOVE RETAINING WALLS UTILIZING GEO-GRID MUST BE HAND DUG TO PROTECT GEO-GRID. IF GEO-GRID MUST BE CUT TO INSTALL TREES, APPROVAL MUST BE GIVEN BY OWNER'S REPRESENTATIVE PRIOR TO DOING WORK.
- 16. TREE WRAP SHALL BE APPLIED IN LATE FALL AFTER INSTALLATION AND REMOVED THE FOLLOWING SPRING. TREES GREATER THEN 4" IN CALIPER MAY NOT REQUIRE TREE WRAP

	IF BARK IS S
17.	REPRESENT ALL TREES FROM OWN
18.	EXCESSIVE SHRUB, GRO GREEN, ROI
19.	REQUIRED V PRE-MULCH UNLESS SPI IN ALL CASE WALL FOUN TYPE PERFO FLOW OF DI
20.	ADJACENT GRADE. ED ON THE PLA ALL SHRUB MULCH OVE LOCATIONS 3" DEPTH 1-
21.	PERENNIAL AT SEED AF NATIVE ARE
22.	CONTRACT
23.	ROADS WIT ALL SEEDEI BLANKETS.
24.	LOCATION A WHEN COM ON THE PLA
25.	SOFT SURF
26.	WITH 4" x 14 THE DEVELO INSTALLATIO INDICATED
LAN	IDSCAPE
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SUFFICIENTLY DEVELOPED. OBTAIN APPROVAL FROM OWNER'S ITATIVE FOR ANY TREES THAT WILL NOT BE WRAPPED.

S IN SEED OR TURF AREAS SHALL RECEIVE MULCH RINGS. OBTAIN APPROVAI IER'S REPRESENTATIVE FOR ANY TREES THAT WILL NOT BE MULCHED FOR E MOISTURE REASONS

OUNDCOVER AND PERENNIAL BEDS ARE TO BE CONTAINED BY 4" x 14 GAUGE ILL TOP, INTERLOCKING TYPE EDGER, RYERSON OR EQUAL. EDGER IS NOT WHEN ADJACENT TO CURBS, WALLS, WALKS OR SOLID FENCES WITHIN 3" OF HED FINAL GRADE. EDGER SHALL NOT BE REQUIRED TO SEPARATE MULCH TYPES PECIFIED ON THE PLANS.

ES SHRUB, GROUNDCOVER AND PERENNIAL BEDS ADJACENT TO BUILDING AND NDATIONS SHALL BE CONTAINED BY 14 GAUGE GREEN, ROLL TOP, INTERLOCKING ORATED EDGER, RYERSON OR EQUAL. EDGER SHALL NOT RESTRICT THE FREE RAINAGE OR DAM WATER IN ANY CASE. EDGER IS NOT REQUIRED WHEN TO CURBS, WALLS, WALKS OR SOLID FENCES WITHIN 3" OF PRE-MULCHED FINAL DGER SHALL NOT BE REQUIRED TO SEPARATE MULCH TYPES UNLESS SPECIFIED

3 BEDS ARE TO BE MULCHED WITH MIN. 3" DEPTH, 1-2" ROCK MULCH OR 4-6" ROCK ER SPECIFIED GEOTEXTILE WEED CONTROL FABRIC. REFER TO PLANS FOR . ALL GROUND COVER AND PERENNIAL FLOWER BEDS SHALL BE MULCHED WITH -2" ROCK MULCH. NO WEED CONTROL FABRIC IS REQUIRED IN GROUNDCOVER OR AREAS.

REA BOUNDARIES ADJACENT TO EXISTING NATIVE AREAS, OVERLAP ABUTTING EAS BY THE FULL WIDTH OF THE SEEDER.

FOR SHALL OVER SEED ALL MAINTENANCE OR SERVICE ACCESS BENCHES AND TH SPECIFIED SEED MIX UNLESS OTHERWISE NOTED ON THE PLANS.

ED SLOPES EXCEEDING 25% IN GRADE (4:1) SHALL RECEIVE EROSION CONTROL . PRIOR TO INSTALLATION, NOTIFY OWNER'S REPRESENTATIVE FOR APPROVAL OF AND ANY ADDITIONAL COST IF A CHANGE ORDER IS NECESSARY IPLETE, ALL GRADES SHALL BE WITHIN +/- 1/8" OF FINISHED GRADES AS SHOWN

ACE TRAILS NEXT TO MANICURED TURF OR SHRUB BEDS SHALL BE CONTAINED

4 GAUGE GREEN ROLL TOP EDGER, RYERSON OR EQUAL OPER, HIS SUCCESSORS AND ASSIGNS SHALL BE RESPONSIBLE FOR THE ION, MAINTENANCE AND REPLACEMENT OF ALL IMPROVEMENTS SHOWN OR ON THE APPROVED LANDSCAPE PLAN ON FILE IN THE PLANNING DEPARTMENT.

SHEET INDEX

SCAPE NOTES SCAPE PLANT SCHEDULE SCAPE AMENITY/ MATERIAL SCHEDULE ALL LANDSCAPE PLAN SCAPE PLAN SCAPE PLAN LANDSCAPE PLAN LANDSCAPE PLAN LANDSCAPE DETAILS LANDSCAPE DETAILS IRRIGATION SCHEDULE OVERALL IRRIGATION PLAN IRRIGATION PLAN IRRIGATION PLAN IRRIGATION PLAN IRRIGATION PLAN IRRIGATION DETAILS IRRIGATION DETAILS 30 IRRIGATION DETAILS



OWNER: BOULDER COUNTY HOUSING AUTHORITY 3400 BROADWAY BOULDER, CO - 80304 303.441.3861 CONTACT: MOLLY CHIANG

DATE: 06.17.22 - SITE PLAN 01

> SHEET TITLE: LANDSCAPE NOTES



PLANT SCHEDULE	E PLANT HOLDERS				ORNAMENTAL GRASSES	BOTANICAL NAME	COMMON NAME		<u>ROOT</u> <u>SIZE</u>
DECIDUOUS TREES	BOTANICAL NAME	COMMON NAME	ROOT	SIZE	BO BA	BOUTELOUA GRACILIS `BLONDE AMBITION`	BLOND AMBITION BLUE GRAMA GRASS	、	CONT 1 GAL
AC GS	ACER GRANDIDENTATUM `SCHMIDT` TM	ROCKY MOUNTAIN GLOW MAPLE	<u>ROOT</u> B & B	<u>SIZE</u> 2"CAL	CA KF HE SE	CALAMAGROSTIS X ACUTIFLORA `KARL FOERST HELICTOTRICHON SEMPERVIRENS	ER` KARL FOERSTER FEATHER REED GRASS BLUE OAT GRASS	5	CONT 1 GAL CONT 1 GAL
CA HI CE CH	CATALPA SPECIOSA `HIAWATHA 2` TM CELTIS OCCIDENTALIS `CHICAGOLAND`	HEARTLAND NORTHERN CATALPA CHICAGOLAND HACKBERRY	B & B B & B	2"CAL 2"CAL	MI PU	MISCANTHUS SINENSIS 'PURPURESCENS'	FLAME GRASS		CONT 1 GAL
GL IM	GLEDITSIA TRIACANTHOS INERMIS `IMPERIAL`	IMPERIAL HONEYLOCUST	B&B	2"CAL 2"CAL	MU RE PA SH	MUHLENBERGIA REVERCHONI `UNDAUNTED` PANICUM VIRGATUM `SHENANDOAH`	UNDAUNTED MUHLY SWITCH GRASS		CONT 1 GAL CONT 1 GAL
GY DI	GYMNOCLADUS DIOICA `ESPRESSO`	KENTUCKY COFFEETREE	B & B	2"CAL	PE HA	PENNISETUM ALOPECUROIDES 'HAMELN'	HAMELN FOUNTAIN GRASS		CONT 1 GAL
KO PA PO AC	KOELREUTERIA PANICULATA POPULUS X ACUMINATA	GOLDENRAIN TREE LANCELEAF POPLAR	B & B B & B	2"CAL 2"CAL	SC SC SP HE	SCHIZACHYRIUM SCOPARIUM 'THE BLUES' SPOROBOLUS HETEROLEPIS	THE BLUES LITTLE BLUESTEM PRAIRIE DROPSEED		CONT. 1 GAL. CONT 1 GAL
PR SP	PRUNUS X SUCKER PUNCH TM	SUCKER PUNCH CHOKECHERRY	B & B	2"CAL	SPWR	SPOROBOLUS WRIGHTII	BIG SACATON		CONT 1 GAL
QU MA QU MU	QUERCUS MACROCARPA QUERCUS MUEHLENBERGII	BURR OAK CHINKAPIN OAK	B & B B & B	2"CAL 2"CAL					
QU CR	QUERCUS ROBUR `CRIMSCHMIDT` TM	CRIMSCHMIDT ENGLISH OAK	B & B	2"CAL	PERENNIALS	BOTANICAL NAME	COMMON NAME		ROOT SIZE
SO CR TI GR	SORBUS AUCUPARIA `MICHRED` TM TILIA CORDATA `GREENSPIRE`	CARDINAL ROYAL MOUNTAIN ASH GREENSPIRE LITTLELEAF LINDEN	B & B B & B	2"CAL 2"CAL	AC MI AC PA	ACHILLEA MILLEFOLIUM ACHILLEA MILLEFOLIUM `PAPRIKA`	COMMON YARROW PAPRIKA COMMON YARROW		CONT 1 GAL CONT 1 GAL
ULCC	ULMUS DAVIDIANA CHOICECITY	CHOICE CITY ELM	B&B	2"CAL	AG AU	AGASTACHE AURANTIACA	GIANT HYSSOP		CONT 1 GAL
			DOOT	0175	AG RU AN DE	AGASTACHE RUPESTRIS `APACHE SUNSET` ANACYCLUS DEPRESSUS	APACHE SUNSET THREADLEAF HYSSOP ALTAS DAISY		CONT 1 GAL CONT 1 GAL
EVERGREEN TREES JU ME	<u>BOTANICAL NAME</u> JUNIPERUS SCOPULORUM `MEDORA`	<u>COMMON NAME</u> MEDORA JUNIPER	<u>ROOT</u> B & B	<u>SIZE</u> 6` HEIGHT	AQ CA	AQUILEGIA CAERULEA	ROCKY MOUNTAIN COLUMBINE		CONT 1 GAL
JU WO	JUNIPERUS SCOPULORUM 'WOODWARD'	WOODWARD COLUMNAR JUNIPER	B & B	6` HEIGHT	AS TU	ASCLEPIAS TUBEROSA	BUTTERFLY MILKWEED		CONT 1 GAL
PI BB PI FA	PICEA PUNGENS `BABY BLUE` PICEA PUNGENS `FASTIGATA`	BABY BLUE COLORADO SPRUCE FASTIGIATE COLORADO SPRUCE	B & B B & B	6` HEIGHT 6` HEIGHT	BE LY CO LA	BERLANDIERA LYRATA COREOPSIS LANCEOLATA `STERNTALER`	CHOCOLATE DAISY STERNTALER LANCELEAF TICKSEED		CONT 1 GAL CONT 1 GAL
PLAR	PINUS ARISTATA	BRISTLECONE PINE	B&B	6` HEIGHT	DI FL	DIANTHUS DELTOIDES `FLASHING LIGHT`	FLASHING LIGHT MAIDEN PINK		CONT 1 GAL
PI ED	PINUS EDULIS		B & B	6` HEIGHT	DI SP EC PU	DICENTRA SPECTABILIS ECHINACEA PURPUREA	BLEEDING HEART PURPLE CONEFLOWER		CONT 1 GAL CONT 1 GAL
PI VP PI PO	PINUS FLEXILIS `VANDERWOLF`S PYRAMID` PINUS PONDEROSA	VANDERWOLF`S PYRAMID LIMBER PINE PONDEROSA PINE	B & B B & B	6` HEIGHT 6` HEIGHT	GA AR	GAILLARDIA ARISTATA	NATIVE BLANKET FLOWER		CONT 1 GAL
PS ME	PSEUDOTSUGA MENZIESII	DOUGLAS FIR	B & B	6` HEIGHT	HE HR	HEMEROCALLIS X `HAPPY RETURNS`	HAPPY RETURNS DAYLILY		CONT 1 GAL
FRUIT TREES	BOTANICAL NAME	COMMON NAME	ROOT	SIZE	HO PA IR OO	HOSTA FORTUNEI `PATRIOT` IRIS X GERMANICA `OPEN OCEAN`	PATRIOT HOSTA OPEN OCEAN GERMAN IRIS		CONT 1 GAL CONT 1 GAL
MA OE	MALUS X DOMESTICA `MCINTOSH`	MCINTOSH APPLE	B & B	<u>512E</u> 1.5"CAL	LA AN	LAVANDULA ANGUSTIFOLIA `MUNSTEAD`	MUNSTEAD ENGLISH LAVENDER		CONT 1 GAL
MARE	MALUS X DOMESTICA 'RED DELICIOUS'	RED DELICIOUS APPLE	B & B	1.5"CAL					CONT 1 GAL
PR AV PR MO	PRUNUS AVIUM `STELLA` PRUNUS CERASUS `MONTMORENCY`	STELLA SWEET CHERRY MONTMORENCY CHERRY	B & B B & B	1.5"CAL 1.5"CAL	NE RA OR LA	NEPETA RACEMOSA `WALKER`S LOW` ORIGANUM LAEVIGATUM `HERRENHAUSEN`	WALKER`S LOW CATMINT HERRENHAUSEN OREGANO		CONT 1 GAL CONT 1 GAL
PR ST	PRUNUS DOMESTICA `STANLEY`	STANLEY PLUM	B & B	1.5"CAL	PE RR	PENSTEMON MEXICALI `RED ROCKS`	RED ROCKS PENSTEMON		CONT 1 GAL
			DOOT	0175	RA CO RU FU	RATIBIDA COLUMNIFERA RUDBECKIA FULGIDA `GOLDSTRUM`	YELLOW PRAIRIE CONEFLOWER BLACK-EYED SUSAN		CONT 1 GAL CONT 1 GAL
<u>ORNAMENTAL TREES</u> AC FL	<u>BOTANICAL NAME</u> ACER GINNALA `FLAME`	<u>COMMON NAME</u> FLAME AMUR MAPLE	<u>ROOT</u> B & B	<u>SIZE</u> 1.5"CAL	SETE	SEDUM TELEPHIUM `BEKA` TM	AUTUMN DELIGHT STONECROP		CONT 1 GAL
AC HW	ACER TATARICUM `HOT WINGS`	HOT WINGS TATARIAN MAPLE	B & B	1.5"CAL	SO RU	SOLIDAGO RUGOSA `FIREWORKS`	FIREWORKS WRINKLELEAF GOLDENROD		CONT 1 GAL
CR AM CR CR	CRATAEGUS AMBIGUA CRATAEGUS CRUS-GALLI INERMIS `CRUSADER`	RUSSIAN HAWTHORN CRUSADER COCKSPUR HAWTHORN	B & B B & B	1.5"CAL 1.5"CAL	ZI GR	ZINNIA GRANDIFLORA `GOLD ON BLUE`	GOLD ON BLUE ROCKY MOUNTAIN ZINNI	A	CONT 1 GAL
HE MI	HEPTACODIUM MICONIOIDES	SEVEN SONS FLOWER	B&B	6` CLUMP					
MA DO			B & B	1.5"CAL	SEED MIX LIST				
MA RB MA TH	MALUS X `RED BARRON` MALUS X `THUNDERCHILD`	RED BARRON CRAB APPLE THUNDERCHILD CRAB APPLE	B & B B & B	1.5"CAL 1.5"CAL	WETLAND SEED	COMMON NAME	BOTANICAL NAME		
PR CH	PRUNUS X VIRGINIANA `P002`	SUCKER PUNCH CANADA CHOKECHERRY	B & B	1.5"CAL		WESTERN WHEATGRASS	PASCOPYRUM SMITHII VAR ARRIBA	29%	14.5 LBS.
SY RE	SYRINGA RETICULATA	JAPANESE TREE LILAC	B & B	6` HEIGHT		WOOLY SEDGE BLUE GRAMA	CAREX LANUGINOSA BOUTELOUA GRACILIS VAR LOVINGTON	1% 5%	0.5 LBS. 2.5 LBS.
DECIDUOUS SHRUBS	BOTANICAL NAME	COMMON NAME	ROOT	SIZE		NEBRASKA SEDGE	CAREX NEBRASKENSIS	5% 1%	0.5 LBS.
AR TR	ARTEMISIA TRIDENTATA	BIG SAGEBRUSH	CONT	5 GAL		SWITCHGRASS	PANICUM VIRGATUM VAR BLACKWELL	26%	13 LBS.
BE CP BU AL	BERBERIS THUNBERGII `CRIMSON PYGMY` BUDDLEJA ALTERNIFOLIA `ARGENTEA`	CRIMSON PYGMY BARBERRY SILVER FOUNTAIN BUTTERFLY BUSH	CONT CONT	5 GAL 5 GAL		INLAND SALTGRASS CREEPING SPIKERUSH	DISTICLIS STRICTA ELEOCHARIS PALUSTRIS	5% 1%	2.5 LBS. 0.5 LBS.
CE IN	CERCOCARPUS INTRICATUS	LITTLE LEAF MOUNTAIN MAHOGONY	CONT	5 GAL		BALTIC RUSH	JUNCUS BALTICUS	4%	2 LBS.
CH SS CO AF	CHAENOMELES SPECIOSA `SCARLET STORM` TM CORNUS SERICEA `ARCTIC FIRE`	DOUBLE TAKE SCARLET STORM FLOWERING QUINCE ARCTIC FIRE DOGWOOD	CONT CONT	5 GAL 5 GAL			SCIRPUS ACUTUS	4%	2 LBS. 10 LBS.
CO KE	CORNUS SERICEA `KELSEYI`	KELSEYI DOGWOOD	CONT	5 GAL		PRAIRIE CORDGRASS SAND DROPSEED	SPARTINA PECTINATA SPOROBOLUS CRYPTANDRUS	20% 4%	2 LBS.
COLU	COTONEASTER LUCIDUS	SHINY COTONEASTER	CONT	5 GAL					50 LBS. / PLS
ER NA FA PA	ERICAMERIA NAUSEOSA NAUSEOSA FALLUGIA PARADOXA	TALL BLUE RABBITBRUSH APACHE PLUME	CONT CONT	5 GAL 5 GAL				100%	PER ACRE
FR FL	FRANGULA ALNUS `FINE LINE` TM	TALL FERNLEAF BUCKTHORN	CONT	5 GAL	DRYLAND SEED	COMMON NAME	BOTANICAL NAME		
HO DU HY LI	HOLODISCUS DUMOSUS HYDRANGEA PANICULATA `LIMELIGHT`	ROCK SPIREA LIMELIGHT HYDRANGEA	CONT CONT	5 GAL 5 GAL		BLUE GRAMA	BOUTELOUA GRACILIC	19%	6.5 LBS.
HYRE	HYDRANGEA PANICULATA `RENHY`	VANILLA STRAWBERRY HYDRANGEA	CONT	5 GAL		CAMPER LITTLE BLUESTEM	SCHIZACHYRIUM SCOPARIUM	9%	3.0 LBS.
AM HY	HYDRANGEA QUERCIFOLIA `AMETHYST`	AMETHYST OAKLEAF HYDRANGEA	CONT.	5 GAL				9% 5%	3.0 LBS.
JA AM KR LA	JAMESIA AMERICANA KRASCHENINNIKOVIA LANATA	WAXFLOWER WINTERFAT	CONT CONT.	5 GAL 5 GAL		SAND DROPSEED VAUGHN SIDEOATS GRAMMA	SPOROBOLUS CRYPTANDRUS BOUTELOUA CURTIPENDULA	5% 9%	2.0 LBS. 3.0 LBS.
LILO	LIGUSTRUM VULGARE `LODENSE`	LODENSE PRIVET	CONT	5 GAL		ARRIBA WESTERN WHEATGRASS	AGROPYRON SMITHII 'ARRIBA'	16%	5.5 LBS.
PE LS PH DI	PEROVSKIA ATRIPLICIFOLIA `LITTLE SPIRE` TM PHYSOCARPUS OPULIFOLIUS `DIABOLO`	LITTLE SPIRE RUSSIAN SAGE DIABLO NINEBARK	CONT CONT	5 GAL 5 GAL		SAND BLUESTEM BUFFALOGRASS	ANDROPOGON HALLII 'GARDEN' BUCHLOE DACTYLOIDES "SHARPS IMPROVED"	10% 23%	3.5 LBS. 8.0 LBS.
PH DI PO PB	PHYSOCARPUS OPULIFULIUS DIABOLU POTENTILLA FRUTICOSA `PINK BEAUTY`	PINK BEAUTY POTENTILLA	CONT	5 GAL 5 GAL					
PR PB	PRUNUS BESSEYI PAWNEE BUTTES	CREEPING WESTERN SAND CHERRY	CONT	5 GAL				100%	34.5 LBS. / PLS
RH AU RH TY	RHUS TRILOBATA `AUTUMN AMBER` RHUS TYPHINA `BAILTIGER` TM	AUTUMN AMBER SUMAC TIGER EYES STAGHORN SUMAC	CONT CONT	5 GAL 5 GAL	ENHANCED NATI	/E SEED <u>COMMON NAME</u>	BOTANICAL NAME		PER ACRE
RI GR	RIBES ALPINUM `GREEN MOUND`	GREEN MOUND ALPINE CURRANT	CONT	5 GAL		SIDE OATS GRAMA	BOUTELOUA CURTIPENDULA	5%	0.57 LBS
RO TB	ROSA RUGOSA `THERESE BUGNET`	THERESE BUGNET ROSE		5 GAL	· · · · ·	BLUE GRAMA	BOUTELOUA GRACILIS	10%	0.26 LBS
RO WO RO BL	ROSA WOODSII ROSA X `BLUSHING KNOCKOUT`	MOUNTAIN ROSE ROSE	CONT CONT	5 GAL 5 GAL		BUFFALOGRASS CANADA WILDRYE	BOUTELOUA DACTYLOIDES ELYMUS CANADENSIS	10% 10%	3.89 LBS 1.89 LBS
RU EH	RUBUS FRUTICOSUS 'EBONY HARDY'	EBONY HARDY BLACKBERRY	CONT	5 GAL		THICKSPIKE WHEATGRASS	ELYMUS LANCEOLATUS	10%	1.41 LBS
RU BO SAL EXI	RUBUS X `BOYSEN` SALIX EXIGUA	BOYSENBERRY COYOTE WILLOW	CONT CONT	5 GAL 5 GAL		SLENDER WHEATGRASS	ELYMUS TRACHYCAULUS	10%	1.37 LBS
SAL EXI SY MK	SALIX EXIGUA SYRINGA PATULA `MISS KIM`	MISS KIM LILAC	CONT	5 GAL 5 GAL			PANICUM VIRGATUM 'TRAILBLAZER'	3%	0.17 LBS
VILA	VIBURNUM LANTANA `MOHICAN`	MOHICAN WAYFARING TREE	CONT	5 GAL		WESTERN WHEATGRASS LITTLE BLUESTEM	PASCOPYRUM SMITHII SCHIZACHYRIUM SCOPARIUM	5% 5%	0.99 LBS 0.42 LBS
EVERGREEN SHRUBS	BOTANICAL NAME	COMMON NAME	ROOT	SIZE		ALKALI SACATON	PUCCINELLIA	2%	0.42 LBS
AR PA	ARCTOSTAPHYLOS X COLORADOENSIS `PANCHITO`	PANCHITO MANZANITA	CONT	5 GAL		SAND DROPSEED	SPOROBOLUS CRYPTANDRUS	5%	0.02 LBS
	EUONYMUS FORTUNEI `EMERALD GAIETY` TM			5 GAL		ROCKY MOUNTAIN BEE	CLEOME SERRULATA	5%	1.65 LBS
JUN MO9 JU SG	JUNIPERUS SCOPULORUM `MOONGLOW` JUNIPERUS X MEDIA `SEA GREEN`	MOONGLOW JUNIPER SEA GREEN JUNIPER	CONT CONT	5 GAL 5 GAL		PLANT PLAINS COREOPSIS PURPLE PRAIRE CLOVER	COREOPSIS TINCTORIA DALEA PURPUREA	5% 5%	0.02 LBS 0.36 LBS
MA AQ	MAHONIA AQUIFOLIUM `COMPACTA`	COMPACT OREGON GRAPE	CONT	5 GAL		BLANKET FLOWER	GAILLARDIA ARISTATA	5% 5%	0.83 LBS
PI MU YU FI	PINUS MUGO `SLOWMOUND` YUCCA FILAMENTOSA	SLOWMOUND MUGO PINE ADAM`S NEEDLE	CONT CONT	5 GAL 5 GAL		YELLOW CONEFLOWER	RATIBIDA COLUMNIFERA	5%	0.09 LBS
YU GL	YUCCA FILAMENTOSA YUCCA GLAUCA	SOAPWEED	CONT	5 GAL 5 GAL				100%	13.97 LBS.
								10070	DRILLED

WILLOUGHBY CORNER SITE PLAN - PHASE 1



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IRRIGATED SOD

HEAT RESISTANT TEXAS BLUEGRASS MIX. CONTRACTOR SHALL SUBMIT CUT SHEETS FOR APPROVAL. UGHBY WILL SITE PL/ LAFAYETTE, 0

CORNER

OWNER: BOULDER COUNTY HOUSING AUTHORITY 3400 BROADWAY BOULDER, CO - 80304 303.441.3861 CONTACT: MOLLY CHIANG

DATE: 06.17.22 - SITE PLAN 01

> SHEET TITLE: LANDSCAPE SCHEDULE



MATER	IAL SCHEDULE (CONTRA	CTOR TO SUBMIT SAMPLES FOR	ALL ITEMS IN MATERIAL SCHED	ULE FOR OWNER / ARCHITECT F	REVIEW AND APPROVAL.)		
ITEM	DESCRIPTION	PROVIDER	SIZE / DIMENSIONS	PRODUCT NAME	COLOR / FINISH	NOTES	QUANTITY
Â	CONCRETE FLATWORK	N/A	N/A	N/A	STANDARD GRAY, BROOM FINISH	INSTALL PER MANUFACTURER'S SPECIFICATIONS	N/A; SEE CIVIL
B	ENHANCED PAVING	DAVIS COLOR OR APPROVED EQUAL	N/A		TBD	INSTALL PER MANUFACTURER'S SPECIFICATIONS	
\diamond	COBBLE MULCH	PIONEER OR APPROVED EQUAL	6-12" ROCK, MIN. 4" DEPTH.	N/A	RIVER ROCK BLEND	INSTALL PER MANUFACTURER'S SPECIFICATIONS	
	ROCK MULCH	PIONEER OR APPROVED EQUAL	MIX OF 30% 1-2" ROCK, 30% 4-6" ROCK, AND 40% 6-12" ROCK; MIN. 4" DEPTH	N/A	RIVER ROCK BLEND	INSTALL PER MANUFACTURER'S SPECIFICATIONS	
E	WOOD MULCH	PIONEER OR APPROVED EQUAL	CUSTOM	N/A	GORILLA HAIR SHREDDED CEDAR MULCH	INSTALL PER MANUFACTURER'S SPECIFICATIONS	
F	CRUSHER FINES	PIONEER OR APPROVED EQUAL	N/A	N/A	DOLOMITE TAN COLOR	INSTALL PER MANUFACTURER'S SPECIFICATIONS	
G	IRRIGATED TURF- SOD	N/A	N/A	TEXAS HYBRID BLUEGRASS BLEND	N/A	INSTALL PER MANUFACTURER'S SPECIFICATIONS	
H	PLAYGROUND SURFACING	POUR IN PLACE (PIP)	CUSTOM	N/A		INSTALL PER MANUFACTURER'S SPECIFICATIONS	
\Diamond	STEEL EDGER	RYERSON OR APPROVED EQUAL	6" X 14 GAUGE	N/A	INTERLOCKING, ROLLED TOP EDGER OR APPROVED EQUAL, COLOR- BLACK	INSTALL PER MANUFACTURER'S SPECIFICATIONS	

WILLOUGHBY CORNER SITE PLAN - PHASE 1

LOTS 160, 161, 164, 165, 166 & 167, & OUTLOTS F, I, J & K OF THE WILLOUGHBY CORNER SUBDIVISION, CITY OF LAFAYETTE, COUNTY OF BOULDER, STATE OF COLORADO


AMENI	TY SCHEDULE					
ITEM	DESCRIPTION	MANUFACTURER	CONTACT	PRODUCT NAME	COLOR/FINISH	NOTES
$\langle 1 \rangle$	BENCH	LANDSCAPE FORMS	CONTACT: Vivian Kovacs 800.430.6206 x 1323 www.landscapeforms.com	GENERATION 50 BENCH WITH LOOPED END ARMS OR APPROVED EQUAL	TBD	SURFACE MOUNT PER MANUFACTURER SPECIFICATIONS
	TWIG BENCH	LANDSCAPE FORMS	CONTACT: Vivian Kovacs 800.430.6206 x 1323 www.landscapeforms.com	BACKED TWIG BENCH	TBD	FREE STANDING
	TRASH RECEPTACLE	SITE PIECES	CONTACT: 800.484.0797 www.sitepieces.com	MONOLINE LITTER BIN ML-LGLITTER-DL OR APPROVED EQUAL	POWDERCOAT BLACK	SURFACE MOUNT PER MANUFACTURER SPECIFICATIONS
	BIKE RACK	LANDSCAPE FORMS	CONTACT: Vivian Kovacs 800.430.6206 x 1323 www.landscapeforms.com	FLO BIKE RACK OR APPROVED EQUAL	TBD	SURFACE MOUNT PER MANUFACTURER SPECIFICATIONS
\$	DOG WASTE STATION	SITE PIECES	CONTACT: 800.484.0797 www.sitepieces.com	MONOLINE NO.2 BAG HOLDER + WASTE BIN OR APPROVED EQUAL	TBD	SURFACE MOUNT PER MANUFACTURER SPECIFICATIONS
6	BISTRO TABLES	LANDSCAPE FORMS	CONTACT: Vivian Kovacs 800.430.6206 x 1323 www.landscapeforms.com	CATENA SURFACE MOUNT TABLE WITH PERFORATED STEELHEAD METAL OR APPROVED EQUAL	TBD	SURFACE MOUNT PER MANUFACTURER SPECIFICATIONS
	BISTRO CHAIRS	LANDSCAPE FORMS	CONTACT: Vivian Kovacs 800.430.6206 x 1323 www.landscapeforms.com	CATENA CHAIRS OR APPROVED EQUAL	TBD	FREESTANDING
	STRING LIGHTS	AQ LIGHTING	CONTACT: 800.865.7221 www.aqlightinggroup.com	120V COMMERCIAL GRADE OUTDOOR LED STRING LIGHTS OR APPROVED EQUAL	BLACK WIRE, CLEAR BULB	INSTALL PER MANUFACTURER'S SPECIFICATIONS, TO BE FASTENED TO STEEL CABLE FOR SUPPORT, STRINGS TO BE TAUT, REFER TO ELECTRICAL
$\langle \rangle$	STRING LIGHTS POLE	STRUCTURA	CONTACT: 913:390.8787 www.structura.com			INSTALL PER MANUFACTURER'S SPECIFICATIONS
8	PLANTERS	TBD	TBD	TBD	TBD	INSTALL PER MANUFACTURER'S SPECIFICATIONS
(9)	GRILL	TBD	TBD	TBD	TBD	INSTALL PER MANUFACTURER'S SPECIFICATIONS
	ART/ LIGHT FEATURE	TBD	TBD	TBD	TBD	INSTALL PER MANUFACTURER'S SPECIFICATIONS



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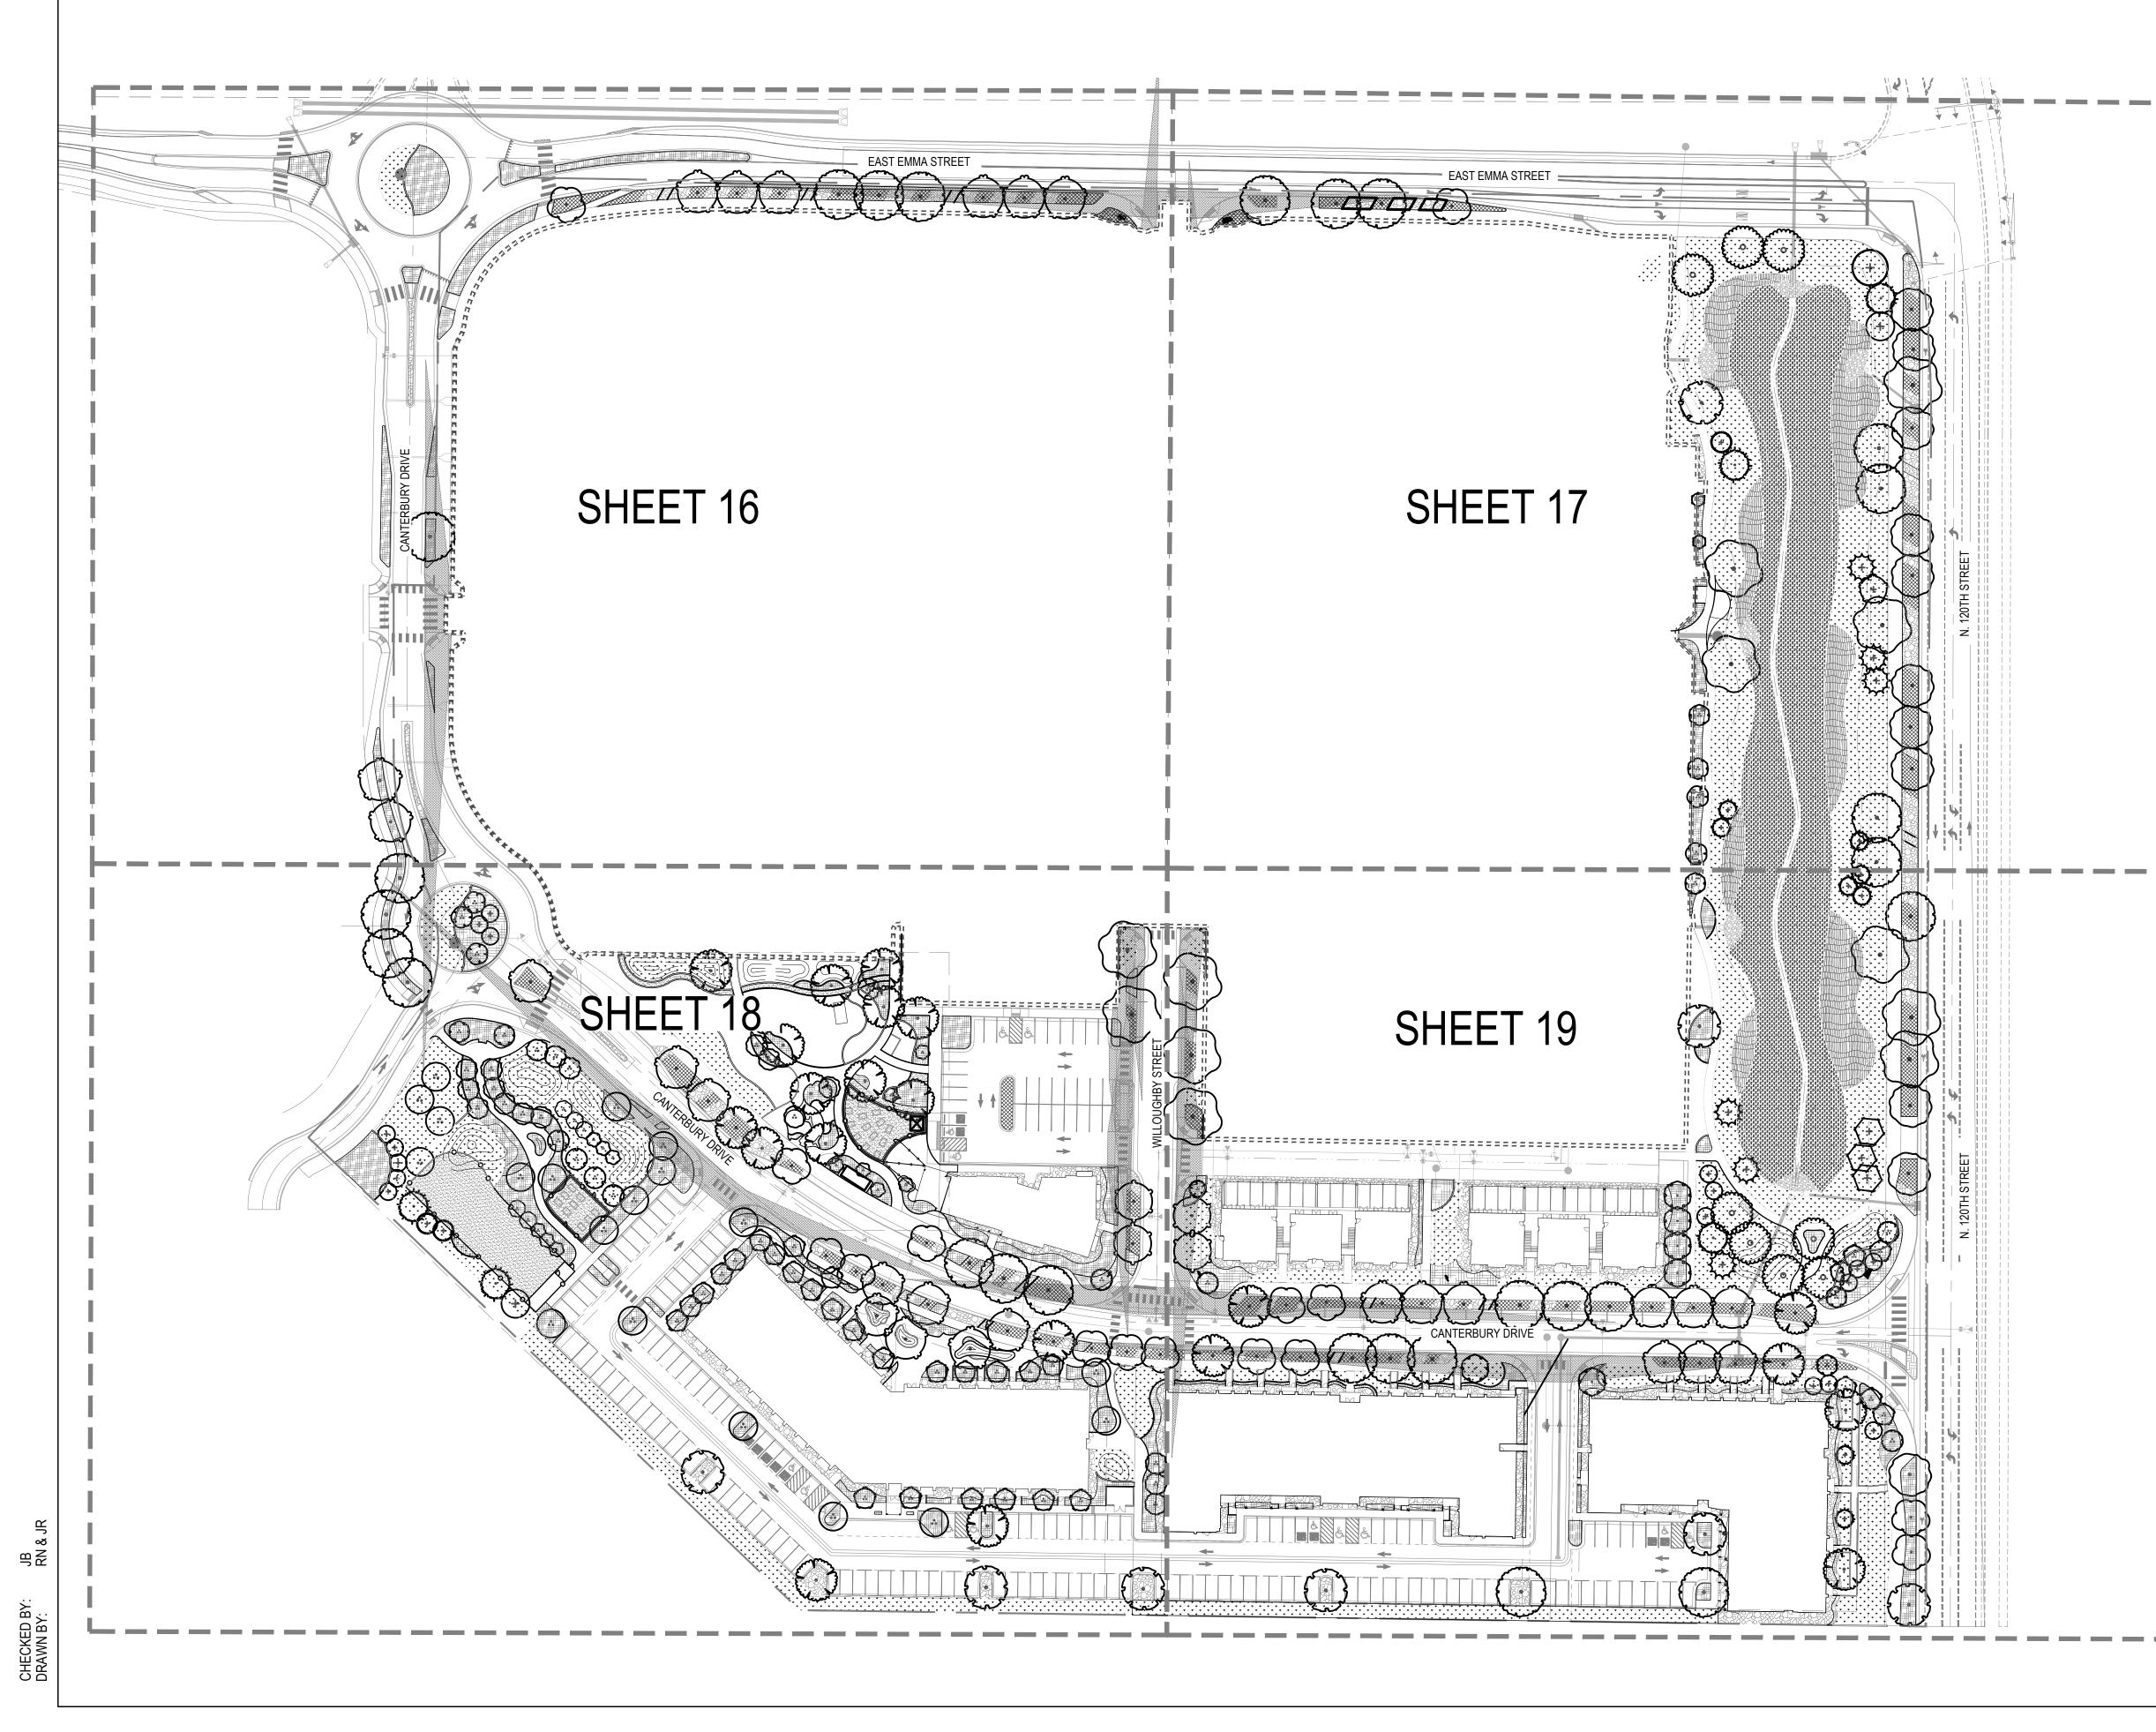
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OWNER: BOULDER COUNTY HOUSING AUTHORITY 3400 BROADWAY BOULDER, CO - 80304 303.441.3861 CONTACT: MOLLY CHIANG



SHEET TITLE: MATERIAL & AMENITY SCHEDULE

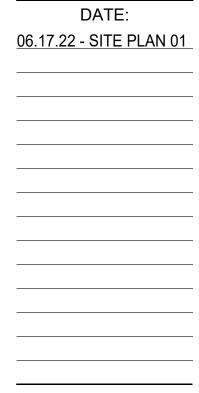



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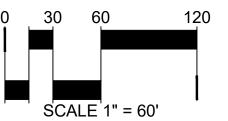
CANOPY TREES K+ C+ EVERGREEN TREES ORNAMENTAL TREES ROCK MULCH WOOD MULCH IRRIGATED TURF IRRIGATED NATIVE GRASS NATIVE WETLAND GRASS NATIVE WILDFLOWER MIX CRUSHER FINES PLAY SURFACE ENHANCED PAVEMENT ----------------------------------FENCE PROPERTY LINE — — R.O.W. ==== PHASE 1 BOUNDARY

LEGEND




OWNER: BOULDER COUNTY HOUSING AUTHORITY 3400 BROADWAY BOULDER, CO - 80304 303.441.3861 CONTACT: MOLLY CHIANG

	DATE:	
<u>06.17</u>	2.22 - SITE PLAN	01
5	SHEET TITLE:	
(OVERALL	
	PLAN	







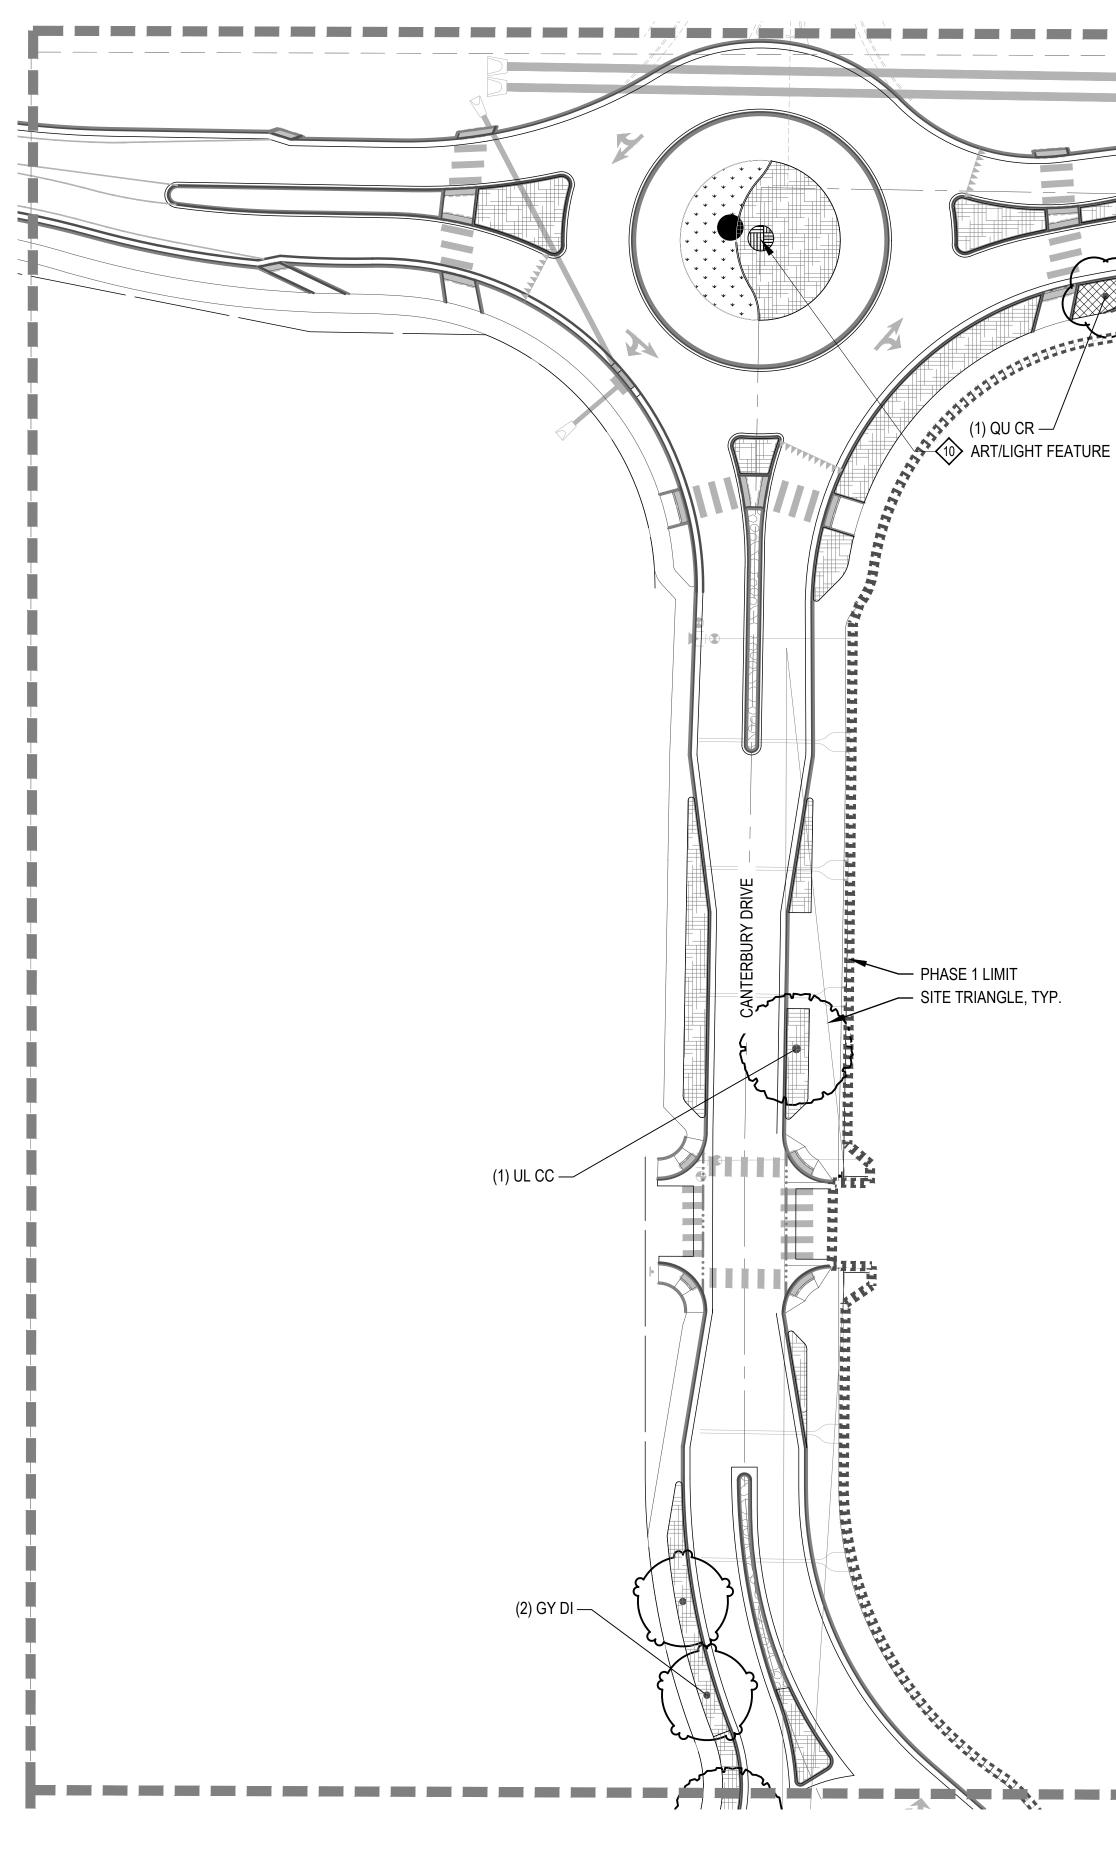

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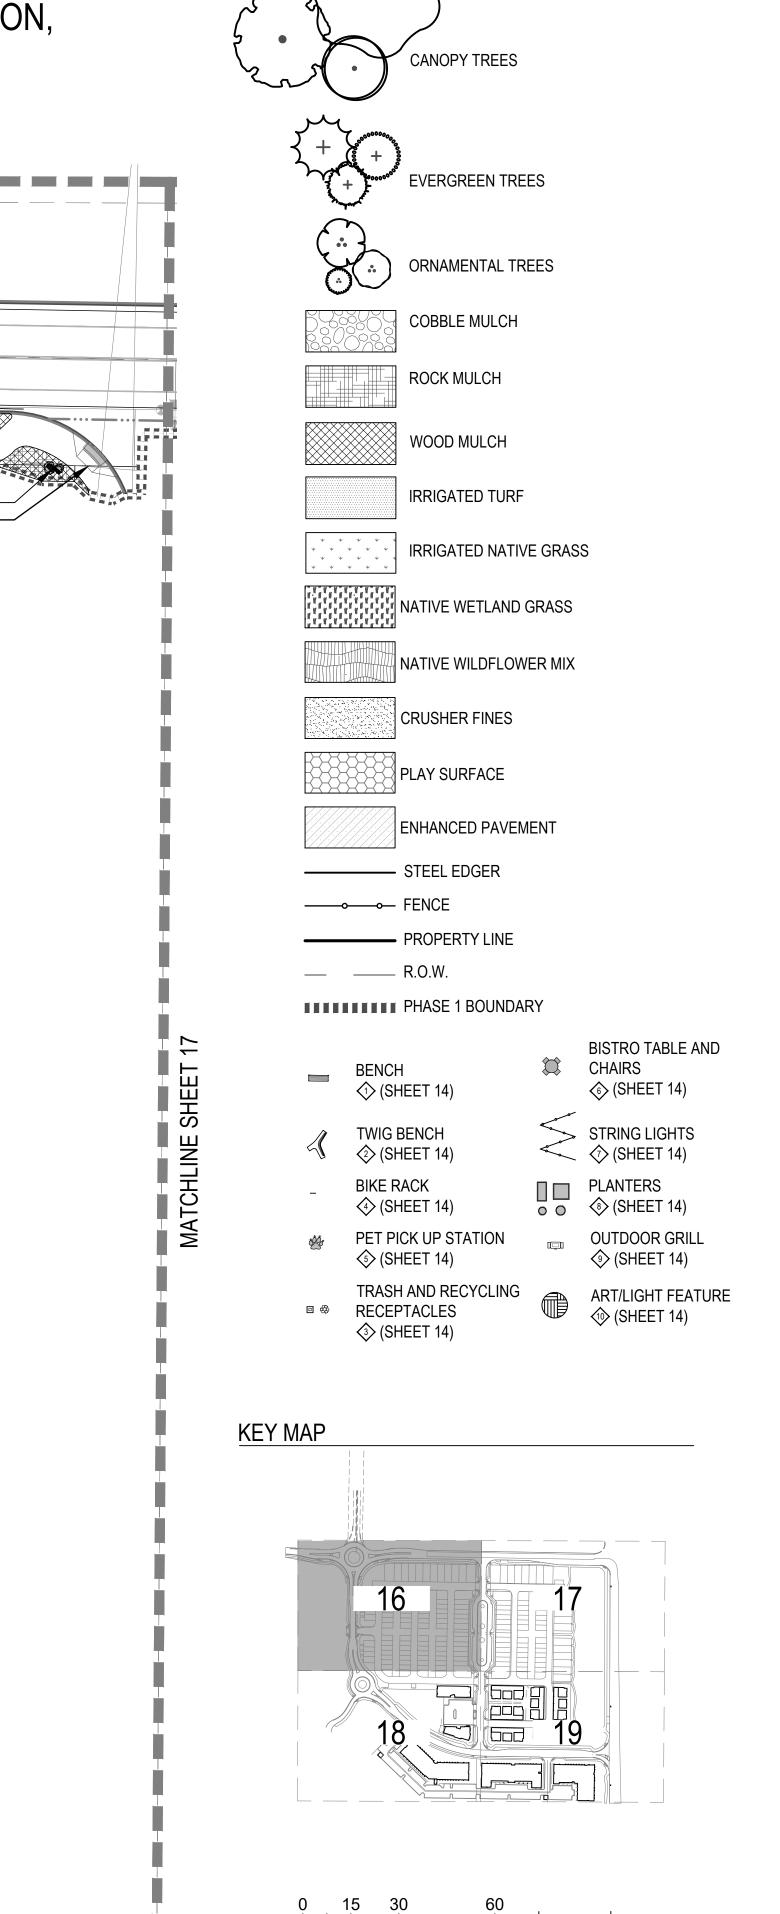
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WILLOUGHBY CORNER SITE PLAN - PHASE 1

EAST EMMA STREET (3) UL CC – (3) GY DI – (3) GY DI –







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CORNER

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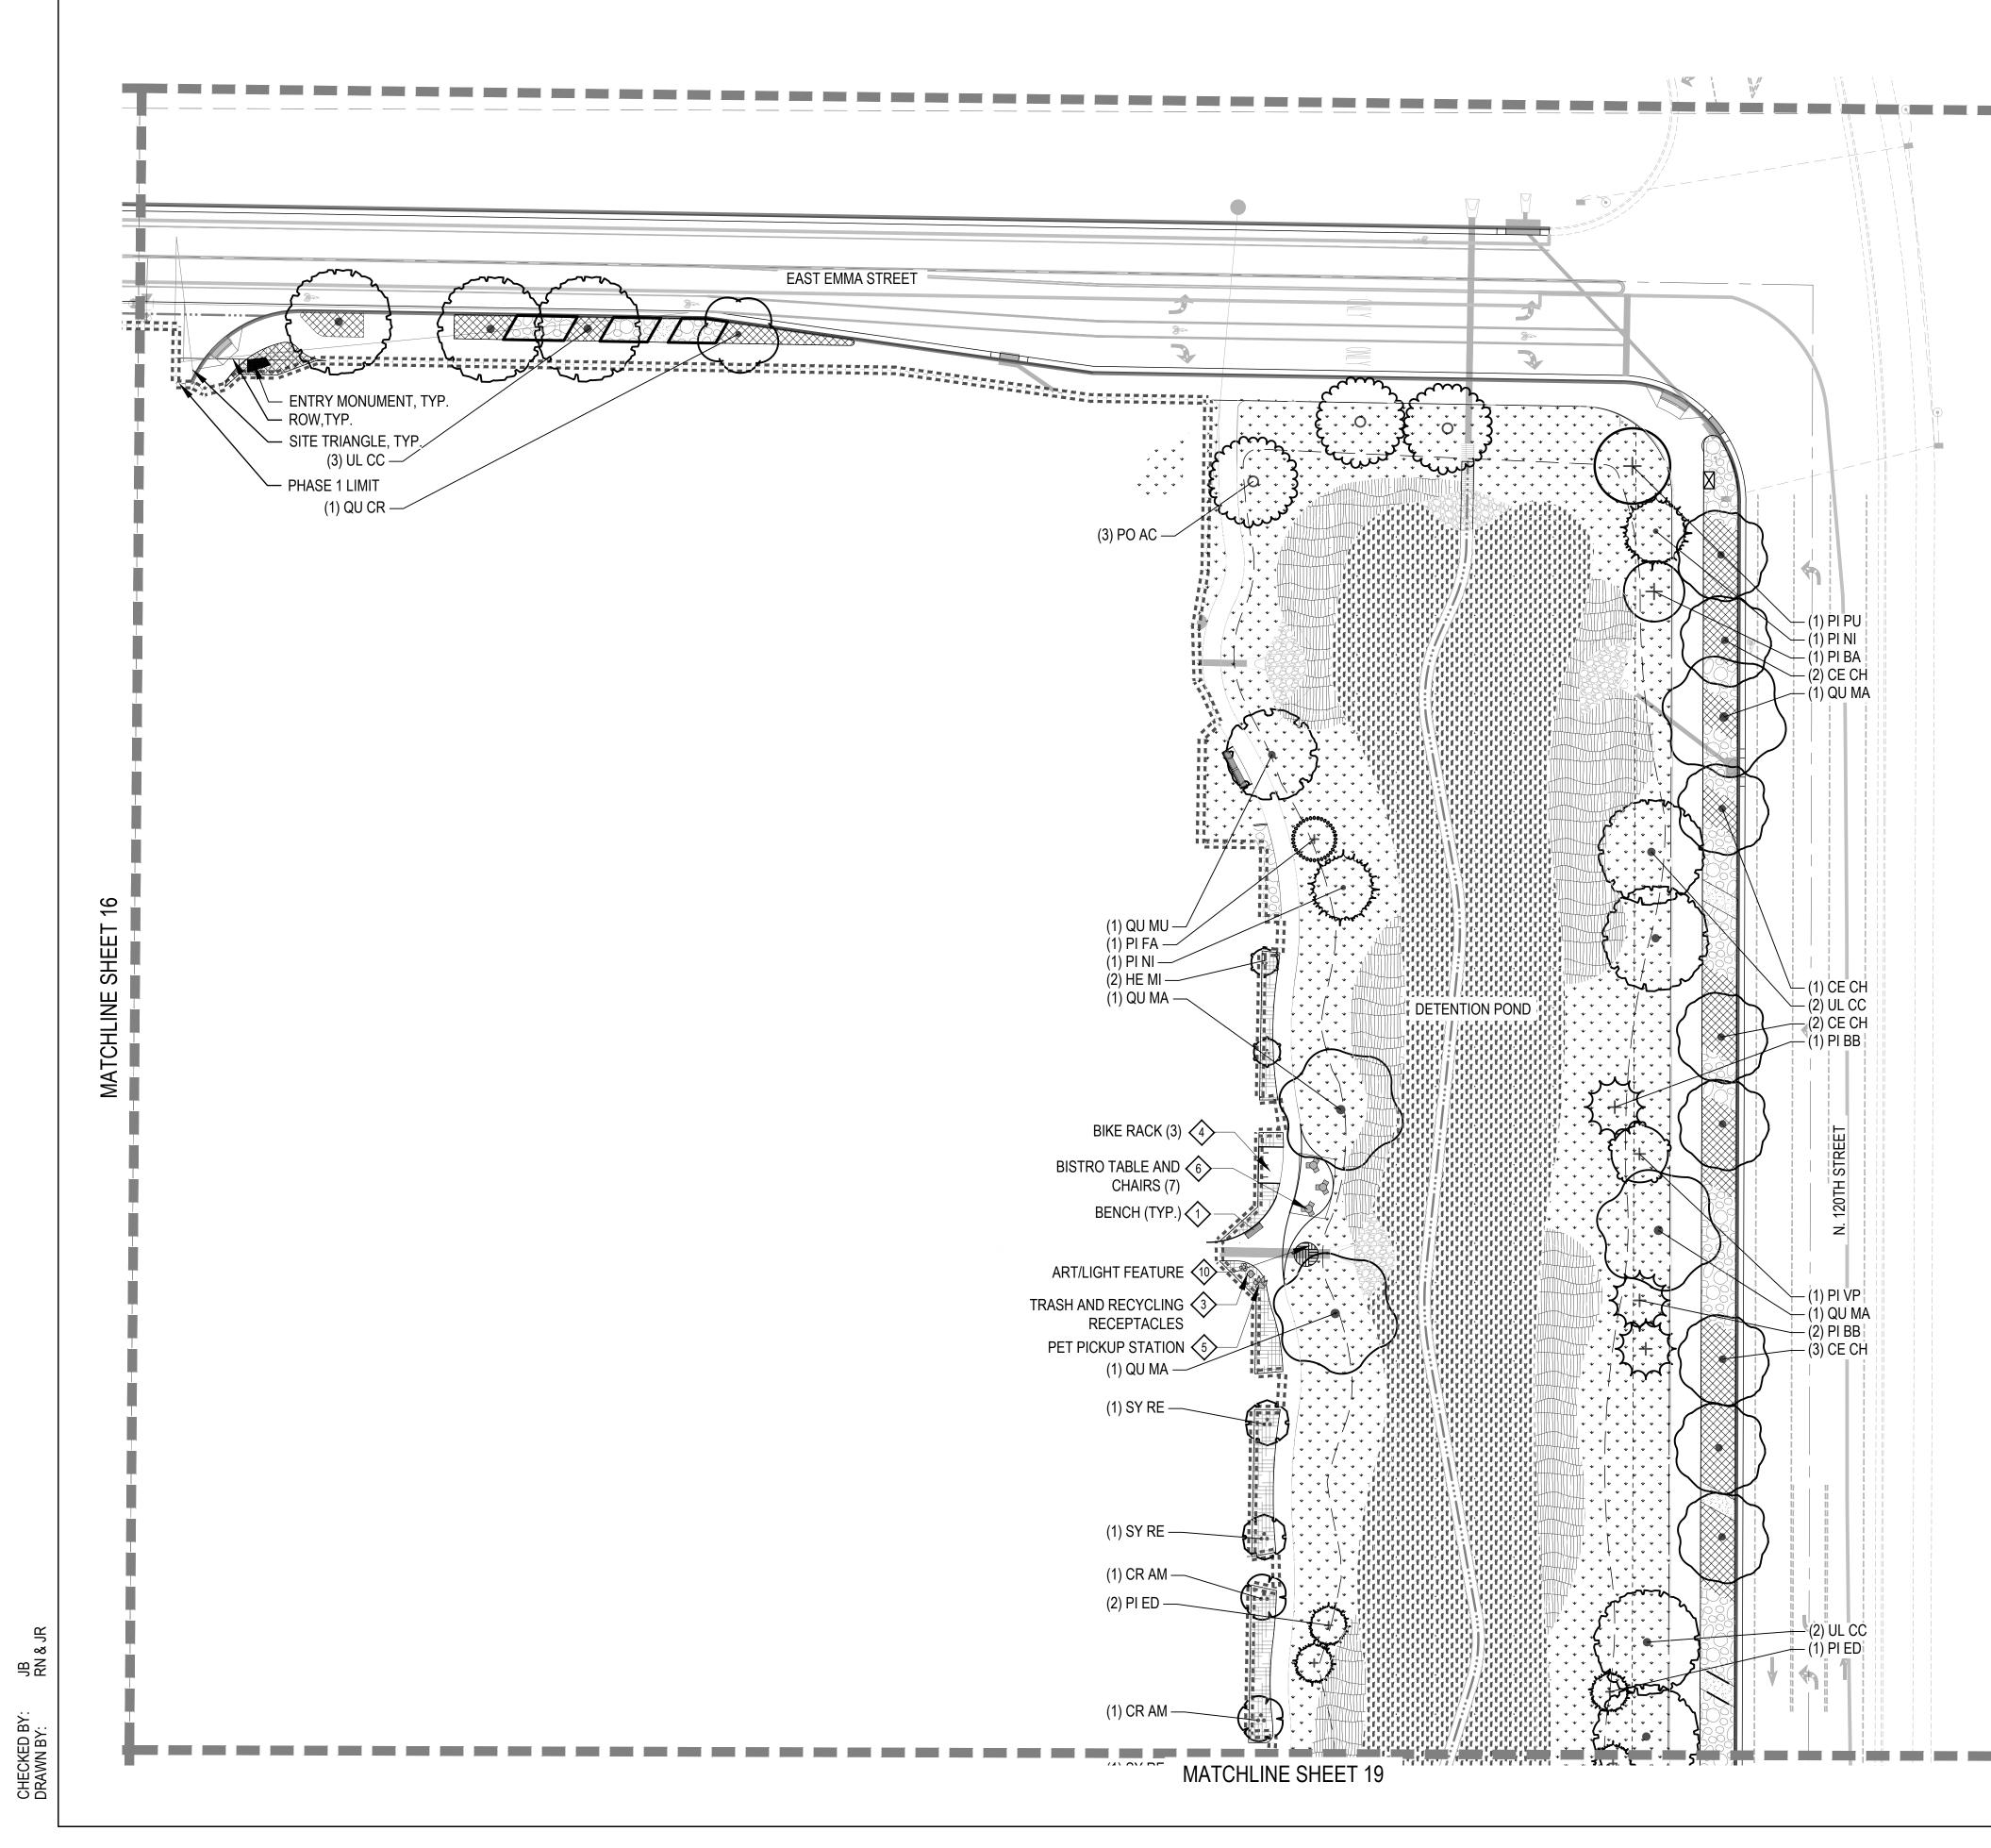
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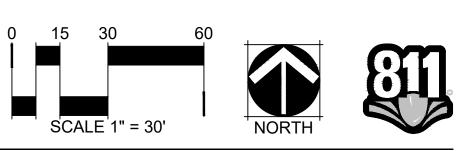
SCALE 1" = 30'



WILLOUGHBY CORNER SITE PLAN - PHASE 1

LEGEND

CANOPY TREES
+ + + EVERGREEN TREES
ORNAMENTAL TREES
WOOD MULCH
IRRIGATED TURF
IRRIGATED NATIVE GRASS
NATIVE WETLAND GRASS
NATIVE WILDFLOWER MIX
CRUSHER FINES
PLAY SURFACE
ENHANCED PAVEMENT
STEEL EDGER
PROPERTY LINE
R.O.W.
PHASE 1 BOUNDARY
BENCH (SHEET 14) BISTRO TABLE AND CHAIRS (SHEET 14) CHAIRS
TWIG BENCH (SHEET 14) STRING LIGHTS (SHEET 14)
BIKE RACK □□□ PLANTERS ♦ (SHEET 14) • • • ♦ (SHEET 14)
 PET PICK UP STATION (SHEET 14) (SHEET 14) (SHEET 14)
TRASH AND RECYCLING ■
KEY MAP



OWNER: BOULDER COUNTY HOUSING AUTHORITY 3400 BROADWAY BOULDER, CO - 80304 303.441.3861 CONTACT: MOLLY CHIANG

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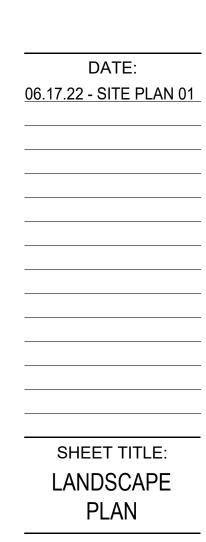
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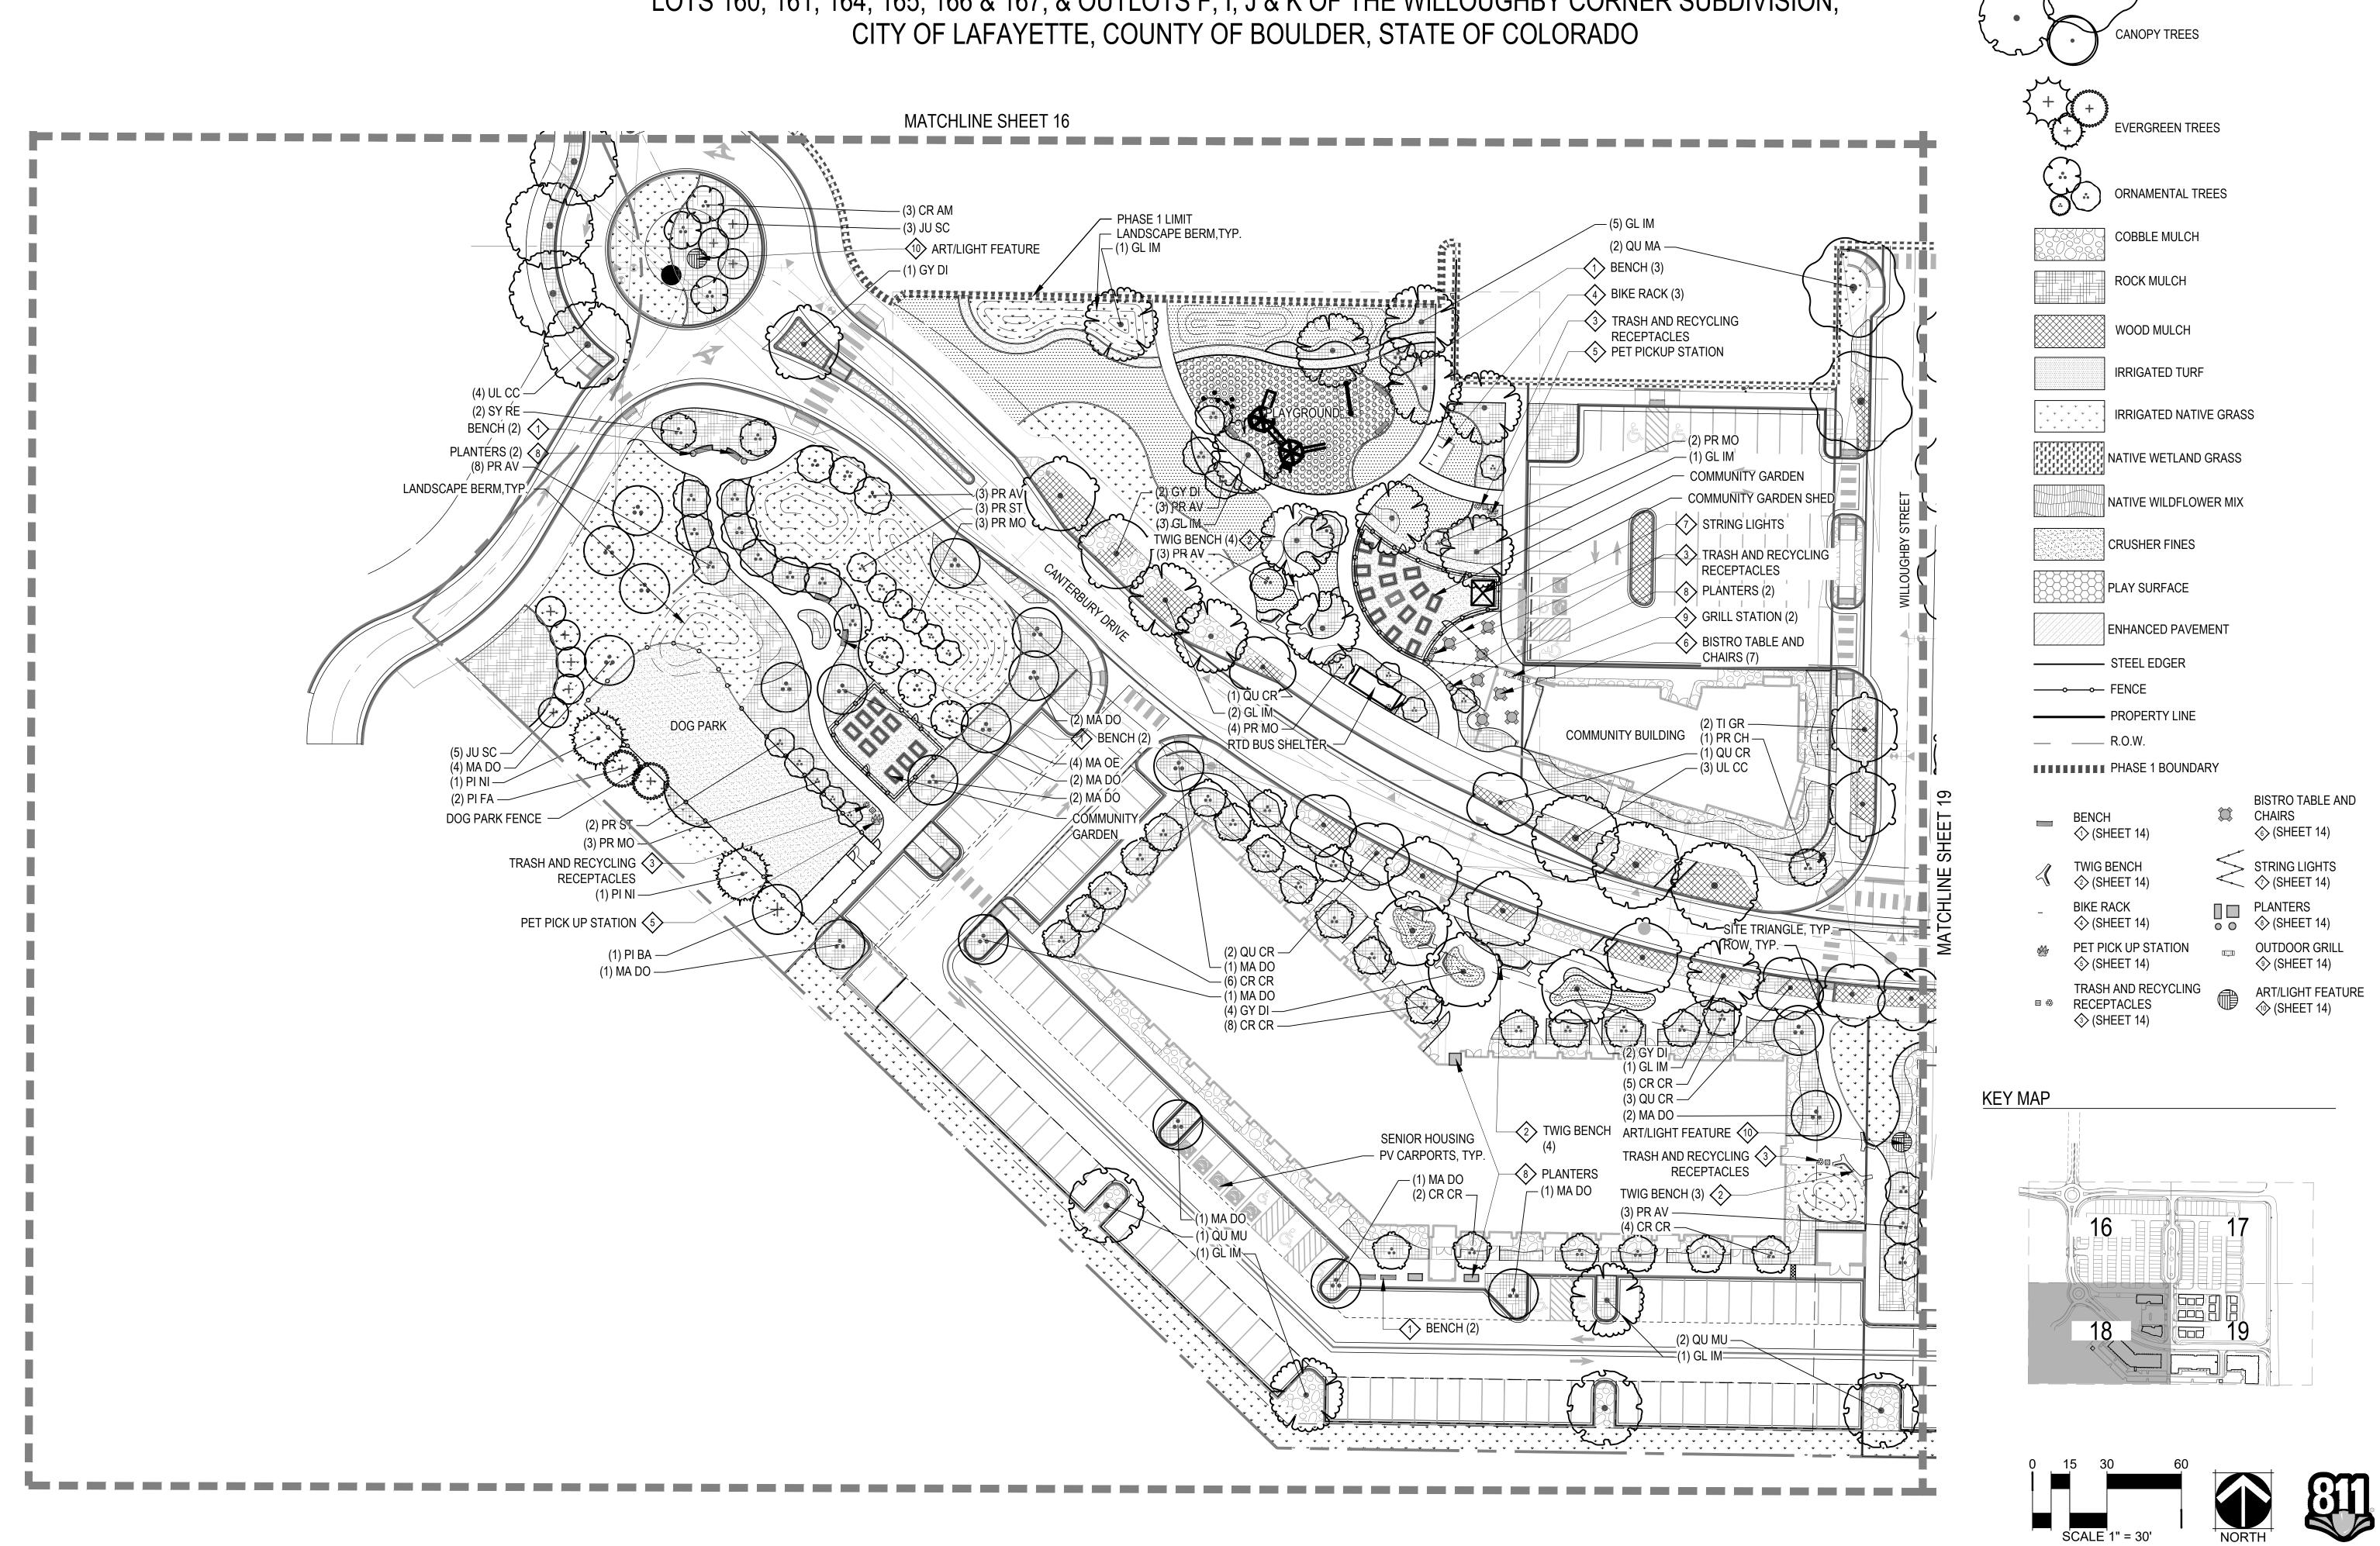
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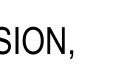


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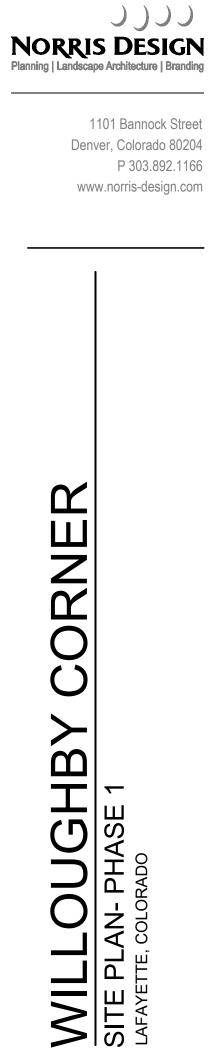
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WILLOUGHBY CORNER SITE PLAN - PHASE 1





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	•	CANOPY TREES		
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	+ + + + + + + + + + + + + + + + + + +	EVERGREEN TRE	ES	
		ORNAMENTAL TR	REES	
		COBBLE MULCH		
		ROCK MULCH		
		WOOD MULCH		
		IRRIGATED TURF		
	+ + + + + + + + +	IRRIGATED NATIV	/E GRAS	S
		NATIVE WETLAND	GRASS	
	· · · · · · · · · · · · · · · · · · ·	NATIVE WILDFLOW	/ER MIX	
		CRUSHER FINES		
		PLAY SURFACE		
		ENHANCED PAVEN	IENT	
		STEEL EDGER		
	~	FENCE		
		PROPERTY LINE		
		R.O.W.		
		PHASE 1 BOUNDA	RY	
	BENC⊦ ∢े (S⊦	l IEET 14)		BISTRO TABLE A CHAIRS ⓒ (SHEET 14)
$\langle \langle \langle \rangle \rangle$		BENCH IEET 14)		STRING LIGHTS
-	BIKE R �∕ (S⊦	ACK IEET 14)		PLANTERS
÷		CK UP STATION IEET 14)	I)	OUTDOOR GRIL
040	RECEF	I AND RECYCLING PTACLES IEET 14)		ART/LIGHT FEA ⁻ (SHEET 14)
MAP				



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DATE:


06.17.22 - SITE PLAN 01



SHEET TITLE:

LANDSCAPE

PLAN

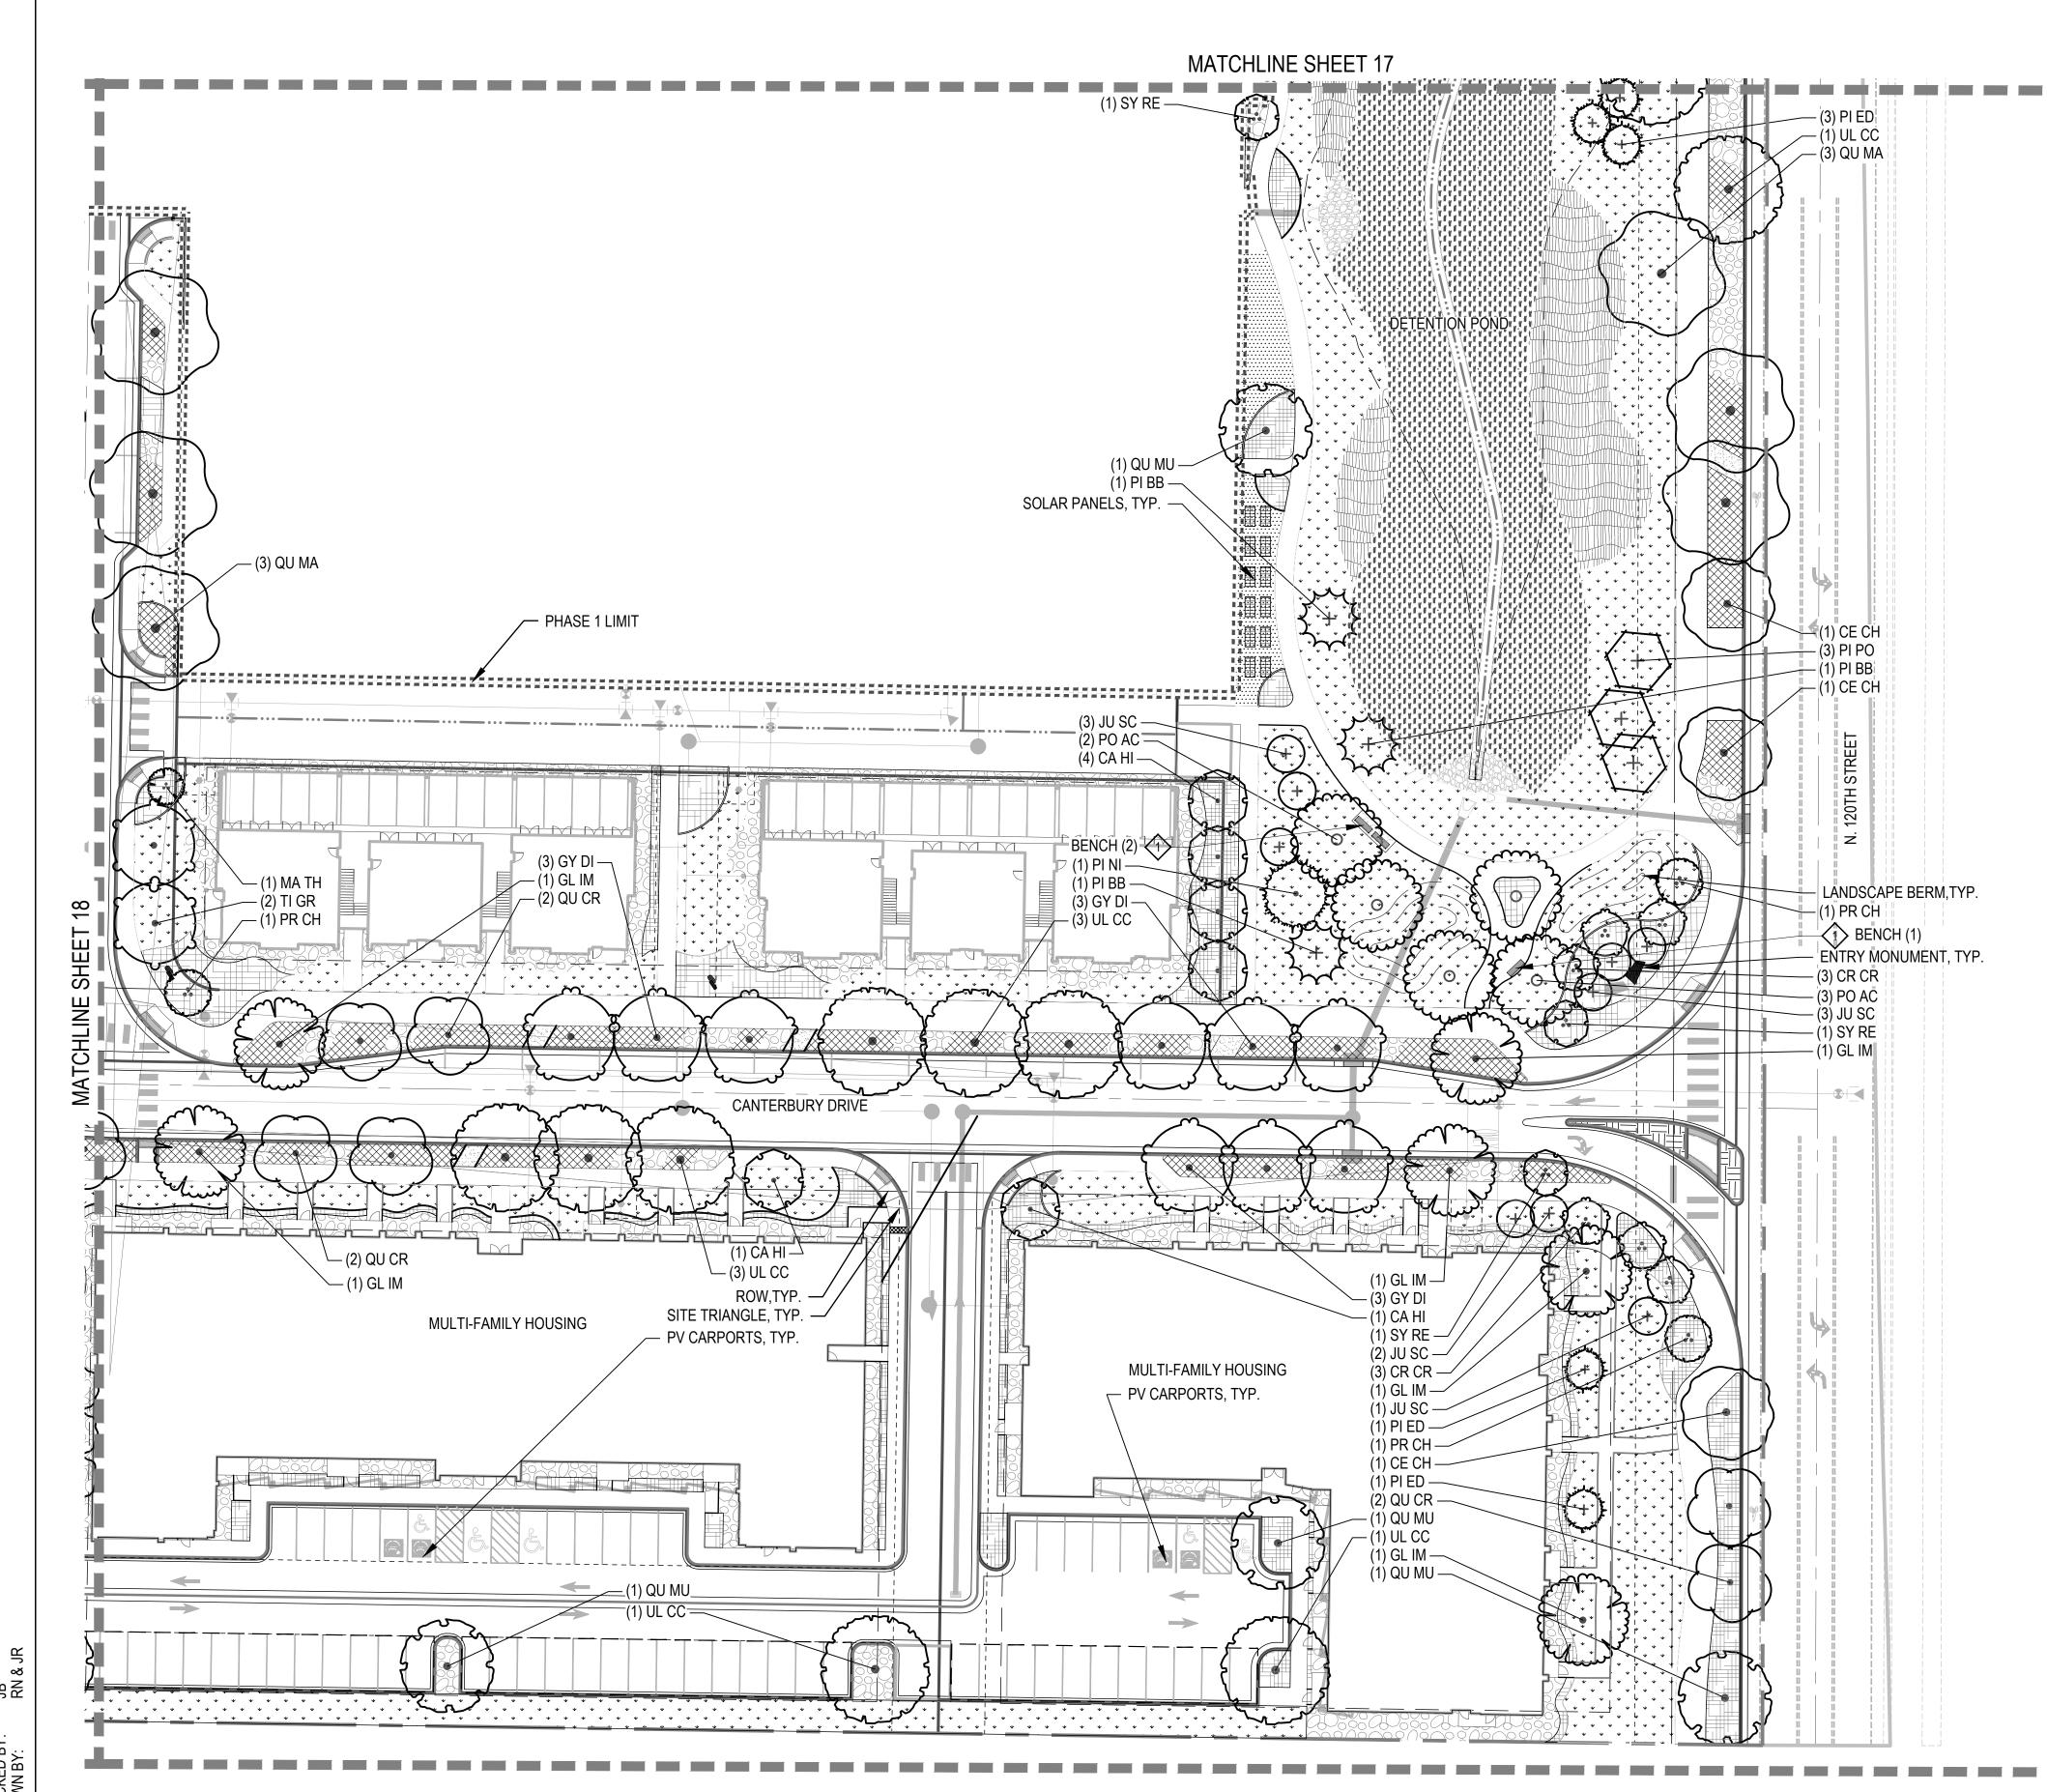


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WILLOUGHBY CORNER SITE PLAN - PHASE 1 LOTS 160, 161, 164, 165, 166 & 167, & OUTLOTS F, I, J & K OF THE WILLOUGHBY CORNER SUBDIVISION, CITY OF LAFAYETTE, COUNTY OF BOULDER, STATE OF COLORADO

LEGEND

CANOPY TREES	
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+ (source of the source of the	
ORNAMENTAL TREES	
COBBLE MULCH	
ROCK MULCH	
WOOD MULCH	
IRRIGATED TURF	
IRRIGATED NATIVE GRASS	
NATIVE WETLAND GRASS	
NATIVE WILDFLOWER MIX	
CRUSHER FINES	
PLAY SURFACE	
ENHANCED PAVEMENT	
STEEL EDGER	
PROPERTY LINE	
BISTRO TABI	LE AND
BENCH CHAIRS (SHEET 14) (SHEET 14)	4)
TWIG BENCH (SHEET 14) STRING LIGH (SHEET 1	
BIKE RACK □ ■ PLANTERS ④ (SHEET 14) ● ○ ⑤ (SHEET 14)	4)
 PET PICK UP STATION OUTDOOR G (SHEET 14) (SHEET 14) 	
TRASH AND RECYCLING ■	
KEY MAP	

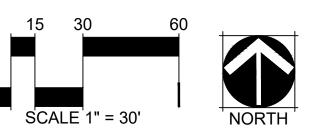

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SITE | OWNER: BOULDER COUNTY HOUSING AUTHORITY 3400 BROADWAY BOULDER, CO - 80304 303.441.3861 CONTACT: MOLLY CHIANG

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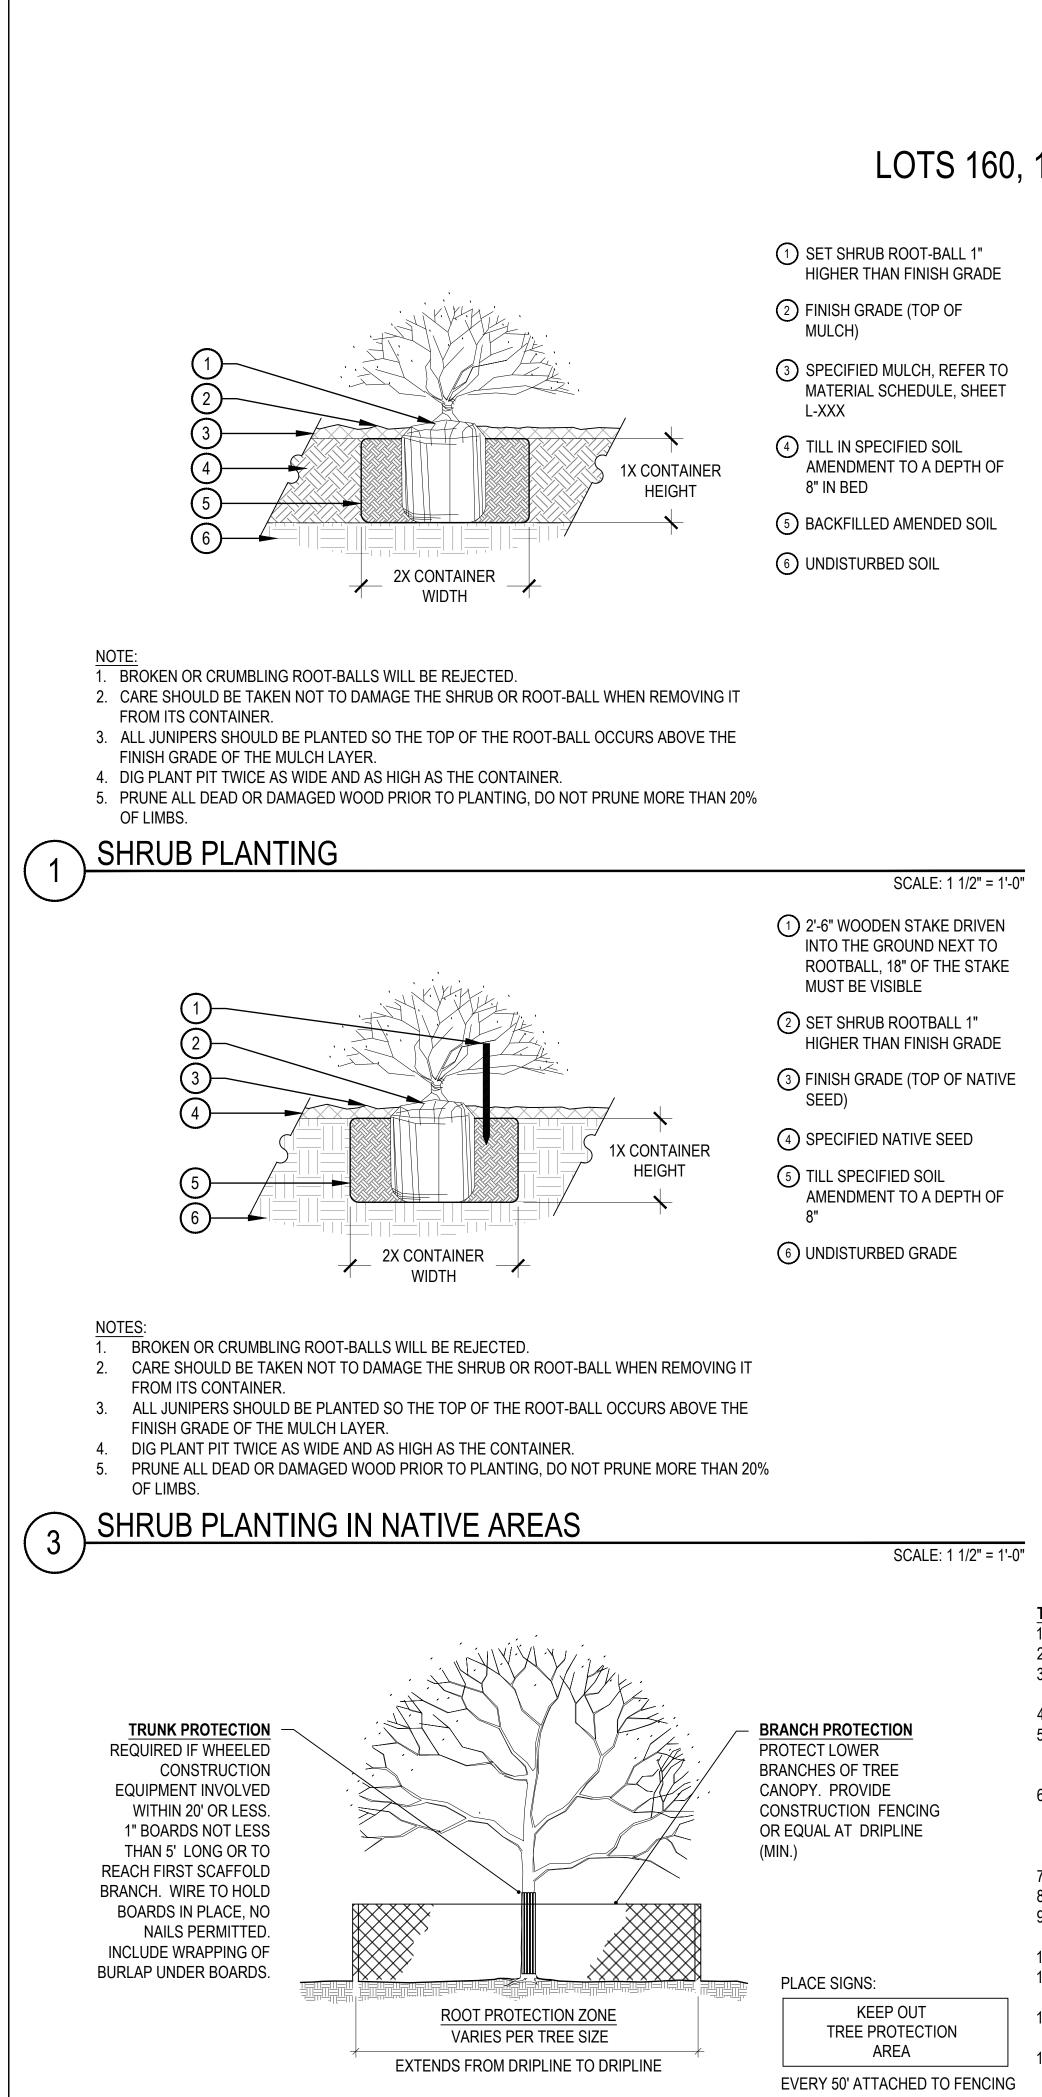
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06.17.22 - SITE PLAN 01

SHEET TITLE: LANDSCAPE PLAN




6

FREE AND SHRUB PROTECTION

POSITION THROUGHOUT THE DURATION OF CONSTRUCTION ACTIVITIES. 12. ANY GRADE CHANGES (SUCH AS THE REMOVAL OF TOPSOIL OR ADDITION OF FILL MATERIAL) WITHIN THE DRIP LINE SHOULD BE AVOIDED FOR EXISTING TREES TO REMAIN. RETAINING WALLS AND TREE WELLS ARE ACCEPTABLE ONLY WHEN CONSTRUCTED PRIOR TO GRADE CHANGE. 13. REFER TO PLANS FOR FENCE STAKING LOCATIONS.

WILLOUGHBY CORNER SITE PLAN - PHASE 1

LOTS 160, 161, 164, 165, 166 & 167, & OUTLOTS F, I, J & K OF THE WILLOUGHBY CORNER SUBDIVISION, CITY OF LAFAYETTE, COUNTY OF BOULDER, STATE OF COLORADO

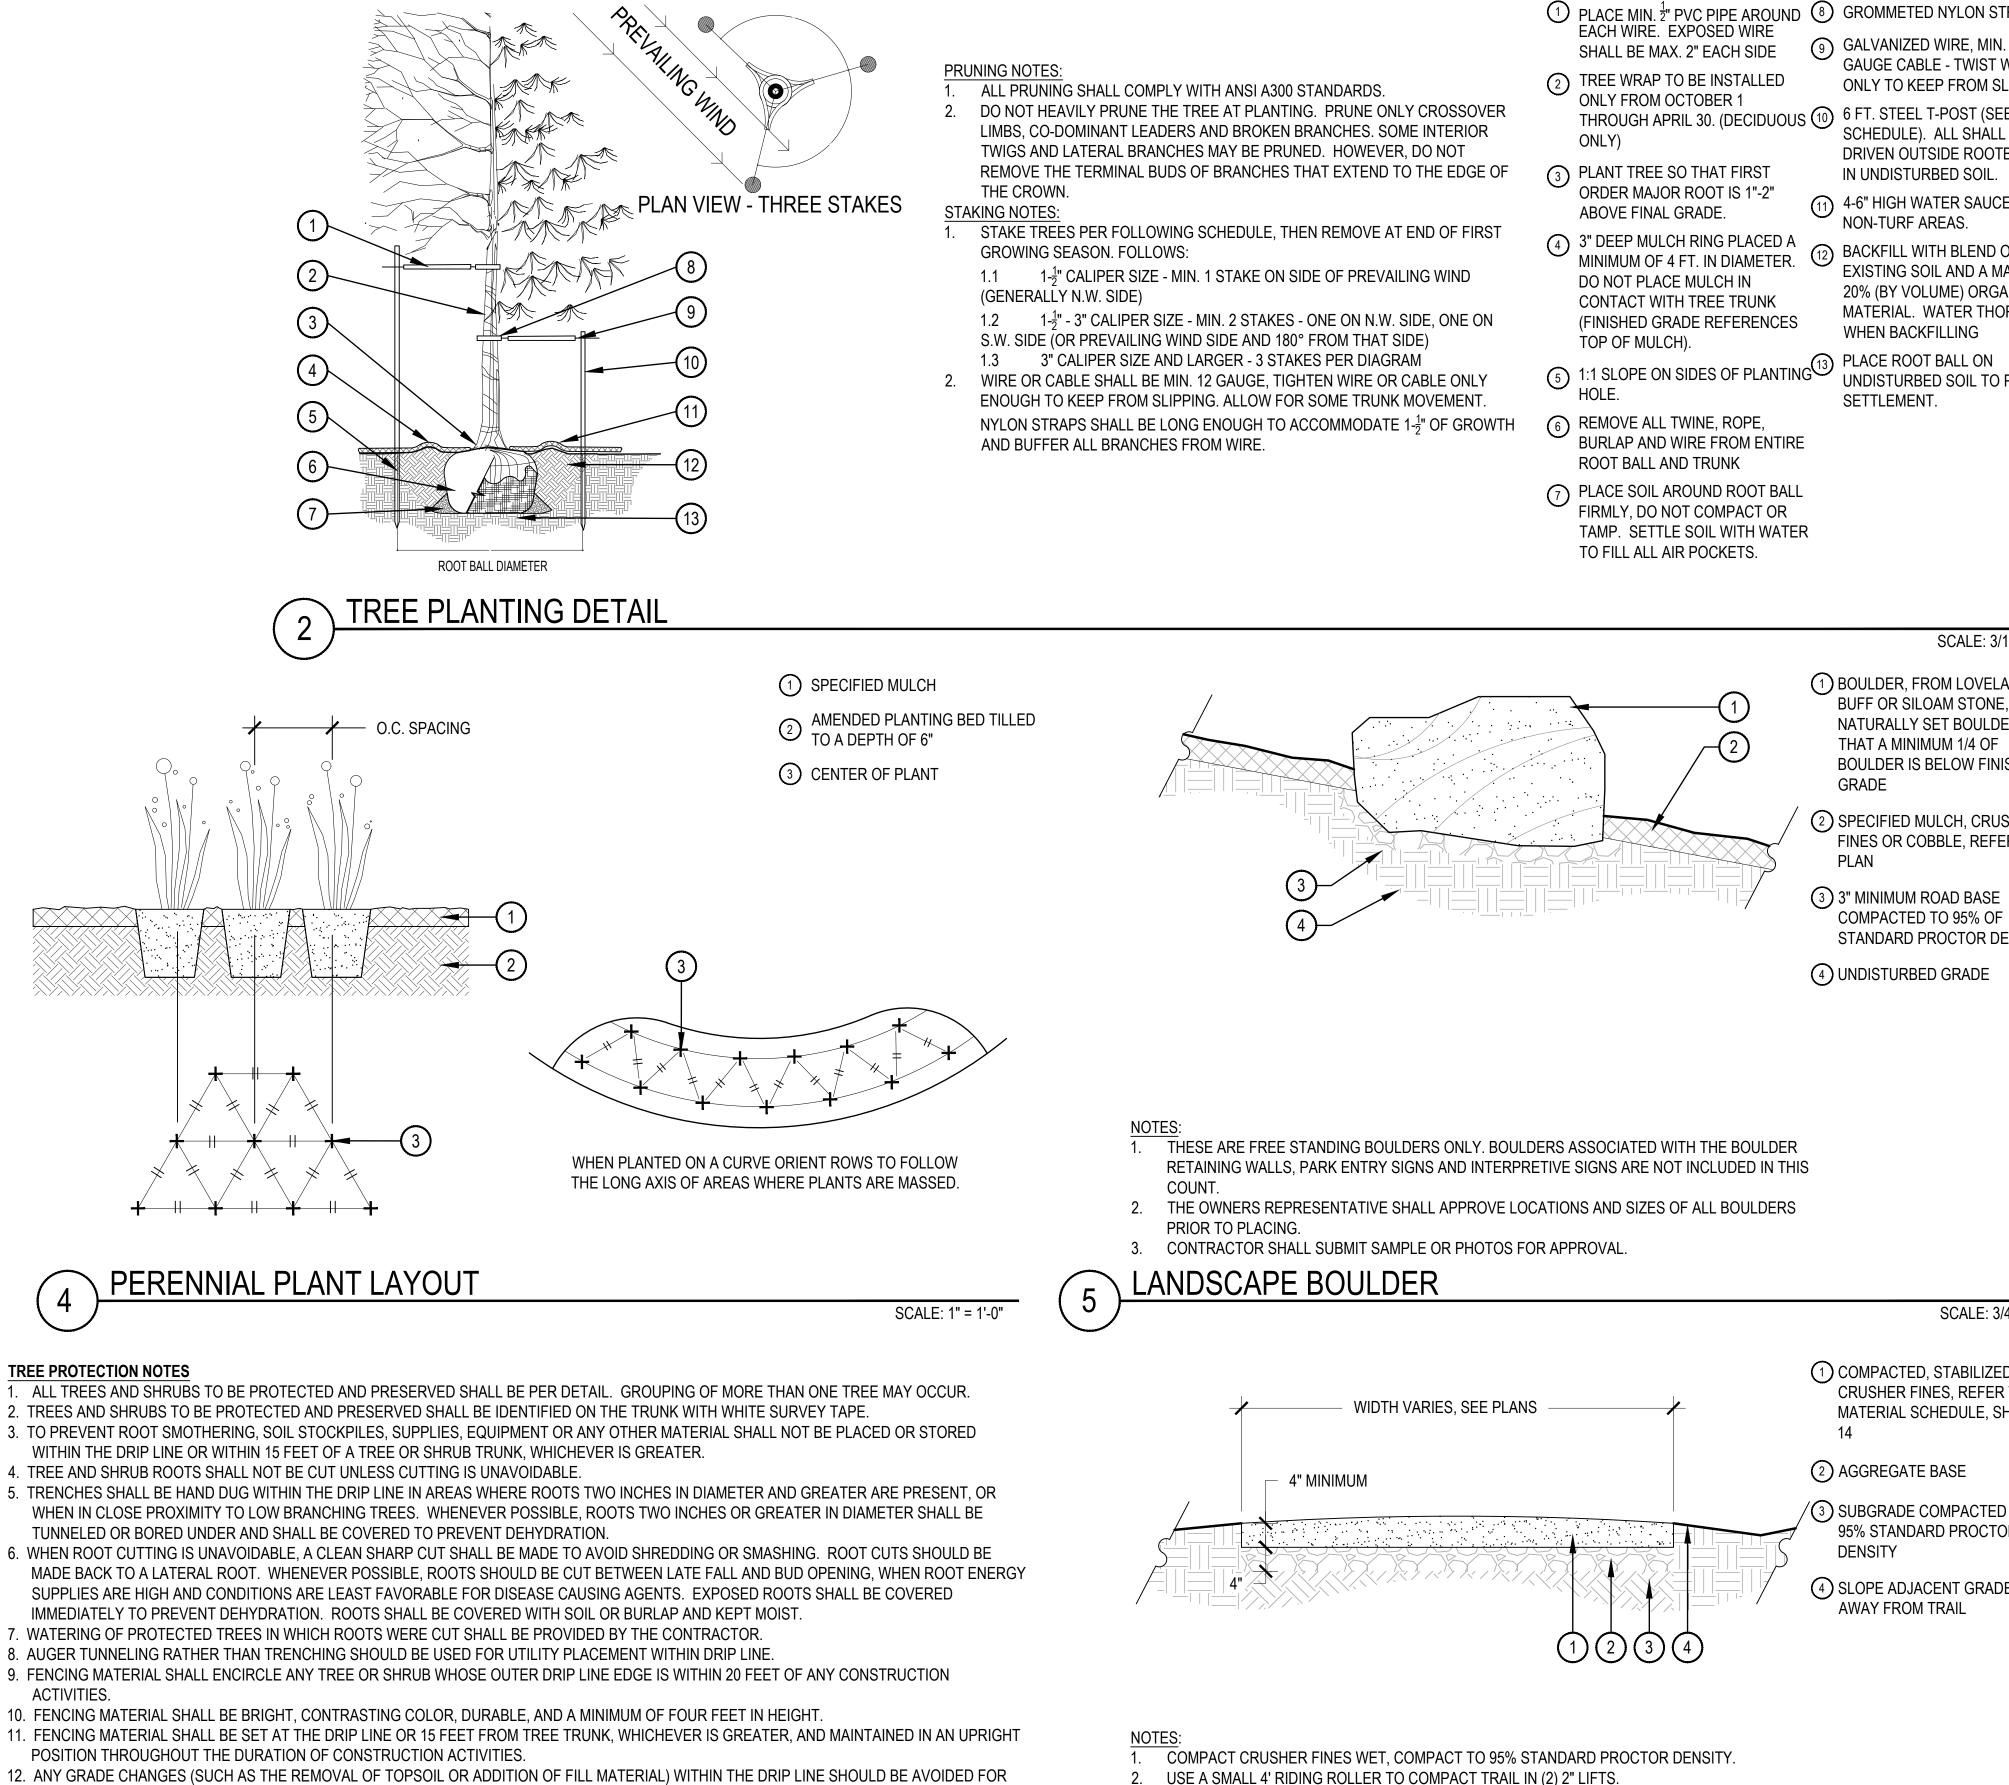

CRUSHER FI

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- 1 PLACE MIN. ¹/₂" PVC PIPE AROUND 8 GROMMETED NYLON STRAPS
- THROUGH APRIL 30. (DECIDUOUS (10) 6 FT. STEEL T-POST (SEE
- MINIMUM OF 4 FT. IN DIAMETER. (FINISHED GRADE REFERENCES
- BURLAP AND WIRE FROM ENTIRE
- 7 PLACE SOIL AROUND ROOT BALL TAMP. SETTLE SOIL WITH WATER

- (9) GALVANIZED WIRE, MIN. 12 GAUGE CABLE - TWIST WIRE ONLY TO KEEP FROM SLIPPING.
- SCHEDULE). ALL SHALL BE DRIVEN OUTSIDE ROOTBALL AND IN UNDISTURBED SOIL
- (11) 4-6" HIGH WATER SAUCER IN NON-TURF AREAS.
- 12 BACKFILL WITH BLEND OF EXISTING SOIL AND A MAXIMUM 20% (BY VOLUME) ORGANIC MATERIAL. WATER THOROUGHLY WHEN BACKFILLING

JNDISTURBED SOIL TO PREVENT SETTLEMENT


SCALE: 3/16" = 1'-0"

- 1) BOULDER, FROM LOVELAND BUFF OR SILOAM STONE, NATURALLY SET BOULDER SO THAT A MINIMUM 1/4 OF **BOULDER IS BELOW FINISH** GRADE
- (2) SPECIFIED MULCH, CRUSHER FINES OR COBBLE, REFER TO PLAN
- (3) 3" MINIMUM ROAD BASE COMPACTED TO 95% OF STANDARD PROCTOR DENSITY
- (4) UNDISTURBED GRADE



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	SCALE: 3/4" = 1'-0"	
WIDTH VARIES, SEE PLANS	1 COMPACTED, STABILIZED CRUSHER FINES, REFER TO MATERIAL SCHEDULE, SHEET 14	DATE: 06.17.22 - SITE PLAN 01
- 4" MINIMUM	2 AGGREGATE BASE	
	 3 SUBGRADE COMPACTED TO 95% STANDARD PROCTOR DENSITY 4 SLOPE ADJACENT GRADE AWAY FROM TRAIL 	
DTES: COMPACT CRUSHER FINES WET, COMPACT TO 95% STANDARD PROCTOR DENSITY. USE A SMALL 4' RIDING ROLLER TO COMPACT TRAIL IN (2) 2" LIFTS. CROWN OF 2% IN FLAT AREAS AS SHOWN. CROSS SLOPE TRAIL AT 1-2% WITH GRADE WHERE TOPOGRAPHY DICTATES.	~~~~	SHEET TITLE: LANDSCAPE DETAILS
APPLY STABILIZER/TACKIFIER TO CRUSHER FINES SURFACE.	SCALE: 3/4	20

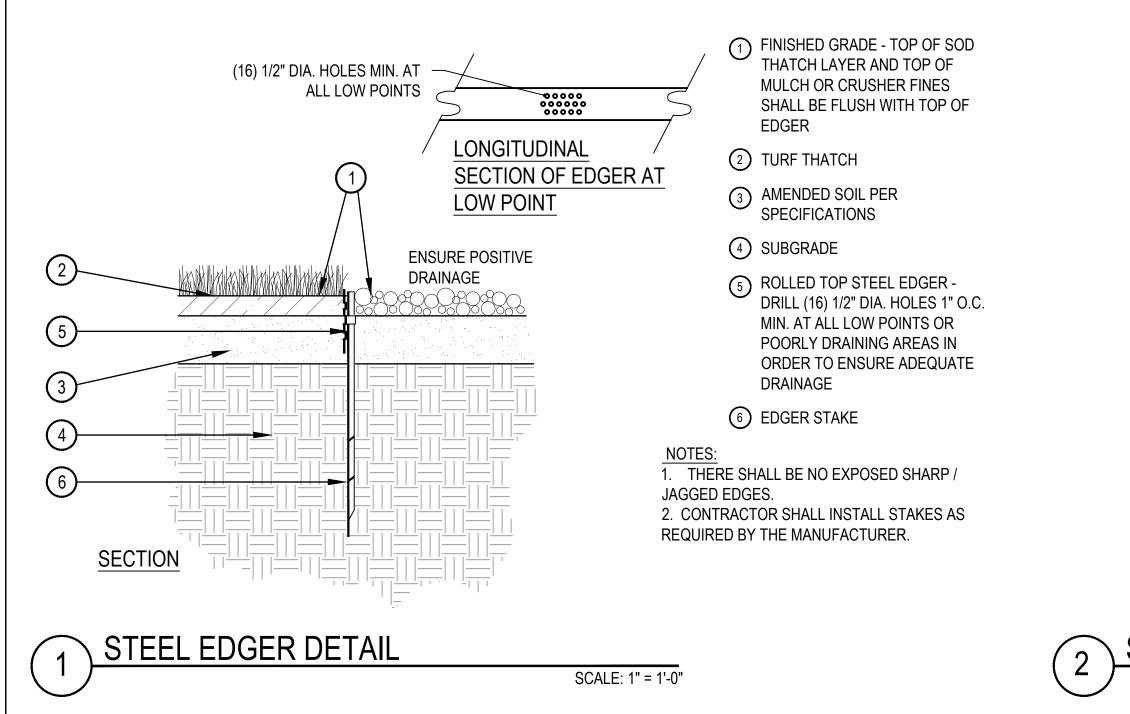

WILLOUGHBY CORNER SITE PLAN - PHASE 1

LOTS 160, 161, 164, 165, 166 & 167, & OUTLOTS F, I, J & K OF THE WILLOUGHBY CORNER SUBDIVISION, CITY OF LAFAYETTE, COUNTY OF BOULDER, STATE OF COLORADO


1 TURFGRASS OR DYLAND SEED

(2) IRRIGATION HEADS SHOULD BE LOCATED ADJACENT TO MULCH BEDS, OFFSET HEAD INTO GRASS AREA TO ENSURE STABLE SUPPORT

3 PLANTING BED

4 VERTICAL SPADE CUT EDGE FILLED WITH SPECIFIED MULCH, TAPER EDGE OF BED SO MULCH IS DEEPER AGAINST SPADED EDGE

5 SPECIFIED DEPTH OF MULCH, TYPICALLY WOOD MULCH 3"-4" DEEP

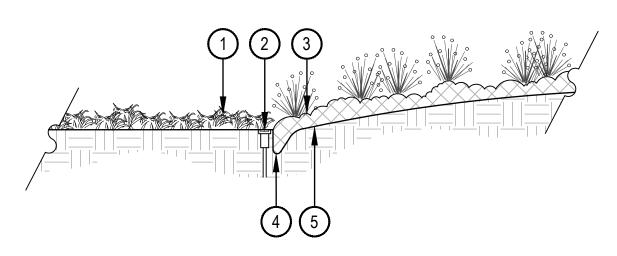

SPADE CUT EDGE

SCALE: 1/2" = 1'-0"



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CORNER WILLOUGHBY SITE PLAN- PHASE 1 LAFAYETTE, COLORADO

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06.17.22 - SITE PLAN 01

DATE:

SHEET TITLE: LANDSCAPE DETAILS



IRRIGATION POINT OF CONNECTION NOTES

- POINT OF CONNECTION: THERE IS TWO (2) POINTS OF CONNECTION ON THIS PROJECT POC #1 : X" DEDICATED IRRIGATION WATER METER LOCATED AT (EDIT LOCATION HERE). THE PLANS. CONTRACTOR IS TO LOCATE AND CONNECT DOWNSTREAM OF THE DEDICATED POTABLE IRRIGATION WATER METER (PROVIDED THE CONTRACTOR SHALL COORDINATE AS NECESSARY WITH THE GENERAL CONTRACTOR AND OWNER'S REPRESENTATIVE FOR BY OTHERS) WITH TYPE K COPPER AT A DEPTH OF 48" OR PER LOCAL CODE, WHICHEVER IS GREATER. EXTEND COPPER TO SUCCESSFUL COMPLETION OF THIS WORK BACKFLOW PREVENTION UNIT. EXTEND COPPER TUBING MINIMUM 30" HORIZONTAL FROM BACKFLOW PREVENTER AND INSTALL ONE MANUAL DRAIN, TRANSITION TO AND EXTEND CLASS 200 PVC MAINLINE TO THE 1" QUICK COUPLER, MASTER VALVE, FLOW SENSOR, GATE VALVE, AND EXTEND MAINLINE TO VALVES AS SHOWN. NOTIFYING THE OWNER'S REPRESENTATIVE. ALL PIPING FROM THE DEDICATED IRRIGATION POTABLE METER THROUGH DRAIN VALVE DOWNSTREAM OF THE BACKFLOW PREVENTION UNIT SHALL BE THE SAME SIZE AS THE METER UNLESS OTHERWISE NOTED. THE CONTRACTOR SHALL CONFORM TO ALL LOCAL CODES, OBTAIN AND PROVIDE PAYMENT FOR ALL PERMITS ASSOCIATED WITH THIS WORK. FINAL LOCATION OF BACKFLOW PREVENTION UNIT SHALL BE APPROVED BY THE OWNER'S REPRESENTATIVE PRIOR TO INSTALLATION. 2. CONTROLLER LOCATION: THERE IS TWO (2) CONTROLLERS ON THIS PROJECT **IMMEDIATELY** CONTROLLER A : PEDESTAL MOUNTED CONTROLLER LOCATED (EDIT LOCATION HERE). CONTROLLER SHALL BE PROGRAMMED TO RUN MULTIPLE VALVES AT ONE TIME WITH A MAXIMUM TOTAL OF TBD GPM CONTROLLER. TO BE MOUNTED PER DETAILS AND MANUFACTURER'S SPECIFICATIONS WORK ASSOCIATED WITH SAID DAMAGES. CONTRACTOR TO COORDINATE WITH OWNER'S REPRESENTATIVE AND ELECTRICAL PLANS FOR POWER SERVICE. ALL ELECTRICAL EQUIPMENT AND POWER CONNECTION INSTALLATION SHALL CONFORM TO ALL LOCAL CODES. INSTALL A LINE VOLTAGE SURGE DEVICE (INTERMATIC AG2401C3/ OR SQUARE D SDSA1175) FOR 120V IN A JUNCTION BOX PRIOR TO CONTROLLER. RAIN/FREEZE SENSOR: MOUNT THE RAIN SENSOR ON BUILDING EAVE / POLE IN PROXIMITY TO THE CONTROLLER. THE SENSOR SHALL BE MOUNTED IN A LOCATION IN FULL SUN AND OPEN TO RAINFALL. SENSOR SHALL BE NO MORE THAN 200' FROM WIRELESS RECEIVER. MOUNT WIRELESS RECEIVER ON OR ADJACENT TO THE IRRIGATION CONTROLLER. CONTROLLER B : PEDESTAL MOUNTED CONTROLLER LOCATED (EDIT LOCATION HERE). ACCEPTANCE CONTROLLER SHALL BE PROGRAMMED TO RUN MULTIPLE VALVES AT ONE TIME WITH A MAXIMUM TOTAL OF TBD GPM CONTROLLER, TO BE MOUNTED PER DETAILS AND MANUFACTURER'S SPECIFICATIONS. CONTRACTOR TO COORDINATE WITH OWNER'S REPRESENTATIVE AND ELECTRICAL PLANS FOR POWER SERVICE. ALL ELECTRICAL EQUIPMENT AND POWER CONNECTION INSTALLATION SHALL CONFORM TO ALL LOCAL CODES. INSTALL A LINE VOLTAGE SURGE DEVICE (INTERMATIC AG2401C3/ OR SQUARE D SDSA1175) FOR 120V IN A JUNCTION BOX PRIOR TO CONTROLLER. AND ITS COMPONENTS RAIN/FREEZE SENSOR: MOUNT THE RAIN SENSOR ON BUILDING EAVE / POLE IN PROXIMITY TO THE CONTROLLER. THE SENSOR 10 SHALL BE MOUNTED IN A LOCATION IN FULL SUN AND OPEN TO RAINFALL. SENSOR SHALL BE NO MORE THAN 200' FROM WIRELESS RECEIVER. MOUNT WIRELESS RECEIVER ON OR ADJACENT TO THE IRRIGATION CONTROLLER SYSTEM PRESSURE: THE SYSTEM HAS BEEN DESIGNED PER THE FOLLOWING SPECIFICATIONS: REQUIRED MINIMUM STATIC ALL REQUIRED SETBACKS WITH OWNER'S REPRESENTATIVE PRIOR TO START OF WORK. PRESSURE OF TBD PSI AND MAXIMUM SAFE VELOCITY OF 5 FPS IN ANY PVC PIPE AND 7.5 FPS IN ANY COPPER PIPE PER (WATER PURVEYOR/CITY WATER) THE STATIC PRESSURE ON SITE IS APPROXIMATELY XX_PSI. THE CONTRACTOR IS RESPONSIBLE FOR VERIFYING THE PRESSURE IN THE FIELD AT THE POINT OF CONNECTION BEFORE DETAILS. DO NOT INSTALL IN PAVED AREAS OR IN BOTTOMS OF DRAINAGE SWALES/BASINS. CONSTRUCTION BEGINS AND FOR NOTIFYING THE OWNER'S REPRESENTATIVE OF ANY DISCREPANCY BETWEEN THE DESIGN PRESSURE OF THE SYSTEM AND THE MEASURED PRESSURE IN THE FIELD. IF THE CONTRACTOR FAILS TO NOTIFY OWNER'S TRENCHES. SEE IRRIGATION DETAILS FOR MORE INFORMATION. REPRESENTATIVE OF SUCH DISCREPANCIES, THEN THE CONTRACTOR ASSUMES ALL LIABILITY AND COSTS ASSOCIATED WITH SYSTEM MODIFICATIONS TO ACCOMMODATE THE ACTUAL PRESSURE FLOW SENSOR: SENSOR REQUIRES A MINIMUM FLOW FOR PROPER READINGS. MULTIPLE ZONES MAY BE REQUIRED TO RUN 14. THE CONTRACTOR SHALL MARK THE LOCATION OF THE MAINLINE, CONTROL VALVES, GATE VALVES AND HEAD LAYOUT OF A SIMULTANEOUSLY TO ACHIEVE THE MINIMUM FLOWS REQUIRED. CONTRACTOR TO SET 'K' VALUES PER MANUFACTURER. 4. FLOW SENSOR TBD REQUIRES A MINIMUM FLOW OF TBD GPM. 5. COMMUNICATION: IT IS RECOMMENDED THAT THE IRRIGATION CONTROLLER BE CONNECTED TO A WATER MANAGEMENT CONTROL THOROUGHLY BEFORE INSTALLING EMITTERS AND BUBBLERS. SOFTWARE FOR OPTIMUM FUNCTION OF THE IRRIGATION SYSTEM. COORDINATE WITH OWNER'S REPRESENTATIVE AND CONTACT THE LOCAL CONTROLLER MANUFACTURER REPRESENTATIVE OR AUTHORIZED VENDOR PRIOR TO ORDERING CONTROLLER FOR SURFACES. COMMUNICATION AND CONNECTIVITY OPTIONS. ON PLANS, FOR WINTERIZATION AND FLUSHING OF MAINLINE. TWO WIRE NOTES 1. GROUNDING FOR THE IRRIGATION CONTROLLER AND DECODERS ARE TO BE INSTALLED PER THE MANUFACTURER'S SPECIFICATIONS AND PER THE AMERICAN SOCIETY OF IRRIGATION CONSULTANTS GUIDELINE 100-2002 FOR EARTH GROUNDING ELECTRONIC EQUIPMENT IN IRRIGATION SYSTEMS FOUND AT WWW.ASIC.ORG. FOR ADDITIONAL TECHNICAL SUPPORT REGARDING THE IRRIGATION CONTROLLER OR GROUNDING PLEASE CONTACT THE MANUFACTURER. DO NOT LOOP TWO WIRE PATH. STAR PATTERN FROM CONTROLLER FOR EACH BRANCH OF MAINLINE. 3. CONTRACTOR IS RESPONSIBLE FOR GROUNDING THE TWO-WIRE PATH AT THE FOLLOWING LOCATIONS. BUT ARE NOT LIMITED TO: ACCEPTANCE. CONTROLLER TO BE GROUNDED INDEPENDENTLY FROM BUILDING. GROUND 1ST DECODER ON WIRE PATH FROM CONTROLLER. FIGURES WILL NEED TO BE ADJUSTED DUE TO SEASONAL CHANGES AND VARIABLE WEATHER CONDITIONS. GROUND EVERY 8TH DECODER OR EVERY 500 FEET BETWEEN DECODERS. WHICH EVER LENGTH IS SMALLER. • FESCUE/BLUEGRASS BLEND TURF 1.75" PER WEEK PEAK SEASON GROUND EVERY END OF WIRE PATH. TREE. SHRUB. AND PERENNIAL PLANT MATERIAL 1.00" PER WEEK PEAK SEASON 4. THE TWO-WIRE CONTROLLER REQUIRES EACH CONTROL VALVE AND SENSOR TO HAVE A DECODER. IT IS THE RESPONSIBILITY OF NATIVE DRAUGHT TOLERANT SEED MIX 0.75" PER WEEK PEAK SEASON THE CONTRACTOR TO PROVIDE THE PROPER DECODERS, SURGE SUPPRESSION AND GROUNDING. THE RAIN SENSOR AND FLOW SENSOR REQUIRE A SENSOR DECODER. INCLUDE BUT IS NOT LIMITED TO THE FOLLOWING LIST OF BEST MANAGEMENT PRACTICES: 5. QTY OF STATIONS (VALVES) PER MANIFOLD REQUIRED DECODER CHECK HEADS FOR COVERAGE AND LEAKAGE. SINGLE STATION ICD-100 (HUNTER) CHECK CONTROLLER PROGRAMMING AND ADJUST FOR SEASONAL CHANGES AS NECESSARY. FLOW SENSOR ICD-SEN (HUNTER) VERIFY THAT THE WATER SUPPLY AND PRESSURE ARE AS STATED IN THE DESIGN. 6. CONTROLLER TWO-WIRE PATH SHALL BE MANUFACTURER'S APPROVED WIRE OR APPROVED EQUAL. CERTIFY THE BACKFLOW PREVENTION DEVICE AND SUBMIT TEST RESULTS TO THE PROPERTY MANAGER. 7. CONTRACTOR SHALL USE UL APPROVED WIRE STRIPPER AND WATERPROOF CONNECTIONS (DBR/Y OR APPROVED EQUAL) AT ALL PERIODICALLY VERIFY THE THE SENSORS IN THE IRRIGATION SYSTEM ARE OPERATING CORRECTLY SPLICES AND CONNECTIONS POINTS. WINTERIZATION AND SPRING START UP PROCEDURES. 8. PROVIDE 30" MINIMUM TWO WIRE PATH IN EACH VALVE BOX FOR MAINTENANCE. CONTRACTOR SHALL INCLUDE TWO-WIRE RUN PATHS ON AS-BUILT DRAWINGS. SLEEVING COORDINATION NOTES INSTALLATION OF IRRIGATION SLEEVING IS THE RESPONSIBILITY OF THE GENERAL CONTRACTOR. THE GENERAL CONTRACTOR SHALL COORDINATE WITH THE IRRIGATION CONTRACTOR FOR LOCATION AND SIZING OF SLEEVES PRIOR TO THE START OF CONSTRUCTION. SLEEVES SHALL BE INSTALLED PRIOR TO THE START OF PAVING OPERATIONS. 2. THE CONTRACTOR SHALL SLEEVE ALL IRRIGATION DISTRIBUTION LINES, VALVE CONTROL WIRES AND COMMUNICATION WIRES UNDER ALL PAVED SURFACES, WALL FOOTERS, DRAINAGE CHANNELS, INLETS, CATCH BASINS, ETC. ALL SLEEVES SHALL EXTEND A MINIMUM OF 12" BEYOND EDGE OF ALL OBSTRUCTIONS. NO TEES, ELLS OR OTHER TURNS IN PIPING 4. SHALL BE LOCATED UNDER ANY OBSTRUCTIONS. EACH PIPE SHALL BE IN A SEPARATE SLEEVE. WIRES SHALL BE IN A SEPARATE PIPE UNDER ALL PAVED SURFACES. SLEEVING SHALL BE INSTALLED PER THE SIZES AND QUANTITIES SHOWN ON THE PLANS BASED ON THE CHART BELOW 6. PIPING REQUIRED SLEEVE SIZE X" CLASS 200 PVC MAINLINE PIPING
- CHECKED B' DRAWN BY:

LATERAL PIPING

CONTROL WIRES

2X NOMINAL DIAMETER OF LATERAL

2" CLASS 200 PVC

××

WILLOUGHBY CORNER SITE PLAN - PHASE 1

IRRIGATION GENERAL NOTES

1. THE CONTRACTOR SHALL PROVIDE ALL LABOR, MATERIALS AND EQUIPMENT NECESSARY TO INSTALL THE IMPROVEMENTS SHOWN ON

ALL IRRIGATION EQUIPMENT IS TO BE AS SPECIFIED OR APPROVED EQUAL PER THE DISCRETION OF THE OWNER'S REPRESENTATIVE THE CONTRACTOR ASSUMES ALL LIABILITY ASSOCIATED WITH THE MODIFICATION OF THE IRRIGATION SYSTEM DESIGN WITHOUT

IT IS THE CONTRACTOR'S RESPONSIBILITY TO CONDUCT A THOROUGH SITE INSPECTION AND REVIEW OF THE PROJECT CONSTRUCTION DOCUMENTS INCLUDING BUT NOT LIMITED TO THE FOLLOWING: LANDSCAPE PLAN, UTILITY PLAN, CIVIL UTILITY PLAN, ARCHITECTURE PLAN, GRADING AND DRAINAGE PLAN AND ALL OTHER ASSOCIATED PLANS AND SPECIFICATIONS THAT AFFECT THIS WORK PRIOR TO START OF WORK. IF THE AND CONTRACTOR OBSERVES ANY DISCREPANCIES AMONG THE CONSTRUCTION DOCUMENTS AND THE EXISTING CONDITIONS ON SITE, IT IS THEIR RESPONSIBILITY TO CONTACT THE OWNER'S REPRESENTATIVE

THE CONTRACTOR MUST VERIFY THE LOCATION OF ALL PUBLIC AND PRIVATE UNDERGROUND UTILITIES PRIOR TO CONSTRUCTION. IF THE CONTRACTOR FAILS TO DO SO AND DAMAGES ANY UNDERGROUND UTILITIES. THE CONTRACTOR SHALL PAY FOR ANY REPAIR

6. IT IS THE CONTRACTOR'S RESPONSIBILITY TO ENSURE ADEQUATE VERTICAL AND HORIZONTAL SEPARATION BETWEEN ALL IRRIGATION DISTRIBUTION LINES AND ALL UTILITIES (EXISTING OR PROPOSED), CONDUIT, STORM WATER COMPONENTS, DRAINS, ETC. THE CONTRACTOR SHALL CONFORM TO ALL LOCAL AND STATE REGULATIONS AND INSTALL THE IRRIGATION SYSTEM AND ITS COMPONENTS PER MANUFACTURER'S SPECIFICATIONS. THE CONTRACTOR SHALL OBTAIN AND PROVIDE PAYMENT FOR ALL PERMITS REQUIRED BY ANY LOCAL AND STATE AGENCIES AND UTILITY COMPANIES HAVING JURISDICTION OVER THIS SITE THE CONTRACTOR IS RESPONSIBLE FOR SCHEDULING AND PAYING FOR CERTIFICATION OF THE BACKFLOW PREVENTER BY A STATE CERTIFIED INSPECTOR. THE CONTRACTOR SHALL PROVIDE CERTIFICATES TO OWNER'S REPRESENTATIVE PRIOR TO PROJECT

9. IT IS THE INTENT OF THIS DESIGN THAT ALL IRRIGATION EQUIPMENT BE INSTALLED WITHIN LANDSCAPE AREAS AND WITHIN THE PROJECT LIMITS. EQUIPMENT SHOWN OUTSIDE OF THESE LIMITS IS SHOWN FOR GRAPHIC CLARITY ONLY. IF THERE IS A QUESTION REGARDING THE LOCATION OF ANY COMPONENT OF THE IRRIGATION SYSTEM, IT IS THE CONTRACTOR'S RESPONSIBILITY TO CONTACT THE OWNER'S REPRESENTATIVE. IF THE CONTRACTOR NEGLECTS TO NOTIFY THE NECESSARY PARTIES, THE CONTRACTOR SHALL PAY FOR ANY REPLACEMENT OR MODIFICATION TO ENSURE PROPER LOCATION AND OPERATION OF THE IRRIGATION SYSTEM

ALL IRRIGATION DISTRIBUTION LINES AND EQUIPMENT INCLUDING BUT NOT LIMITED TO, MAINLINE, LATERALS, SPRAY HEADS, DRIP EMITTERS SHALL BE KEPT A MINIMUM DISTANCE OF 6' AWAY FROM ALL BUILDING AND WALL FOUNDATIONS, OR AS STIPULATED IN THE GEOTECHNICAL REPORT, WHICHEVER IS GREATER. EQUIPMENT MAY BE SHOWN IN THIS AREA FOR GRAPHIC CLARITY. COORDINATE

11. EACH VALVE SHALL BE INSTALLED IN A SEPARATE VALVE BOX AS DETAILED. ALL VALVE BOXES AND LIDS SHALL BE COMMERCIAL GRADE. PLASTIC WITH SELF LOCKING COVERS. LID COLOR TO BE GREEN. INSTALL FLUSH TO FINISH GRADE AND PER CONSTRUCTION

12. CONTRACTOR SHALL INSTALL DETECTABLE MARKING TAPE OR #14g DIRECT BURY TRACER WIRE IN ALL PRESSURE MAINLINE

13. PLANT MATERIAL LOCATIONS TAKE PRECEDENCE OVER ROUTING OF IRRIGATION PIPING. COORDINATE INSTALLATION OF IRRIGATION EQUIPMENT SO THAT IT DOES NOT INTERFERE WITH THE PLANTING OF TREES OR OTHER LANDSCAPE MATERIAL

REPRESENTATIVE SPRAY ZONE. SCHEDULE A REVIEW WITH THE OWNER'S REPRESENTATIVE PRIOR TO INSTALLATION. 15. INSTALL SCH. 40 BALL WITH OPERATIONAL INDICATOR AT ENDS OF ALL DRIP LATERALS AS DETAILED. FLUSH ALL LATERALS

16. CONTRACTOR SHALL FINE TUNE AND ADJUST NOZZLE DIRECTION AND RADIUS TO REDUCE OVERSPRAY ONTO PAVING OR HARD

17. CONTRACTOR SHALL INSTALL A QUICK COUPLER IN 10" VALVE BOX AT THE END OF ALL BRANCHES OF THE MAINLINE, OR AS SHOWN

18. THE CONTRACTOR SHALL PERFORM A PRESSURE TEST ON ALL MAINLINES. CONTRACTOR SHALL PRESSURIZE MAINLINES TO 120 PSI AND MAINTAIN PRESSURE AT 120 PSI FOR A MINIMUM CONTINUOUS PERIOD OF TWO (2) HOURS TO ACHIEVE FINAL ACCEPTANCE. 19. THIS IRRIGATION SYSTEM HAS BEEN DESIGNED TO OPERATE DURING A THREE(3) NIGHT PER WEEK, SIXTEEN(16) HOURS PER NIGHT WATERING WINDOW. DRIP IRRIGATION ZONES MAY BE ALLOWED TO RUN ON A SEPARATE SCHEDULE FROM THIS WATER WINDOW DEPENDING JURISDICTION. LANDSCAPE ESTABLISHMENT WILL REQUIRE INCREASED IRRIGATION WATER FOR DURATION OF THE ESTABLISHMENT PERIOD AND MAY REQUIRE TWICE THE AMOUNT OF WATER AS ESTABLISHED PLANT MATERIAL. THE CONTRACTOR SHALL COORDINATE WATERING SCHEDULES AND APPLICATION RATES WITH THE OWNER'S REPRESENTATIVE PRIOR TO FINAL

20. THE DESIGN IS BASED ON THE FOLLOWING PROJECTED PEAK SEASON WEEKLY APPLICATION RATES AFTER ESTABLISHMENT. THESE

21. THE CONTRACTOR SHALL PROVIDE A SEASONAL MAINTENANCE SCHEDULE WHICH SHALL BEGIN ON APRIL 15TH AND END ON OCTOBER 15TH TO ENSURE THE EFFICIENCY AND LONGEVITY OF THE IRRIGATION SYSTEM. THE MAINTENANCE SCHEDULE SHALL

	DESCRIPTION	MODEL NO. DESCRIPTION			ETAIL D SHEE	
М	IRRIGATION METER	TBD" DEDICATED IRRIGATION ME REFER TO CIVIL, UTILITY, AND WA			NA	NA
С	IRRIGATION CONTROLLER	TBD MODEL 120VAC POWER REQUIRED - SEE	PLANS FOR LOCATIO	DN(S)	TBD	TBC
¢	RAIN SENSOR	HUNTER WSS-SEN OR SOLAR-SYN	NC-SEN REFER TO C	ONTROLLER NOTES	TBD	TBD
	BACKFLOW PREVENTER	FEBCO TBD" 825YA SEE ENCLOSURE SPECIFICATIONS	S BELOW		TBD	TBD
NOT SHOWN	SECURITY ENCLOSURE	GUARD SHACK GS-TBD LIFT OFF I WITH FROSTGUARD BLANKET, PO	ENCLOSURE	EST GREEN	TBD	TBE
0	MANUAL DRAIN VALVE	MATCO-NORCA 3/4" 201X INSTALLED IN AEP 910L-1G2G VAL'	VE BOX		TBD	TBE
0	QUICK COUPLER	RAIN BIRD 44LRC INSTALLED IN AEP 910L-1G2G VAL	VE BOX		TBD	TBI
	MASTER VALVE	HUNTER IBV-TBD SERIES INSTALLED IN AEP 1015-1G2G VAL	VE BOX		TBD	TBI
FS	FLOW SENSOR	FLOWMEC QS-200-XX WITH COMMUNICATION CABLE BA DECODER, INSTALLED IN AEP 101	CK TO CONTROLLEF	R OR ICD-SEN SENSOR	TBD	TBI
M	ISOLATION GATE VALVE	MATCO-NORCA 514TX (2.5" AND S MATCH LINE SIZE, INSTALLED IN A	MALLER)	E BOX	TBD	TBI
•	TURF VALVE ASSEMBLY	HUNTER ICV-G SERIES WITH SCH 40 BALL VALVE, AND ICI 1015-1G2G VALVE BOX, SIZED PER	D-100 / EZ-1 DECODE		TBD	TBI
\oplus	DRIP VALVE ASSEMBLY	HUNTER ICZ-101-LF WITH SCH 40 BALL VALVE, AND ICI 1320-1G2G VALVE BOX, SIZED PER		ER INSTALLED IN AEP	TBD	TB
	GROUNDING / LINE SURGE SUPRESSION	COPPER-CLAD GROUNDING ROD WITH WATERPROOF WIRE CONNE DECODER, INSTALLED IN AEP 9101		SURGE ARRESTING	TBD	TB
IPCORNER ① IP1000 @ ① ② IP2000 @ ③ @ IP3000 @ ④ ④	TURF ROTARY	HUNTER PROS-06-PRS40-CV WITH NOZZLE PER PLAN	HUNTER MP SERIES	S NOZZLE	TBD	TB
STRIP A A 000 D D 015 O O 500 IB	TURF ROTARY (SPECIALTY)	HUNTER PROS-06-PRS40-CV WITH NOZZLE PER PLAN	HUNTER MP SERIES	S NOZZLE	TBD	TB
	TURF SPRAY (FIXED)	HUNTER PROS-06-PRS30-CV WITH NOZZLE PER PLAN	PRO-SPRAY FIXED	SERIES NOZZLE	TBD	TB
8 (0) (2 (5)	TURF SPRAY (ADJUSTABLE)	HUNTER PROS-06-PRS30-CV W/ PF Nozzle Per Plan	RO ADJUSTABLE SE	RIES NOZZLE	TBD	ТВ
	NATIVE ROTOR	HUNTER I-20-12 NOZZLE PER PLAN			TBD	TB
	NATIVE SEED ROTARY	HUNTER PROS-12-PRS40-CV WITH NOZZLE PER PLAN	HUNTER MP SERIES	S NOZZLE	TBD	TB
STRIP (2) (2) (2) 800 (1) (2) 815 (1) (2) 815 (1) (2) 816 (1) (2) 817 (2) (2) 818 (2) 818 (2) (2) 818 (2) 818 (2) (2) 818	NATIVE SEED ROTARY (SPECIALTY)	HUNTER PROS-12-PRS40-CV WITH NOZZLE PER PLAN	HUNTER MP SERIES	S NOZZLE	TBD	TB
×	TREES IN NATIVE	(2) HUNTER PROS-04-PRS30-CV W ASSEMBLIES PER TREE	ITH PCN-XX BUBBLE	ER OR RZWS-18-XX-CB	TBD	TB
Ц	MAINLINE CAP	FUTURE CONNECTION SCH 40 PVC CAP AND 5-FT OF CON VALVE BOX	NTROL WIRE INSTAL	LED IN AEP 910L-1G2G	TBD	TB
	SLEEVING	CLASS 200 PVC REFER TO SLEEVING NOTES			TBD	ТВ
	SERVICE	TYPE K COPPER			TBD	TB
	LINE PVC	SIZE: MATCH POC UNLESS OTHER CLASS 200 PVC BE/RT			TBD	TB
	MAINLINE PVC TURF	SIZE: TBD" UNLESS OTHERWISE N CLASS 200 PVC BE	IOTED		_	
	LATERAL	SIZE: 1" MINIMUM UNLESS OTHER	WISE NOTED		TBD	TB
	PVC TREE LATERAL	SIZE: 1" UNLESS OTHERWISE NOT	ED		TBD	TB
	DRIP LATERAL	UV RESISTANT POLYETHYLENE SIZE: 3/4" MINIMUM UNLESS OTHE			TBD	TB
	FLUSH END CAP	HOSE END FLUSH CAP & OPERAT INSTALLED IN AEP 910L-1G2G VAL	IONAL INDICATOR		TBD	TB
V	ALVE CALLOUT		EMITTER SCH	IEDULE		
	- VALVE/STATION NUMBE	12/011112	EMITTER	QTY.	TOTAL	
	ZONE DESIGNATION: T (TREES), S (SHRUBS),	PERENNIAL / GRASSES	0.5 GPH	TWO EACH	1.0 0	
X - X	G (TURF), N (NATIVE),	DECIDUOUS SHRUBS EVERGREEN SHRUBS	1.0 GPH 1.0 GPH	TWO EACH TWO EACH	2.0 0	
X" XX	X (MISC)	DECIDUOUS TREE	1.0 GPH 1.0 GPH	EIGHT EACH	2.0 0	
		EVERGREEN TREE	1.0 GPH	EIGHT EACH	8.0 0	
	- VALVE SIZE	TREES IN NATIVE	ROOT ZONE	NATERING / TREE RING A	ASSEMBL	.Y

4. RAIN BIRD DBC-025 DIFFUSER BUG CAP AND TS-025 STAKE ON ALL 1/4" DISTRIBUTION TUBING EMISSION POINTS 5. REFER TO DRIP IRRIGATION DETAILS X-X, SHEET LI-XXX



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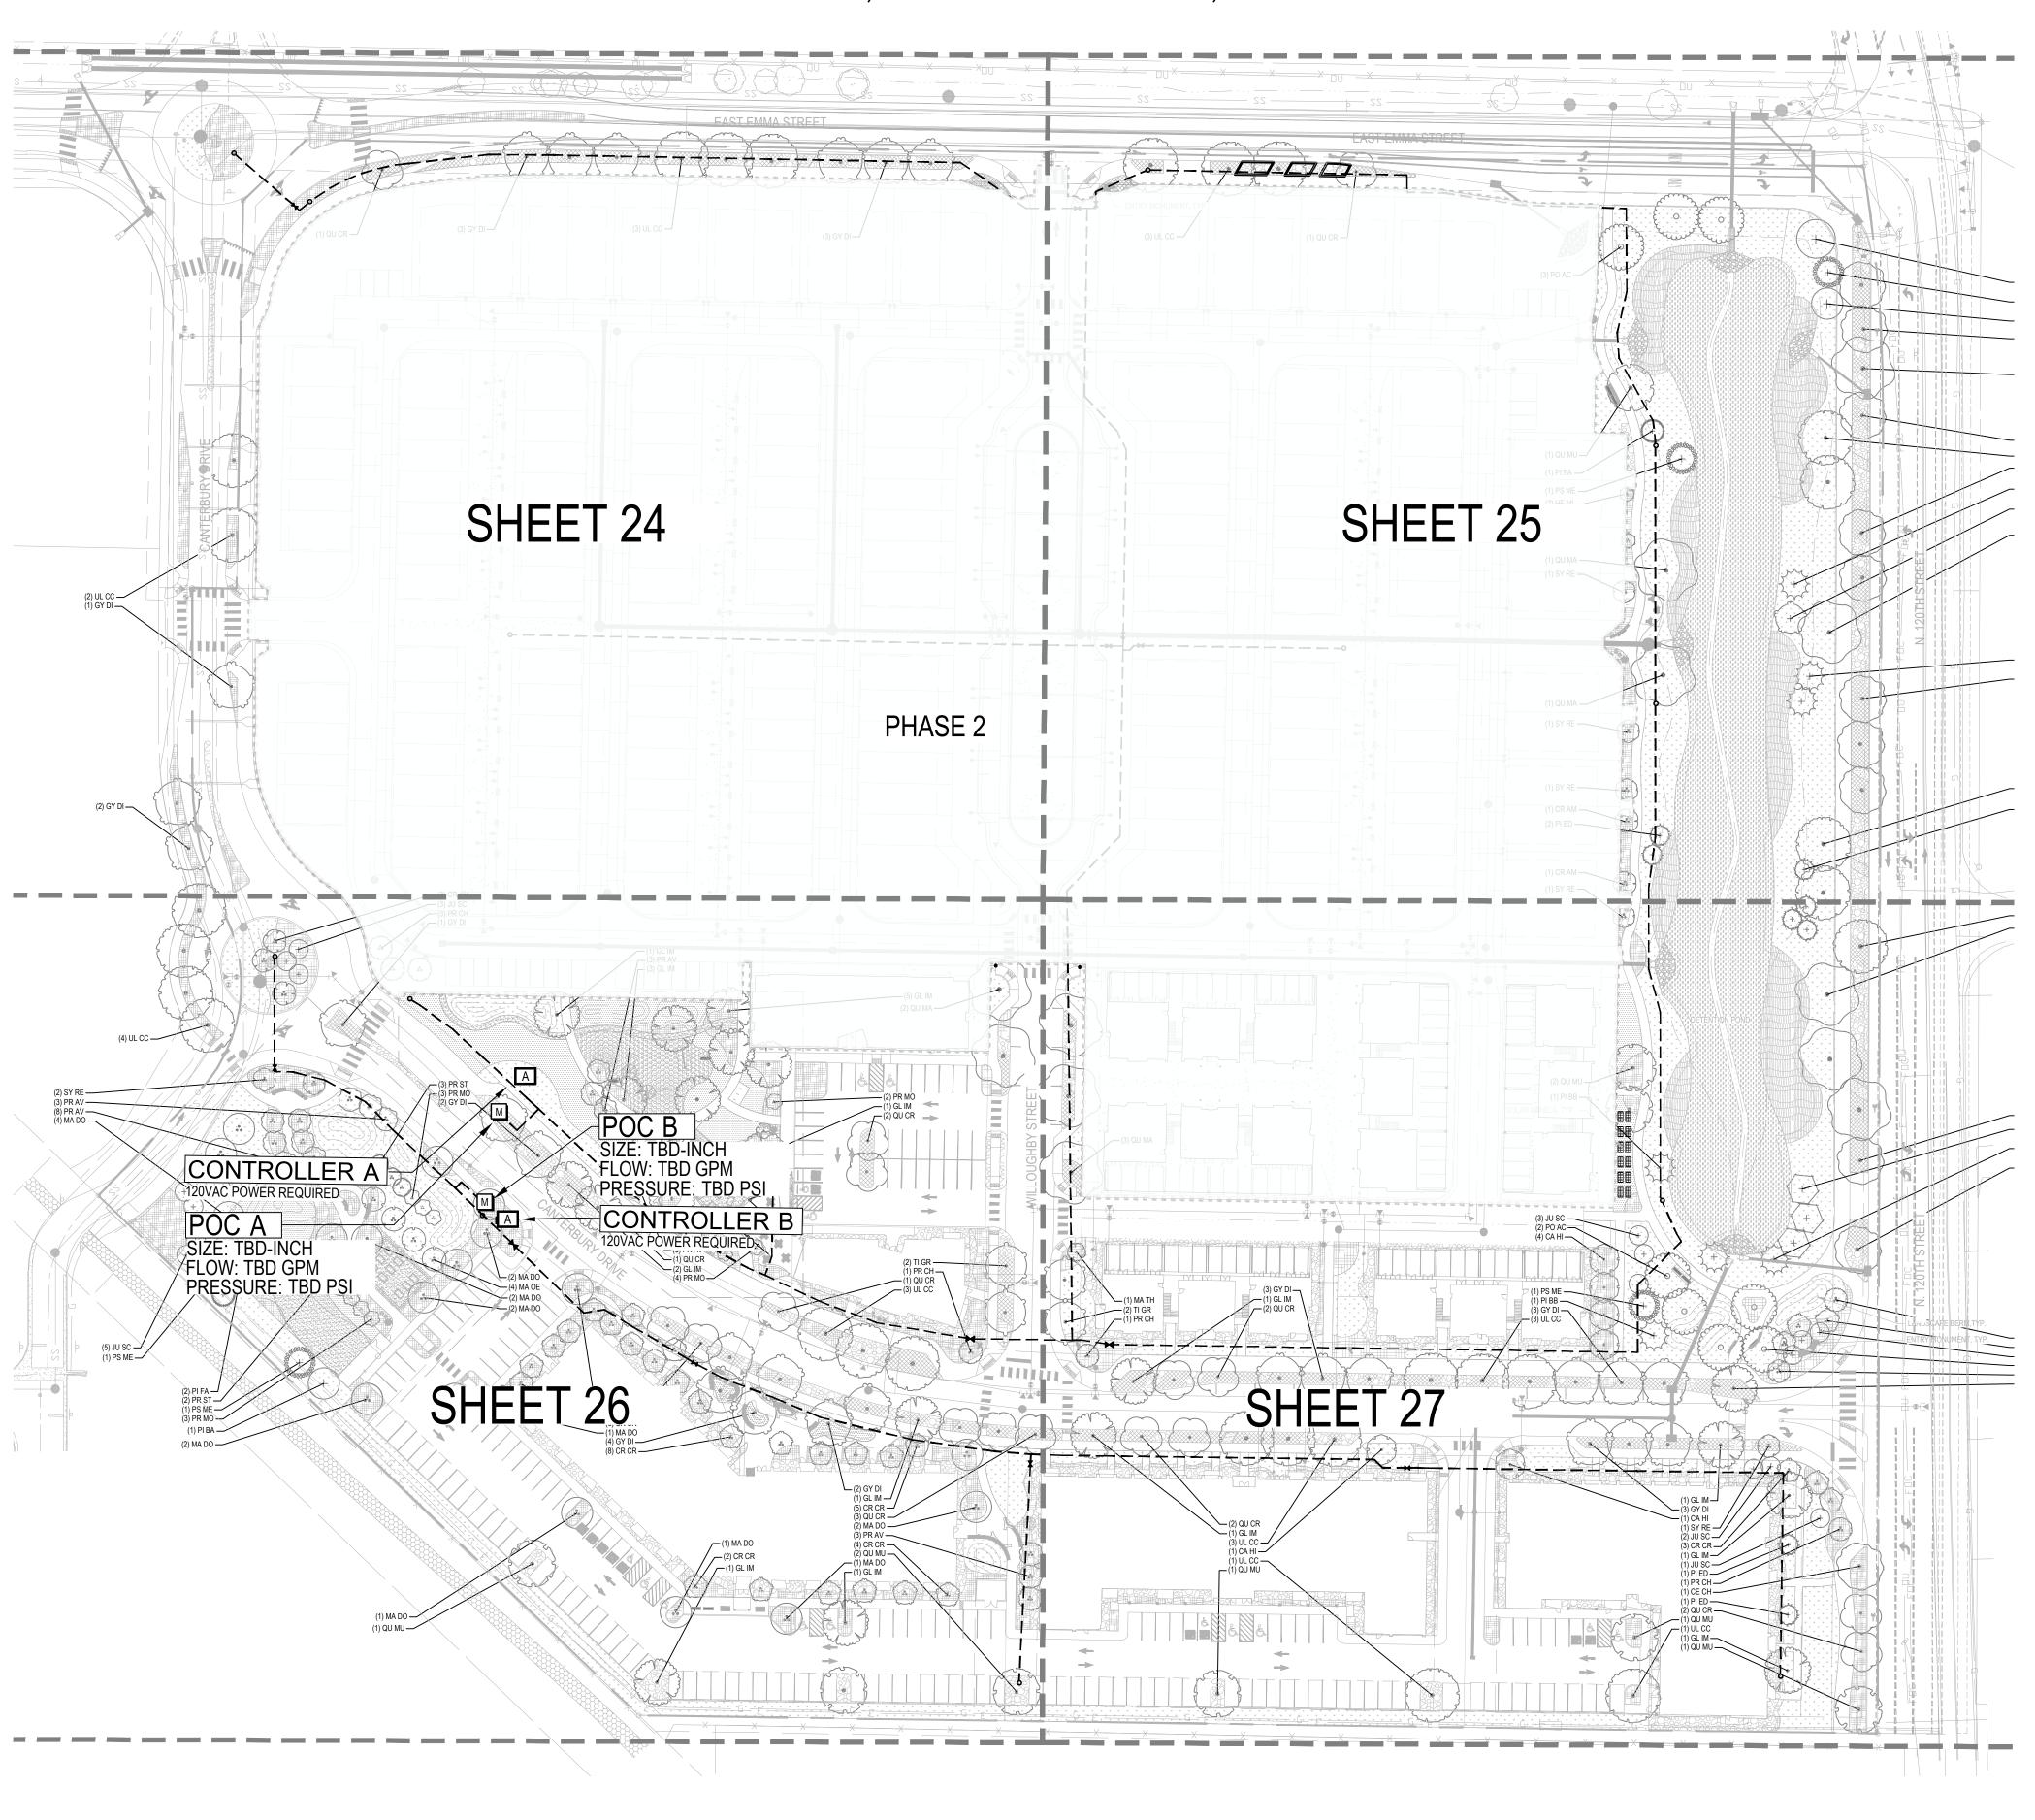
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OWNER:

BOULDER COUNTY HOUSING AUTHORITY 3400 BROADWAY BOULDER, CO - 80304 303.441.3861 CONTACT: MOLLY CHIANG

DATE: 06.17.22 - SITE PLAN 01

> SHEET TITLE: IRRIGATION SCHEDULE




WILLOUGHBY CORNER SITE PLAN - PHASE 1



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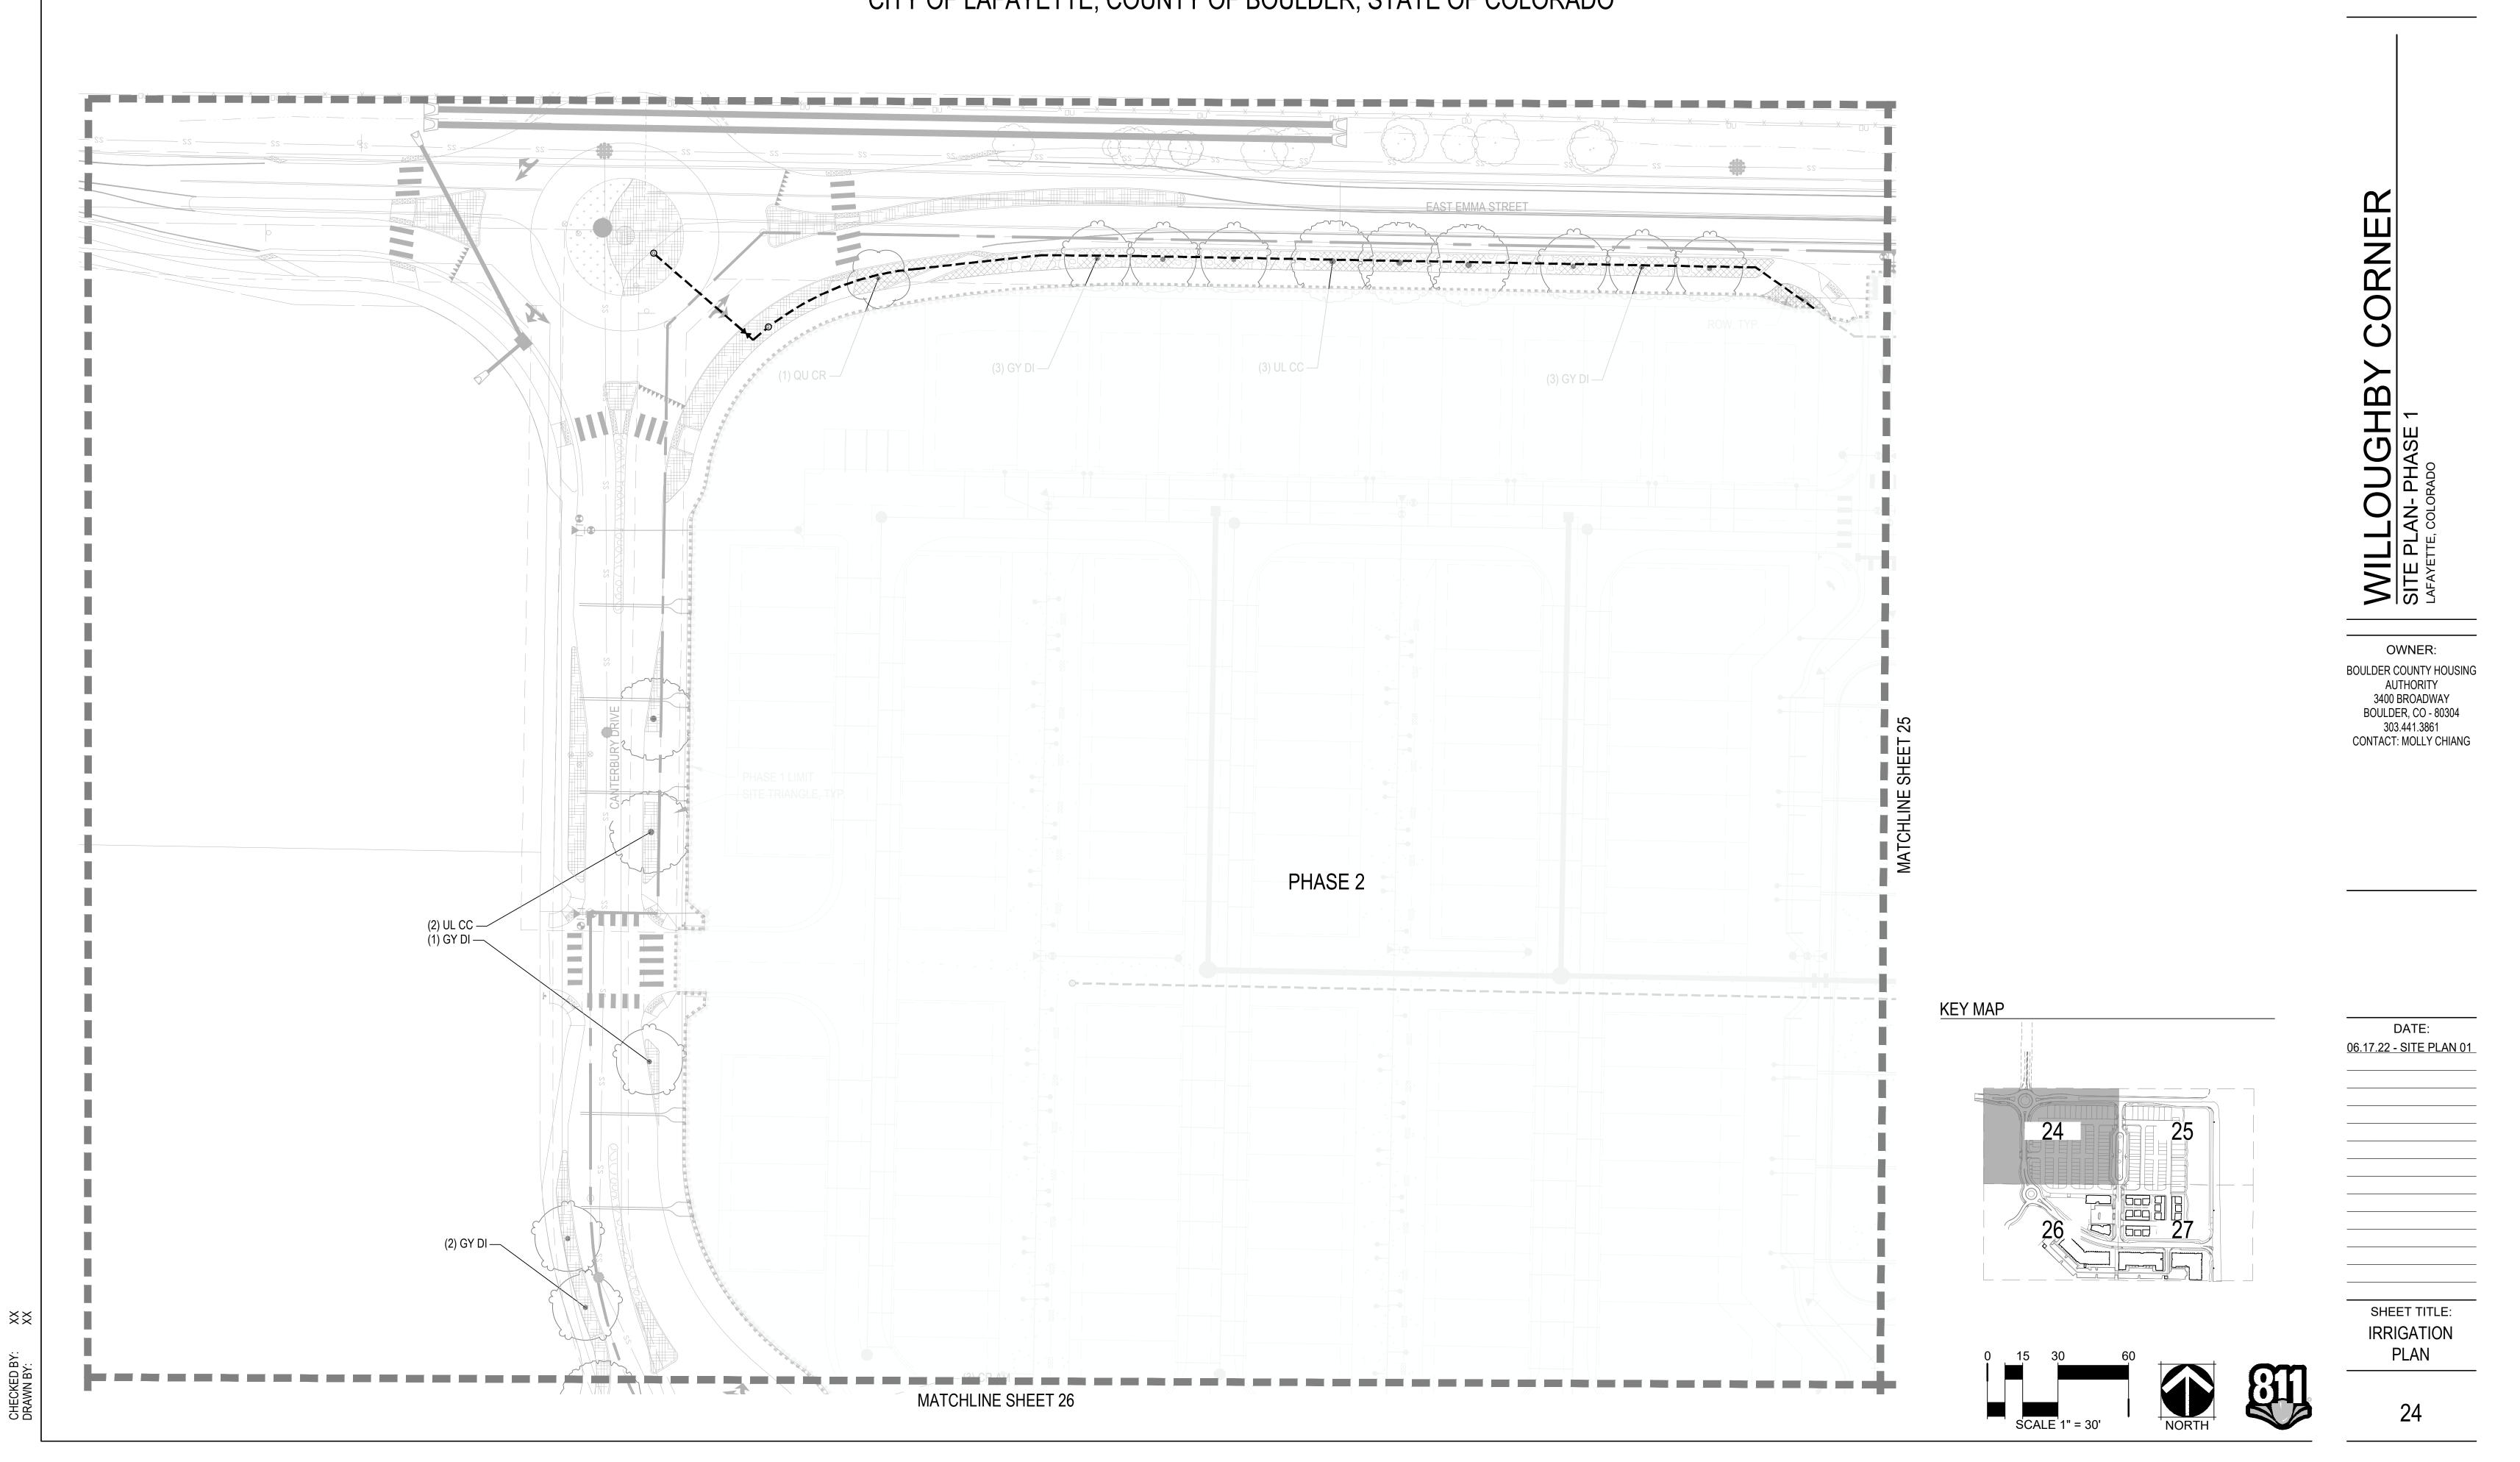


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SCALE 1" = 60'

120

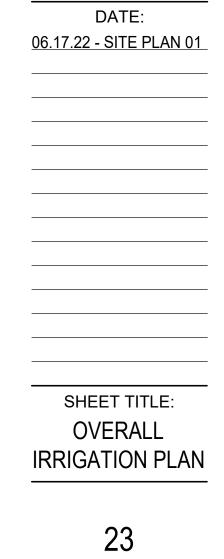
NORTH



WILLOUGHBY CORNER SITE PLAN - PHASE 1 LOTS 160, 161, 164, 165, 166 & 167, & OUTLOTS F, I, J & K OF THE WILLOUGHBY CORNER SUBDIVISION, CITY OF LAFAYETTE, COUNTY OF BOULDER, STATE OF COLORADO



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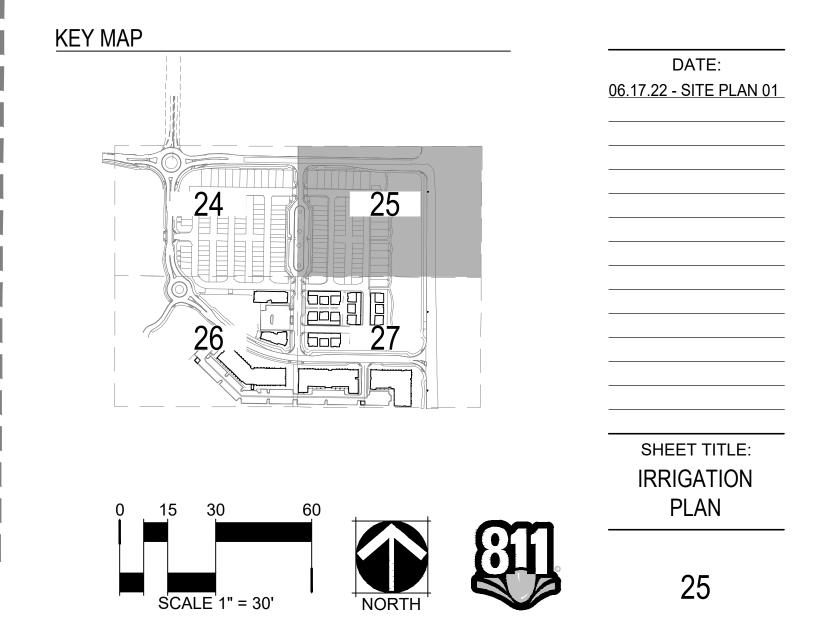
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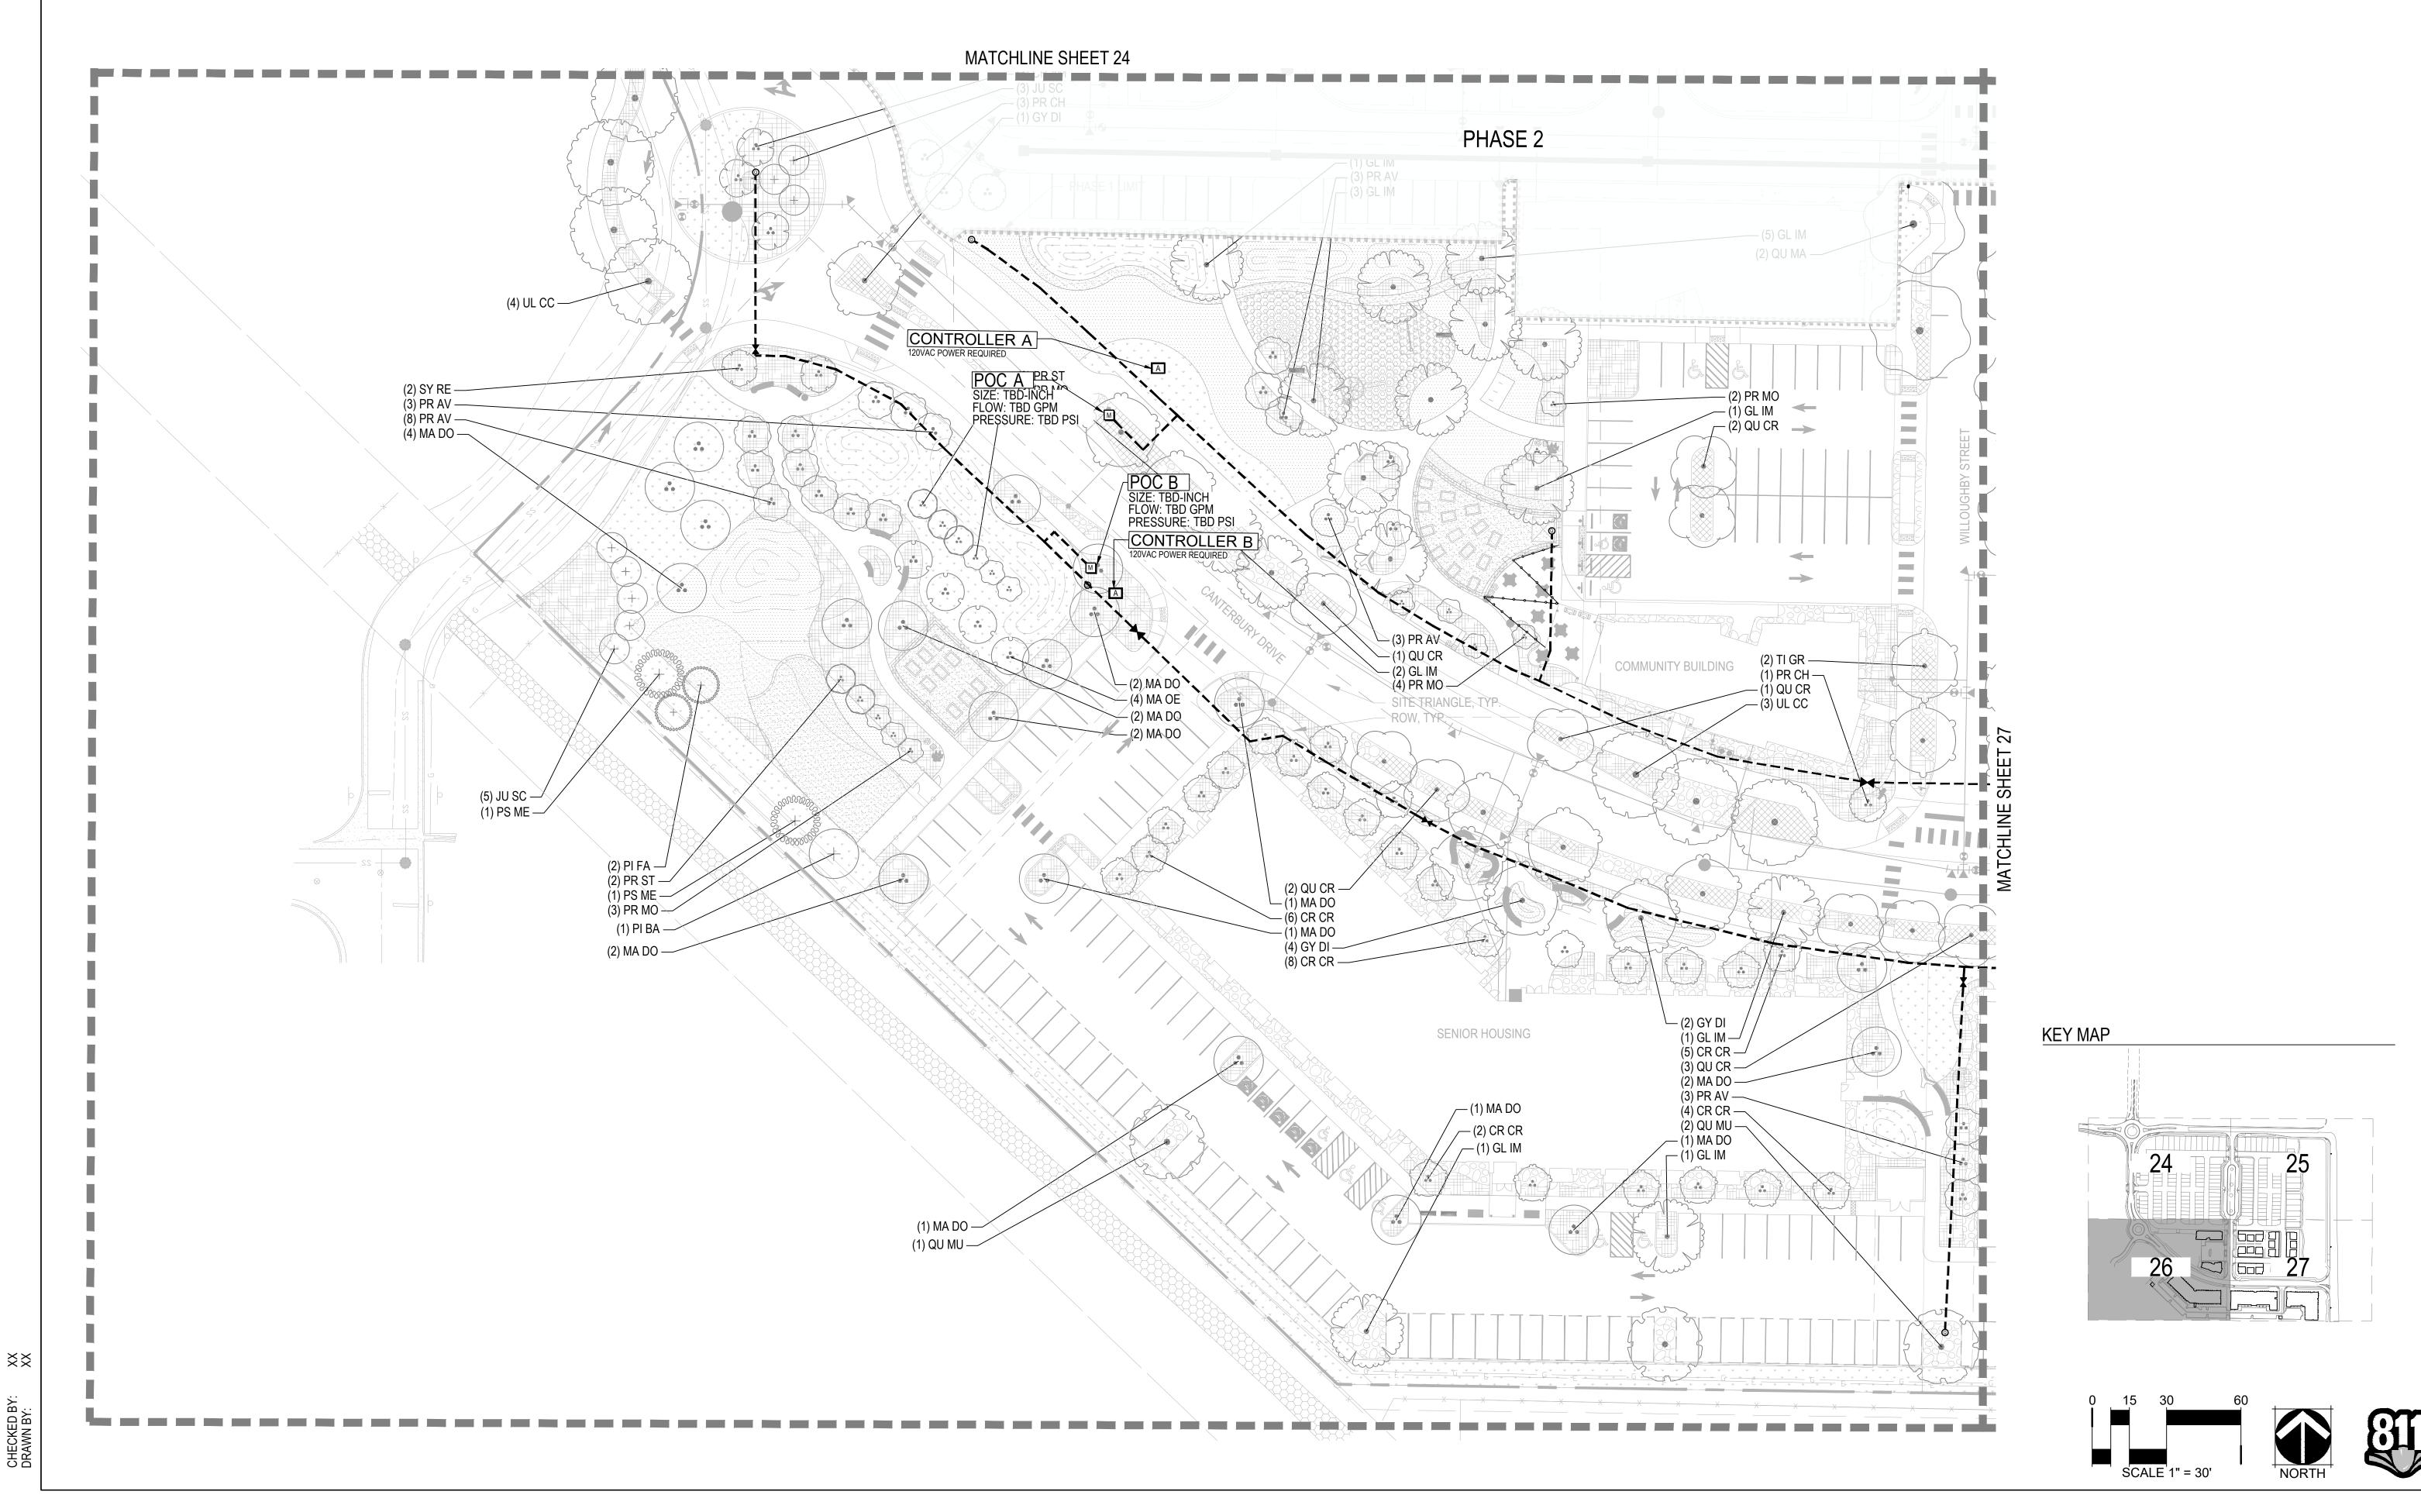

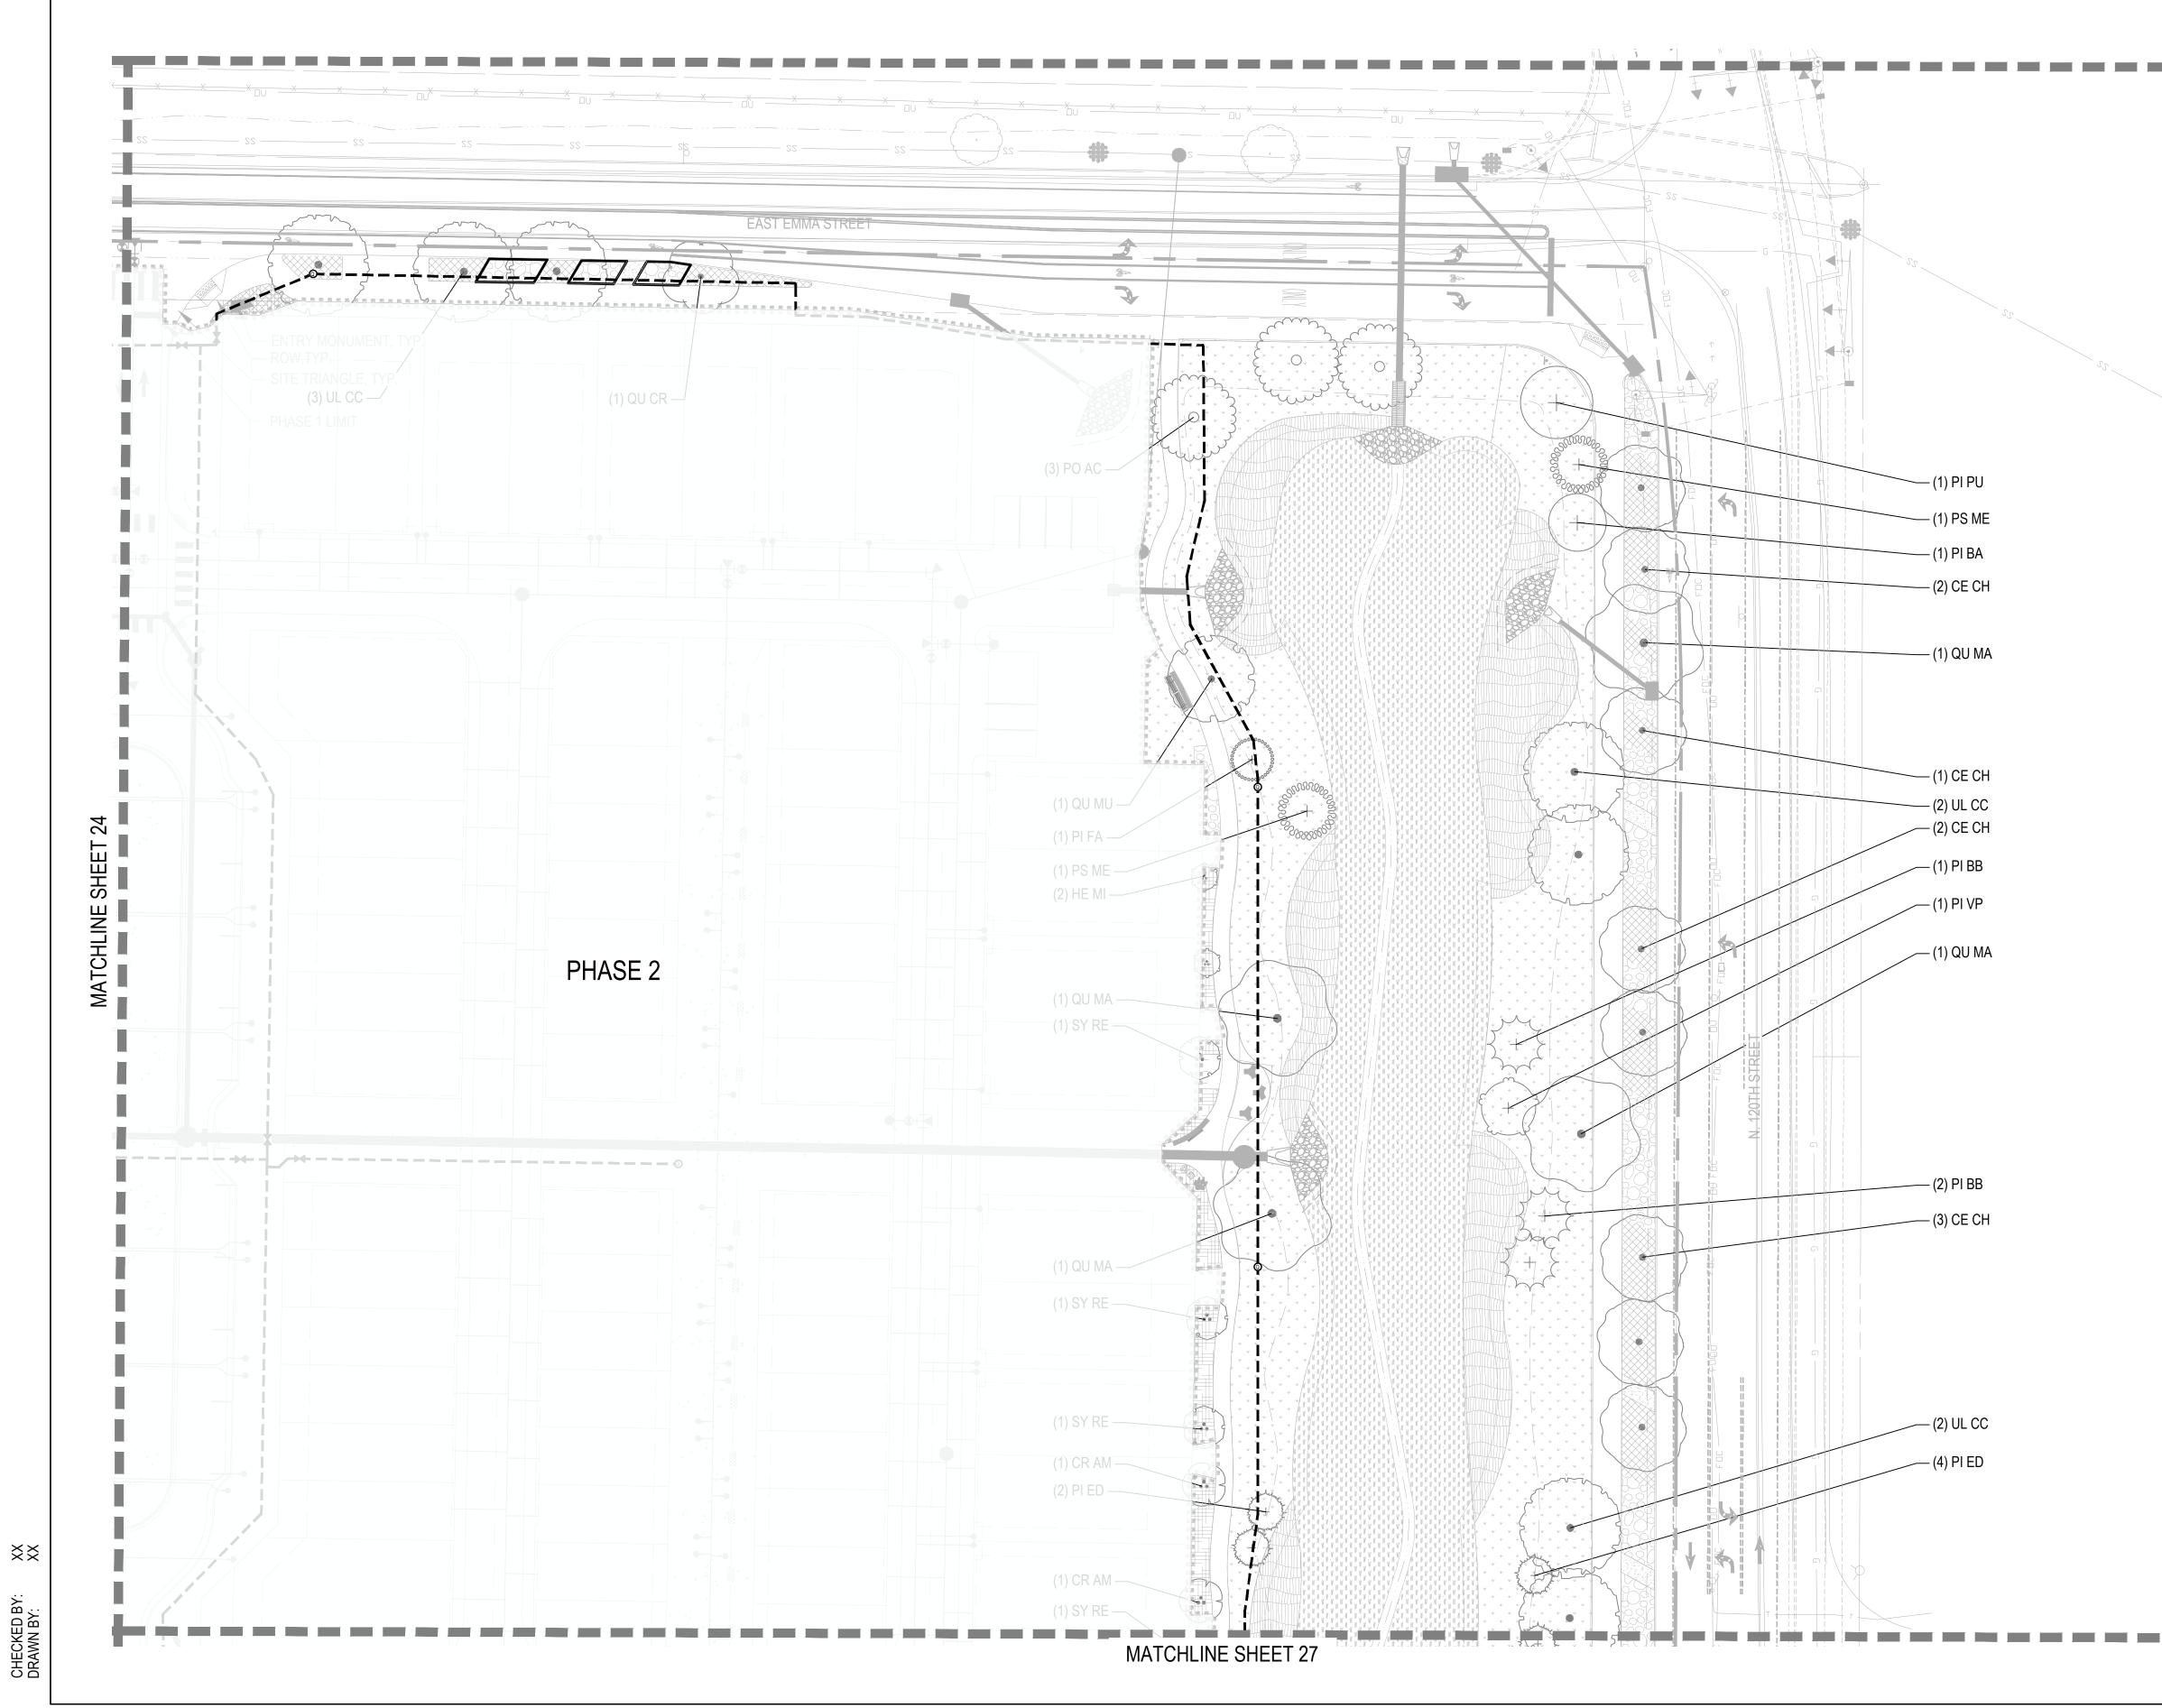
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ORNER

1BY

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DATE:

<u>06.17.22 - SITE PLAN 01</u>


SHEET TITLE:

IRRIGATION

PLAN

26

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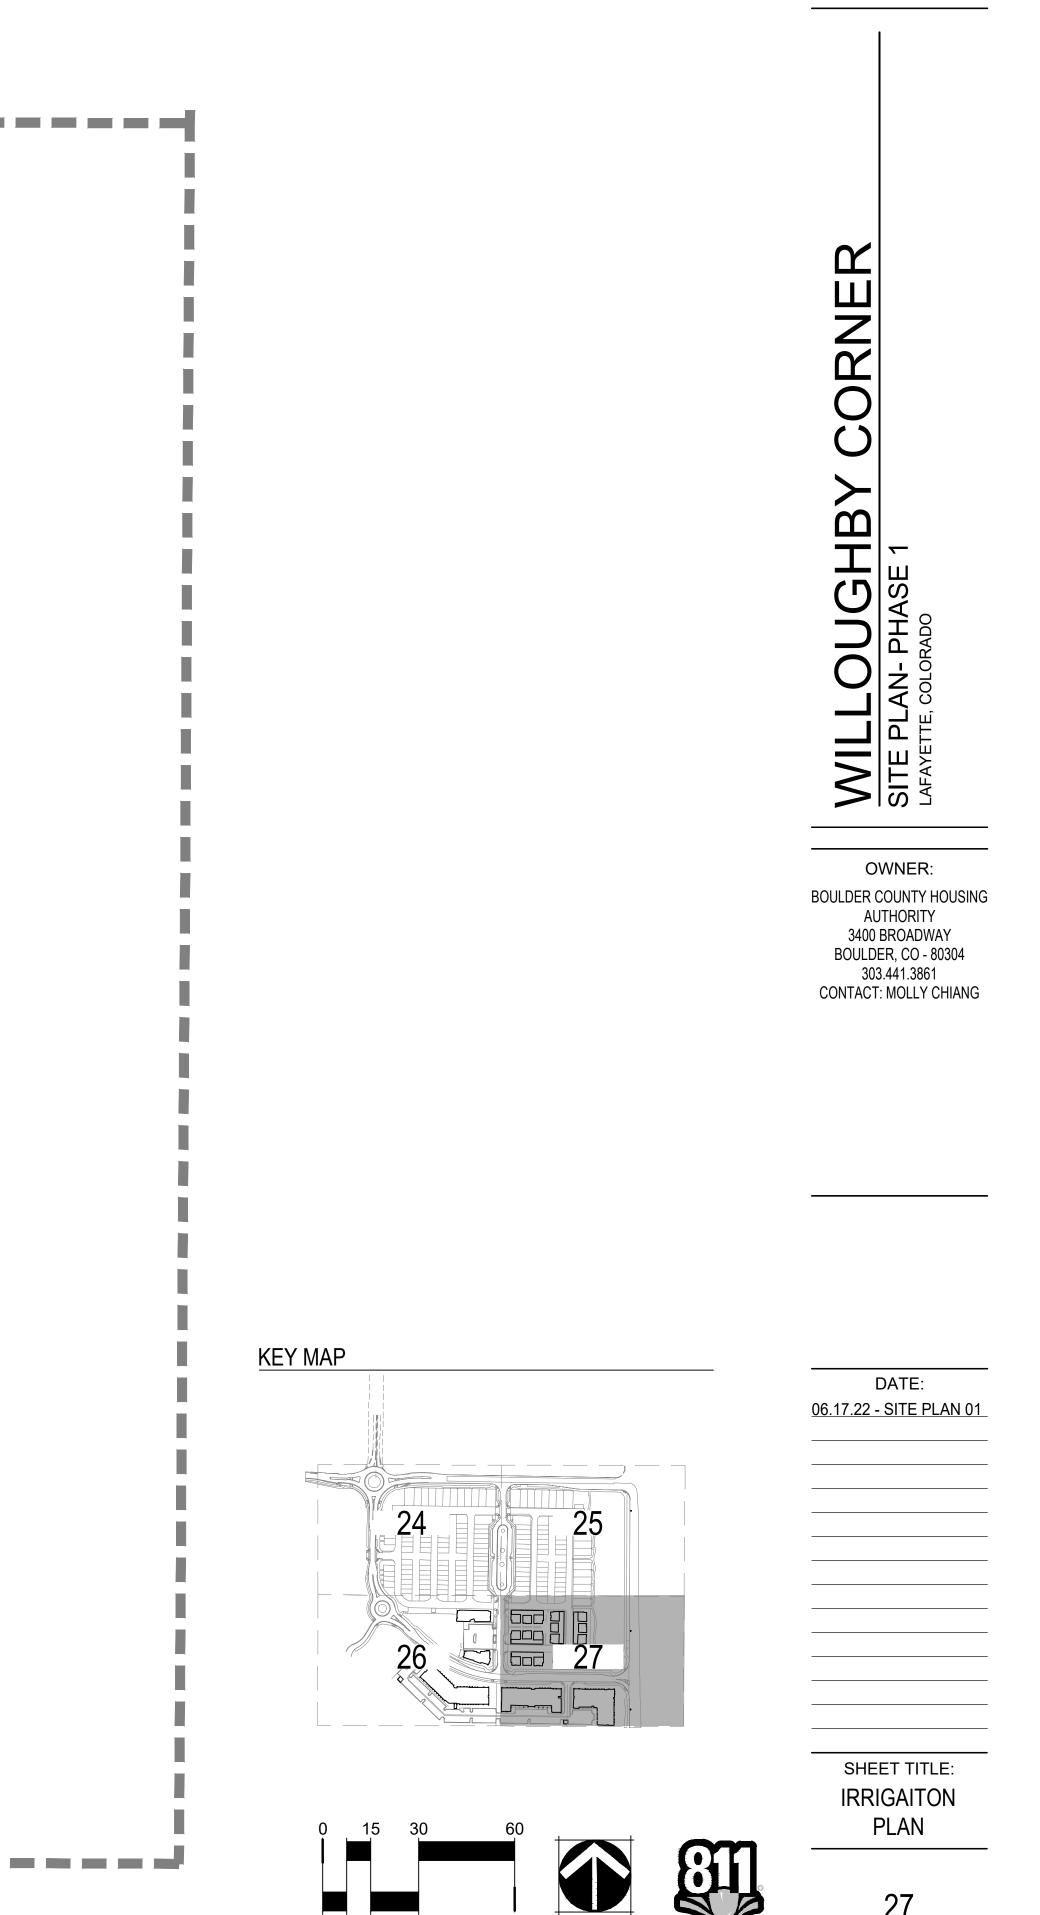

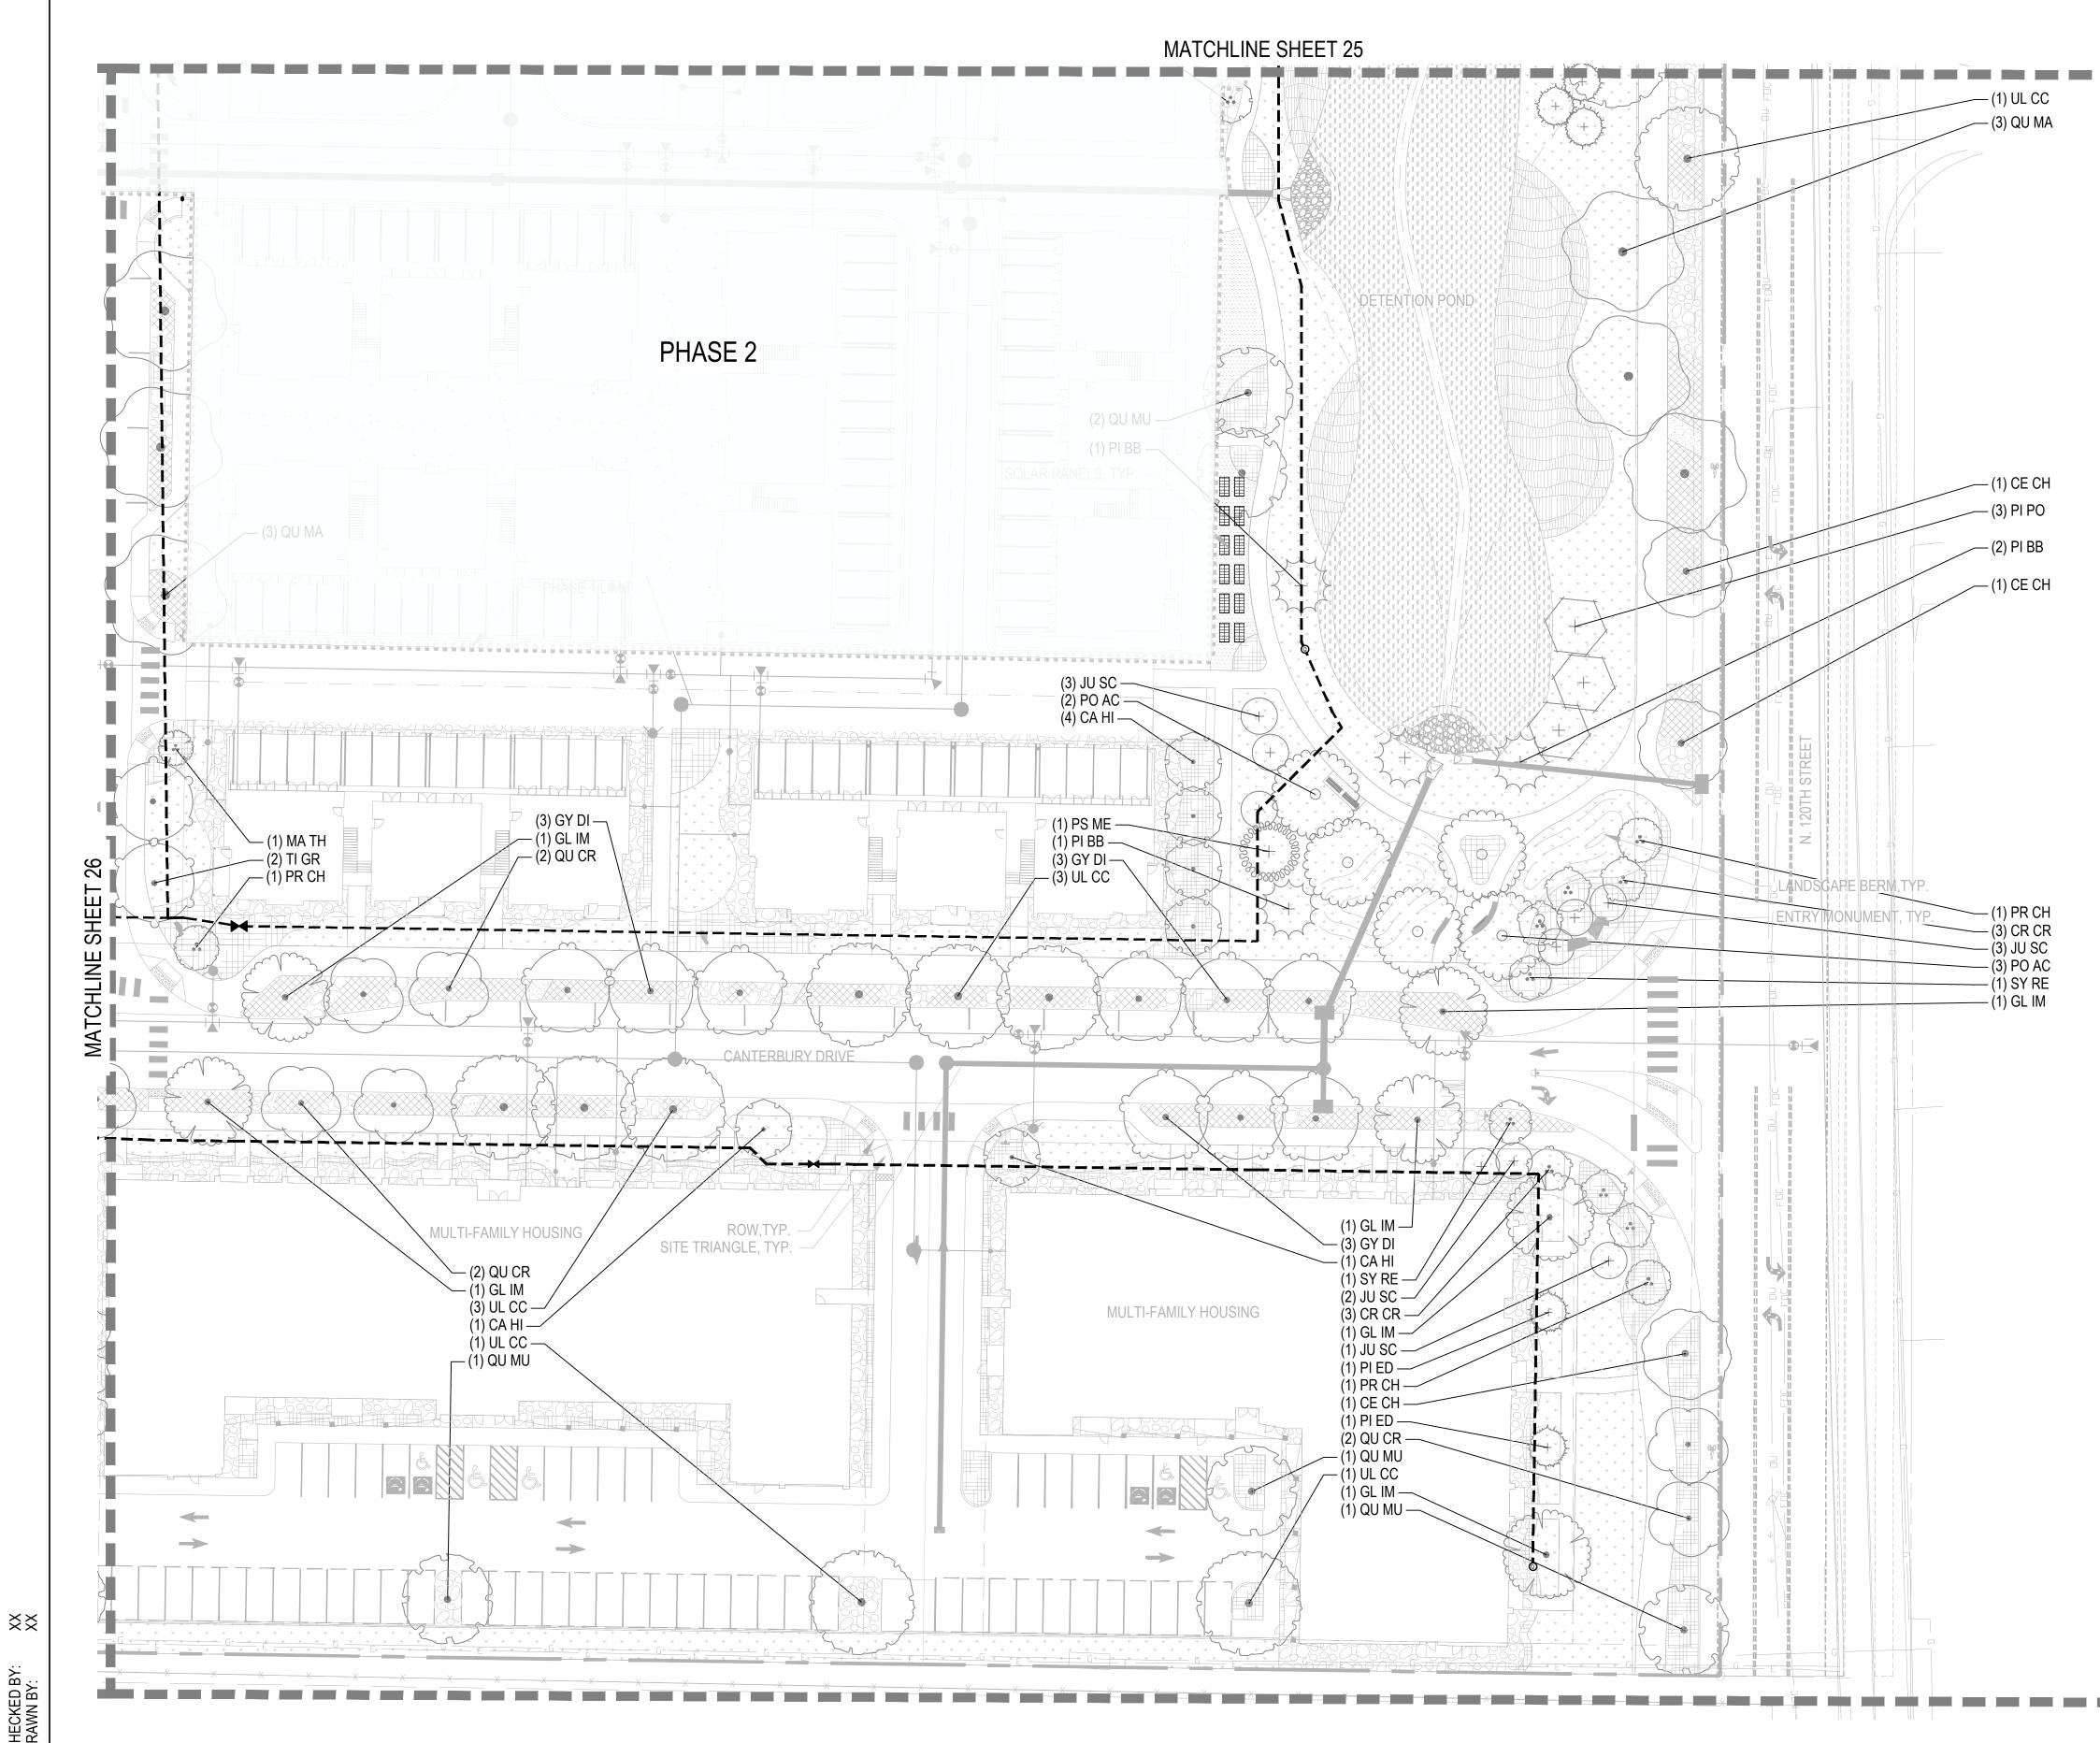
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WILLOUGHBY CORNER SITE PLAN - PHASE 1 LOTS 160, 161, 164, 165, 166 & 167, & OUTLOTS F, I, J & K OF THE WILLOUGHBY CORNER SUBDIVISION, CITY OF LAFAYETTE, COUNTY OF BOULDER, STATE OF COLORADO




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SCALE 1" = 30'

NORTH



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(1) BACKFLOW ENCLOSURE

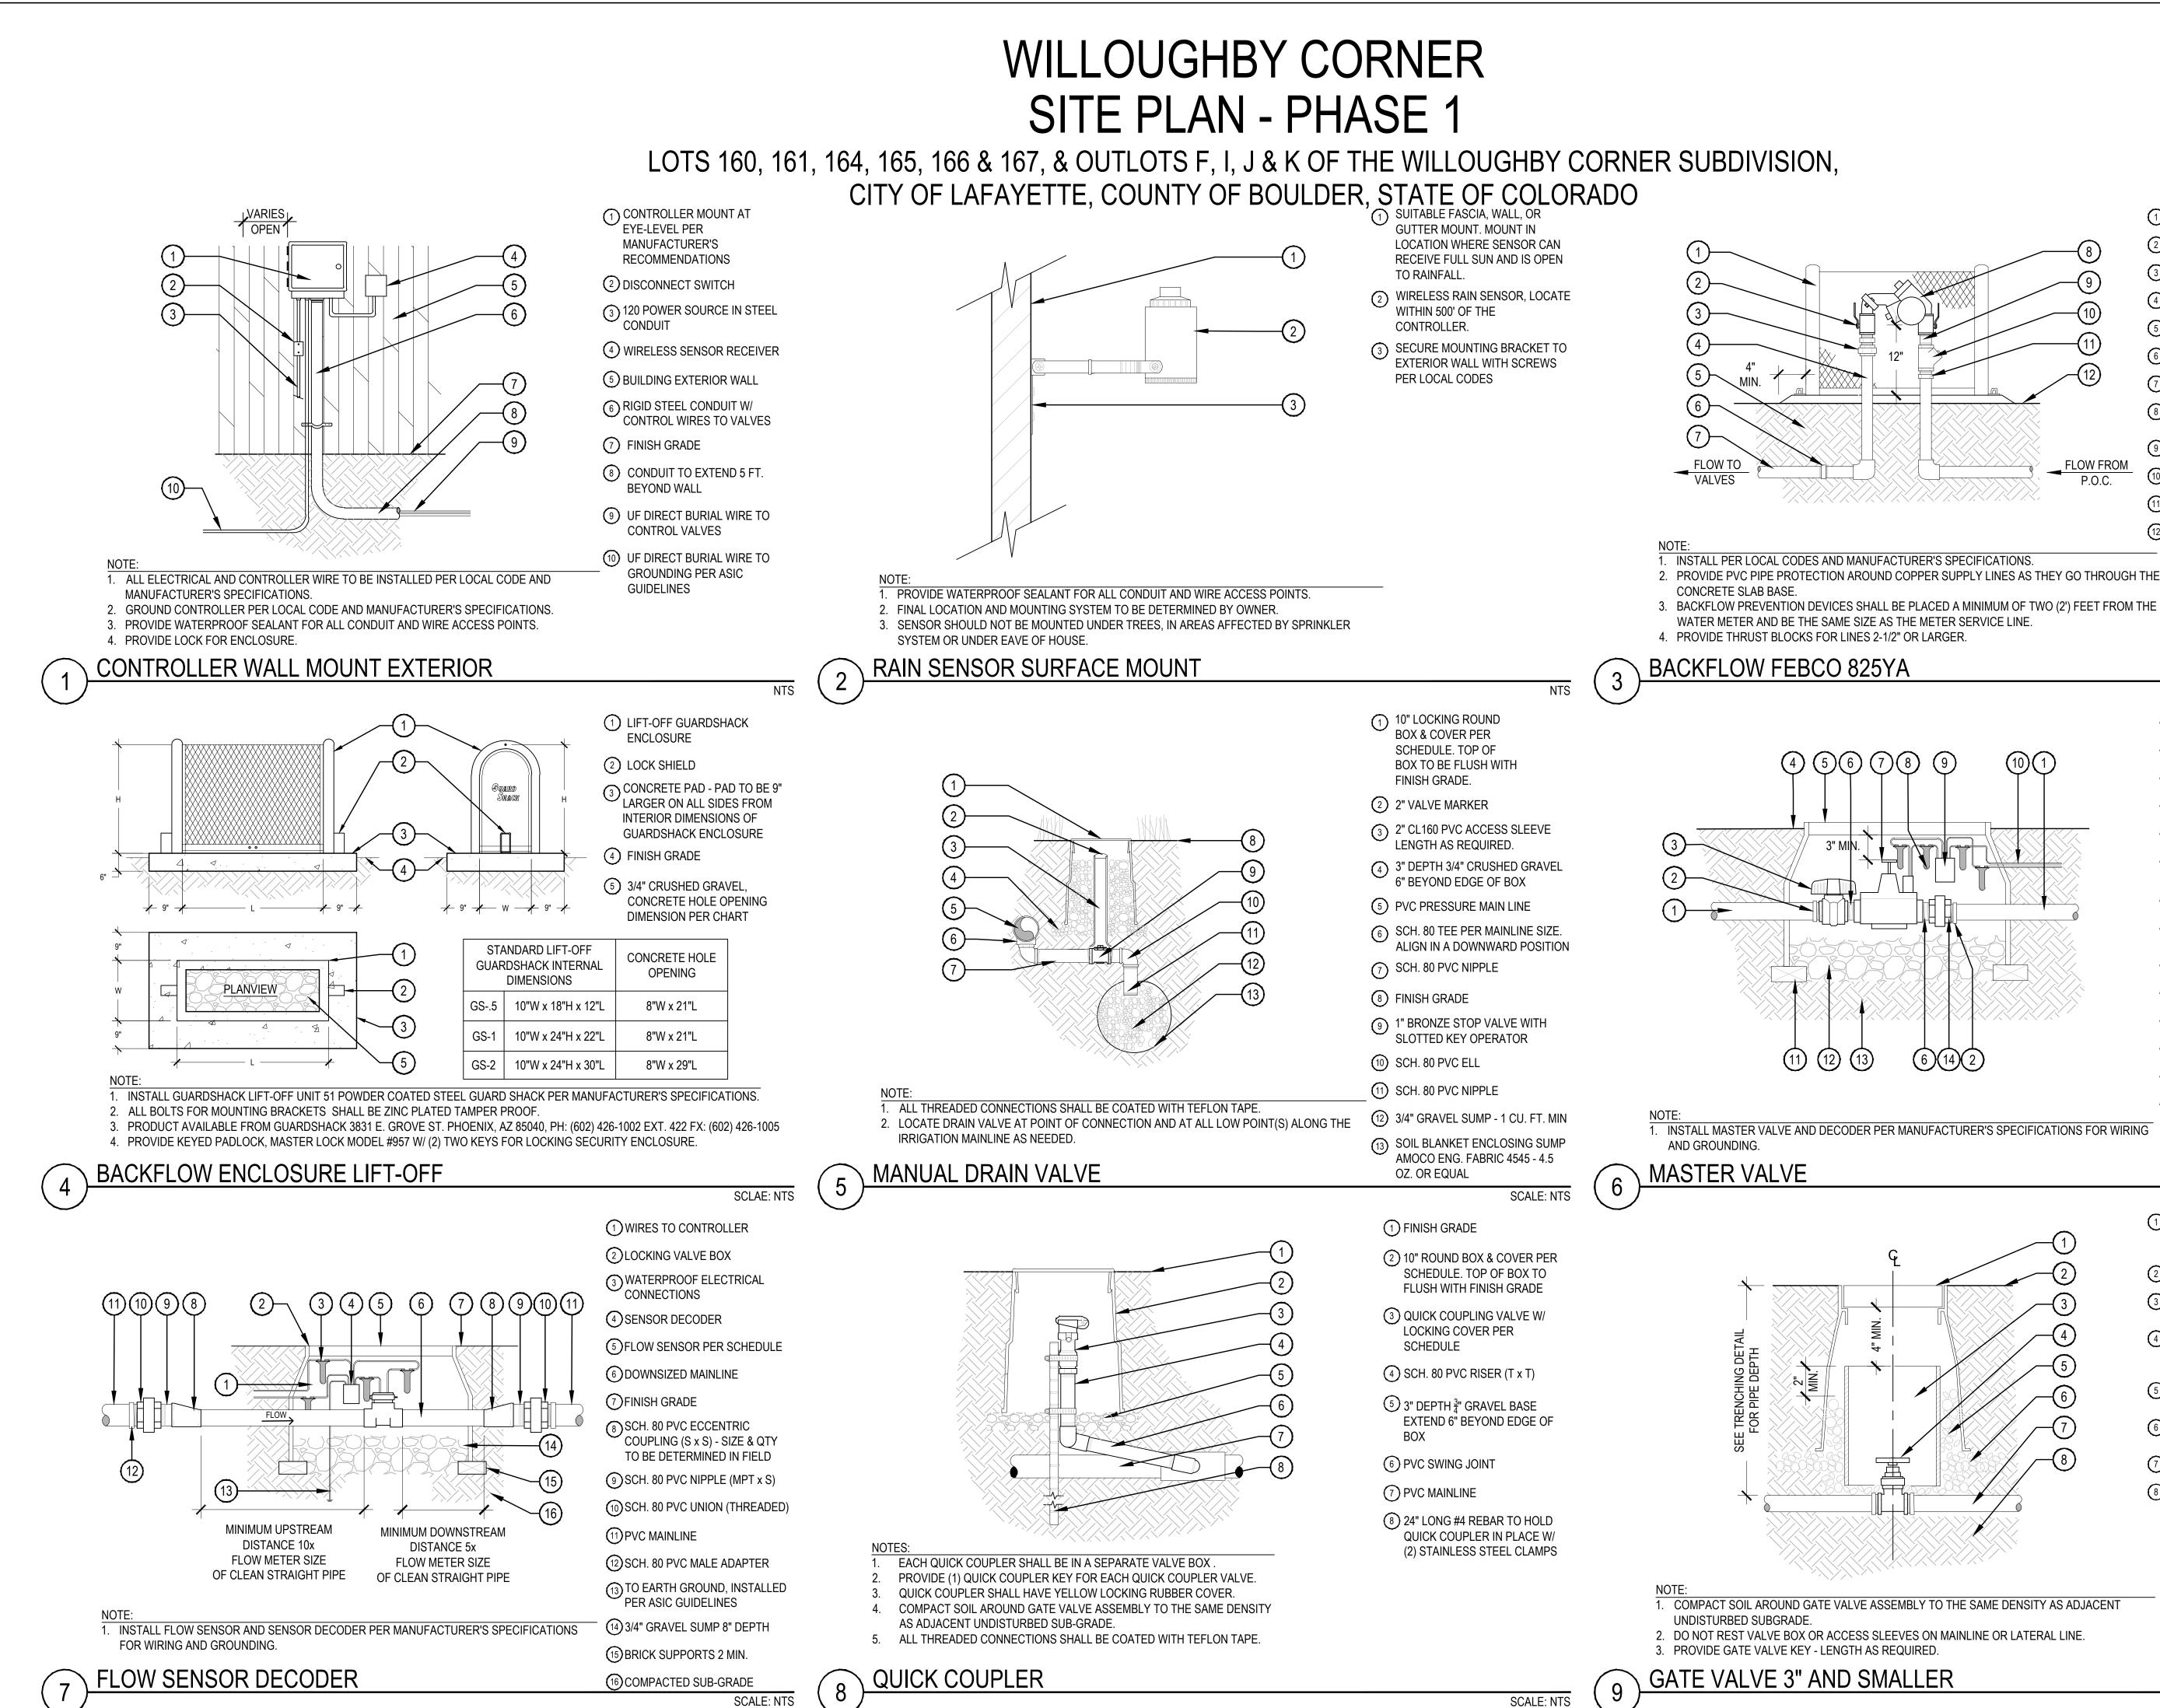- 2 BALL VALVE
- 3 BRASS UNION
- (4) TYPE K COPPER PIPE
- 5 COMPACTED SUBGRADE
- 6 PVC ADAPTOR 30" BEYOND UNIT
- 7 PVC MAINLINE
- REDUCED PRESSURE BACKFLOW PREVENTER WITH BALL VALVES
- (9) BRASS RISER
- (10) BRASS WYE STRAINER (100 MESH)

NTS

(11) COPPER ADAPTER

1 PVC MAINLINE

(4) FINISH GRADE

5 LOCKING VALVE BOX

6 SCH. 80 PVC NIPPLE

(8) WATERPROOF ELECTRICAL

(10) WIRES TO CONTROLLER

(11) BRICK SUPPORTS 2 MIN.

(THREADED)

CONNECTIONS

7 MASTER VALVE

(9) DECODER

(2) SCH. 80 PVC MALE ADAPTER

(3) SCH. 80 PVC BALL VALVE


(12) FINISH GRADE

- (12) 3/4" GRAVEL SUMP 8" DEPTH (13) COMPACTED SUBGRADE
- (14) SCH. 80 PVC UNION (THREADED)
- SCALE: NTS 1 LOCKING ROUND BOX & COVER PER SCHEDULE. TOP OF BOX TO **BE FLUSH WITH FINISH GRADE**
- 2 FINISH GRADE
- 3 8" SCH 40 PVC ACCESS SLEEVE LENGTH AS REQUIRED.
- (4) GATE VALVE W/ CROSS HANDLE AND SOLID WEDGE DISC PER SCHEDULE
- 5 3/4" GRAVEL SUMP FILL IN AND AROUND BOX AS REQUIRED.
- 6 3" DEPTH 3/4: GRAVEL EXTEND 6" BEYOND EDGE OF BOX
- 7 PVC MAINLINE
- (8) COMPACTED SUBGRADE

ORNER GHB' WIL SITE F


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DATE:
06.17.22 - SITE PLAN 01
SHEET TITLE:
IRRIGATION
DETAILS

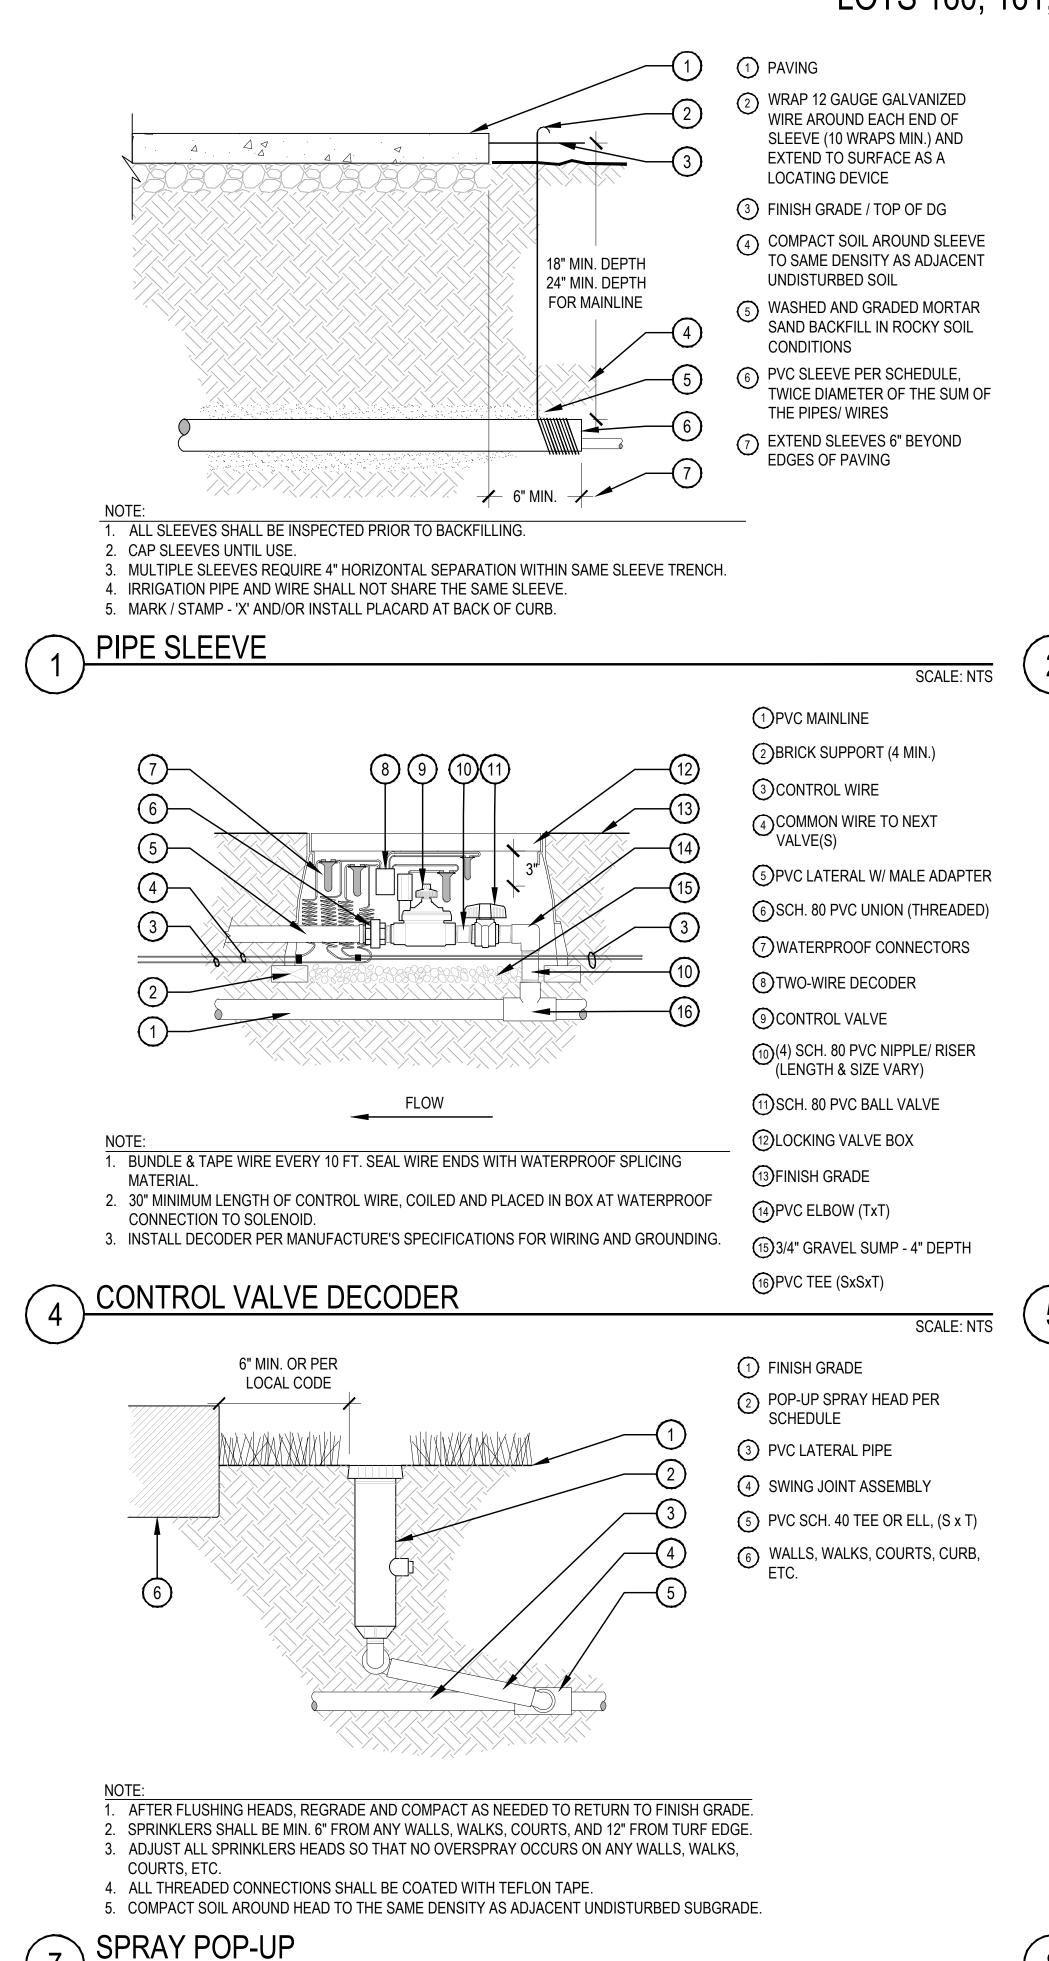


SCALE: NTS

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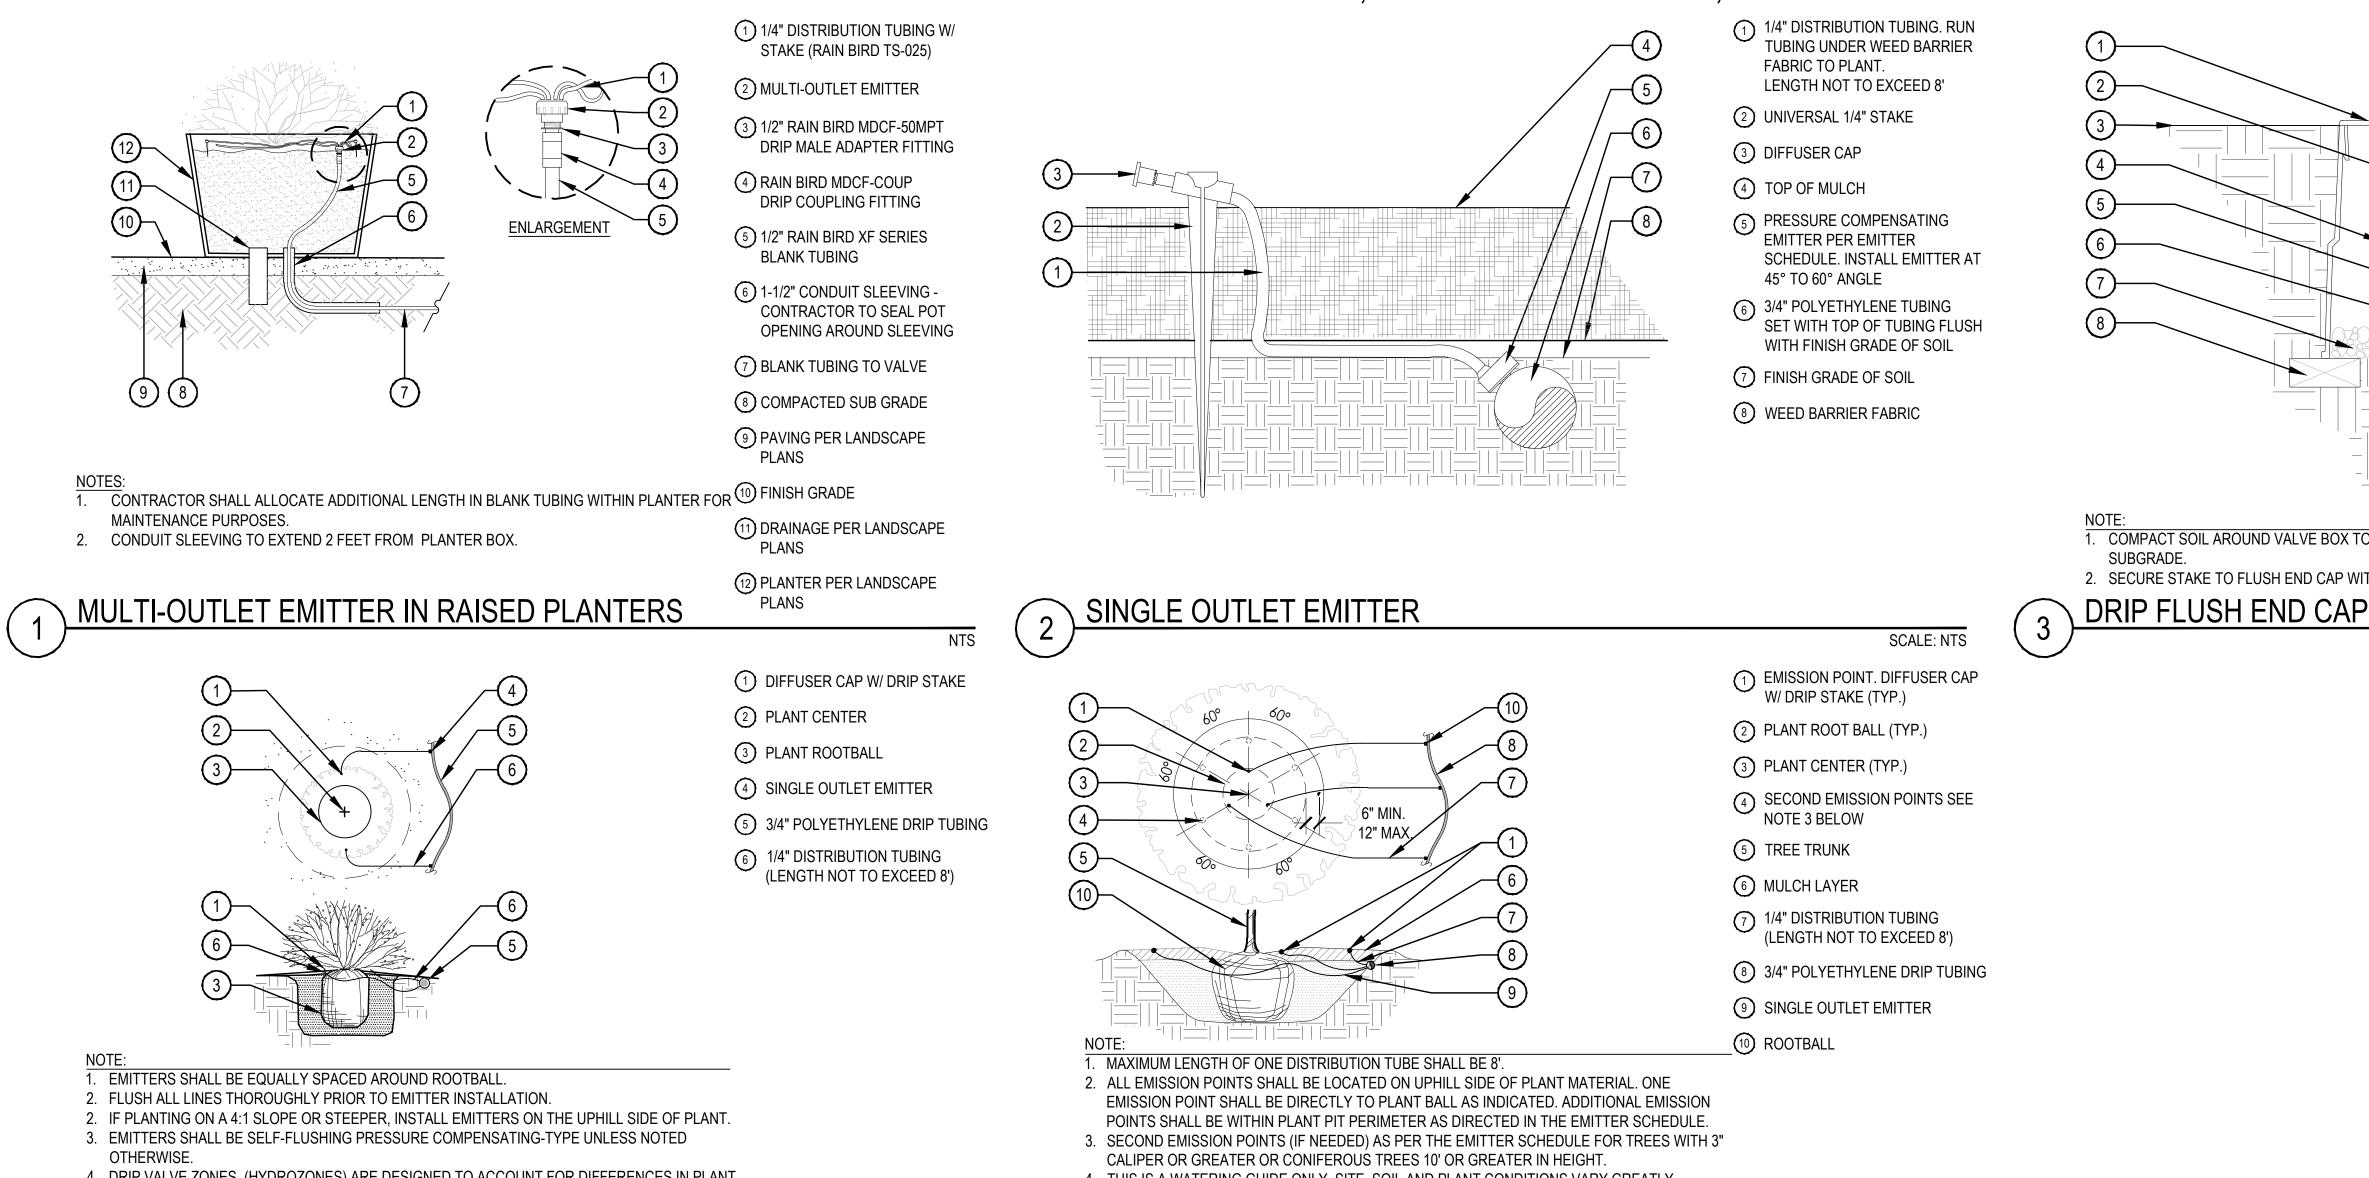
BOULDER COUNTY HOUSING

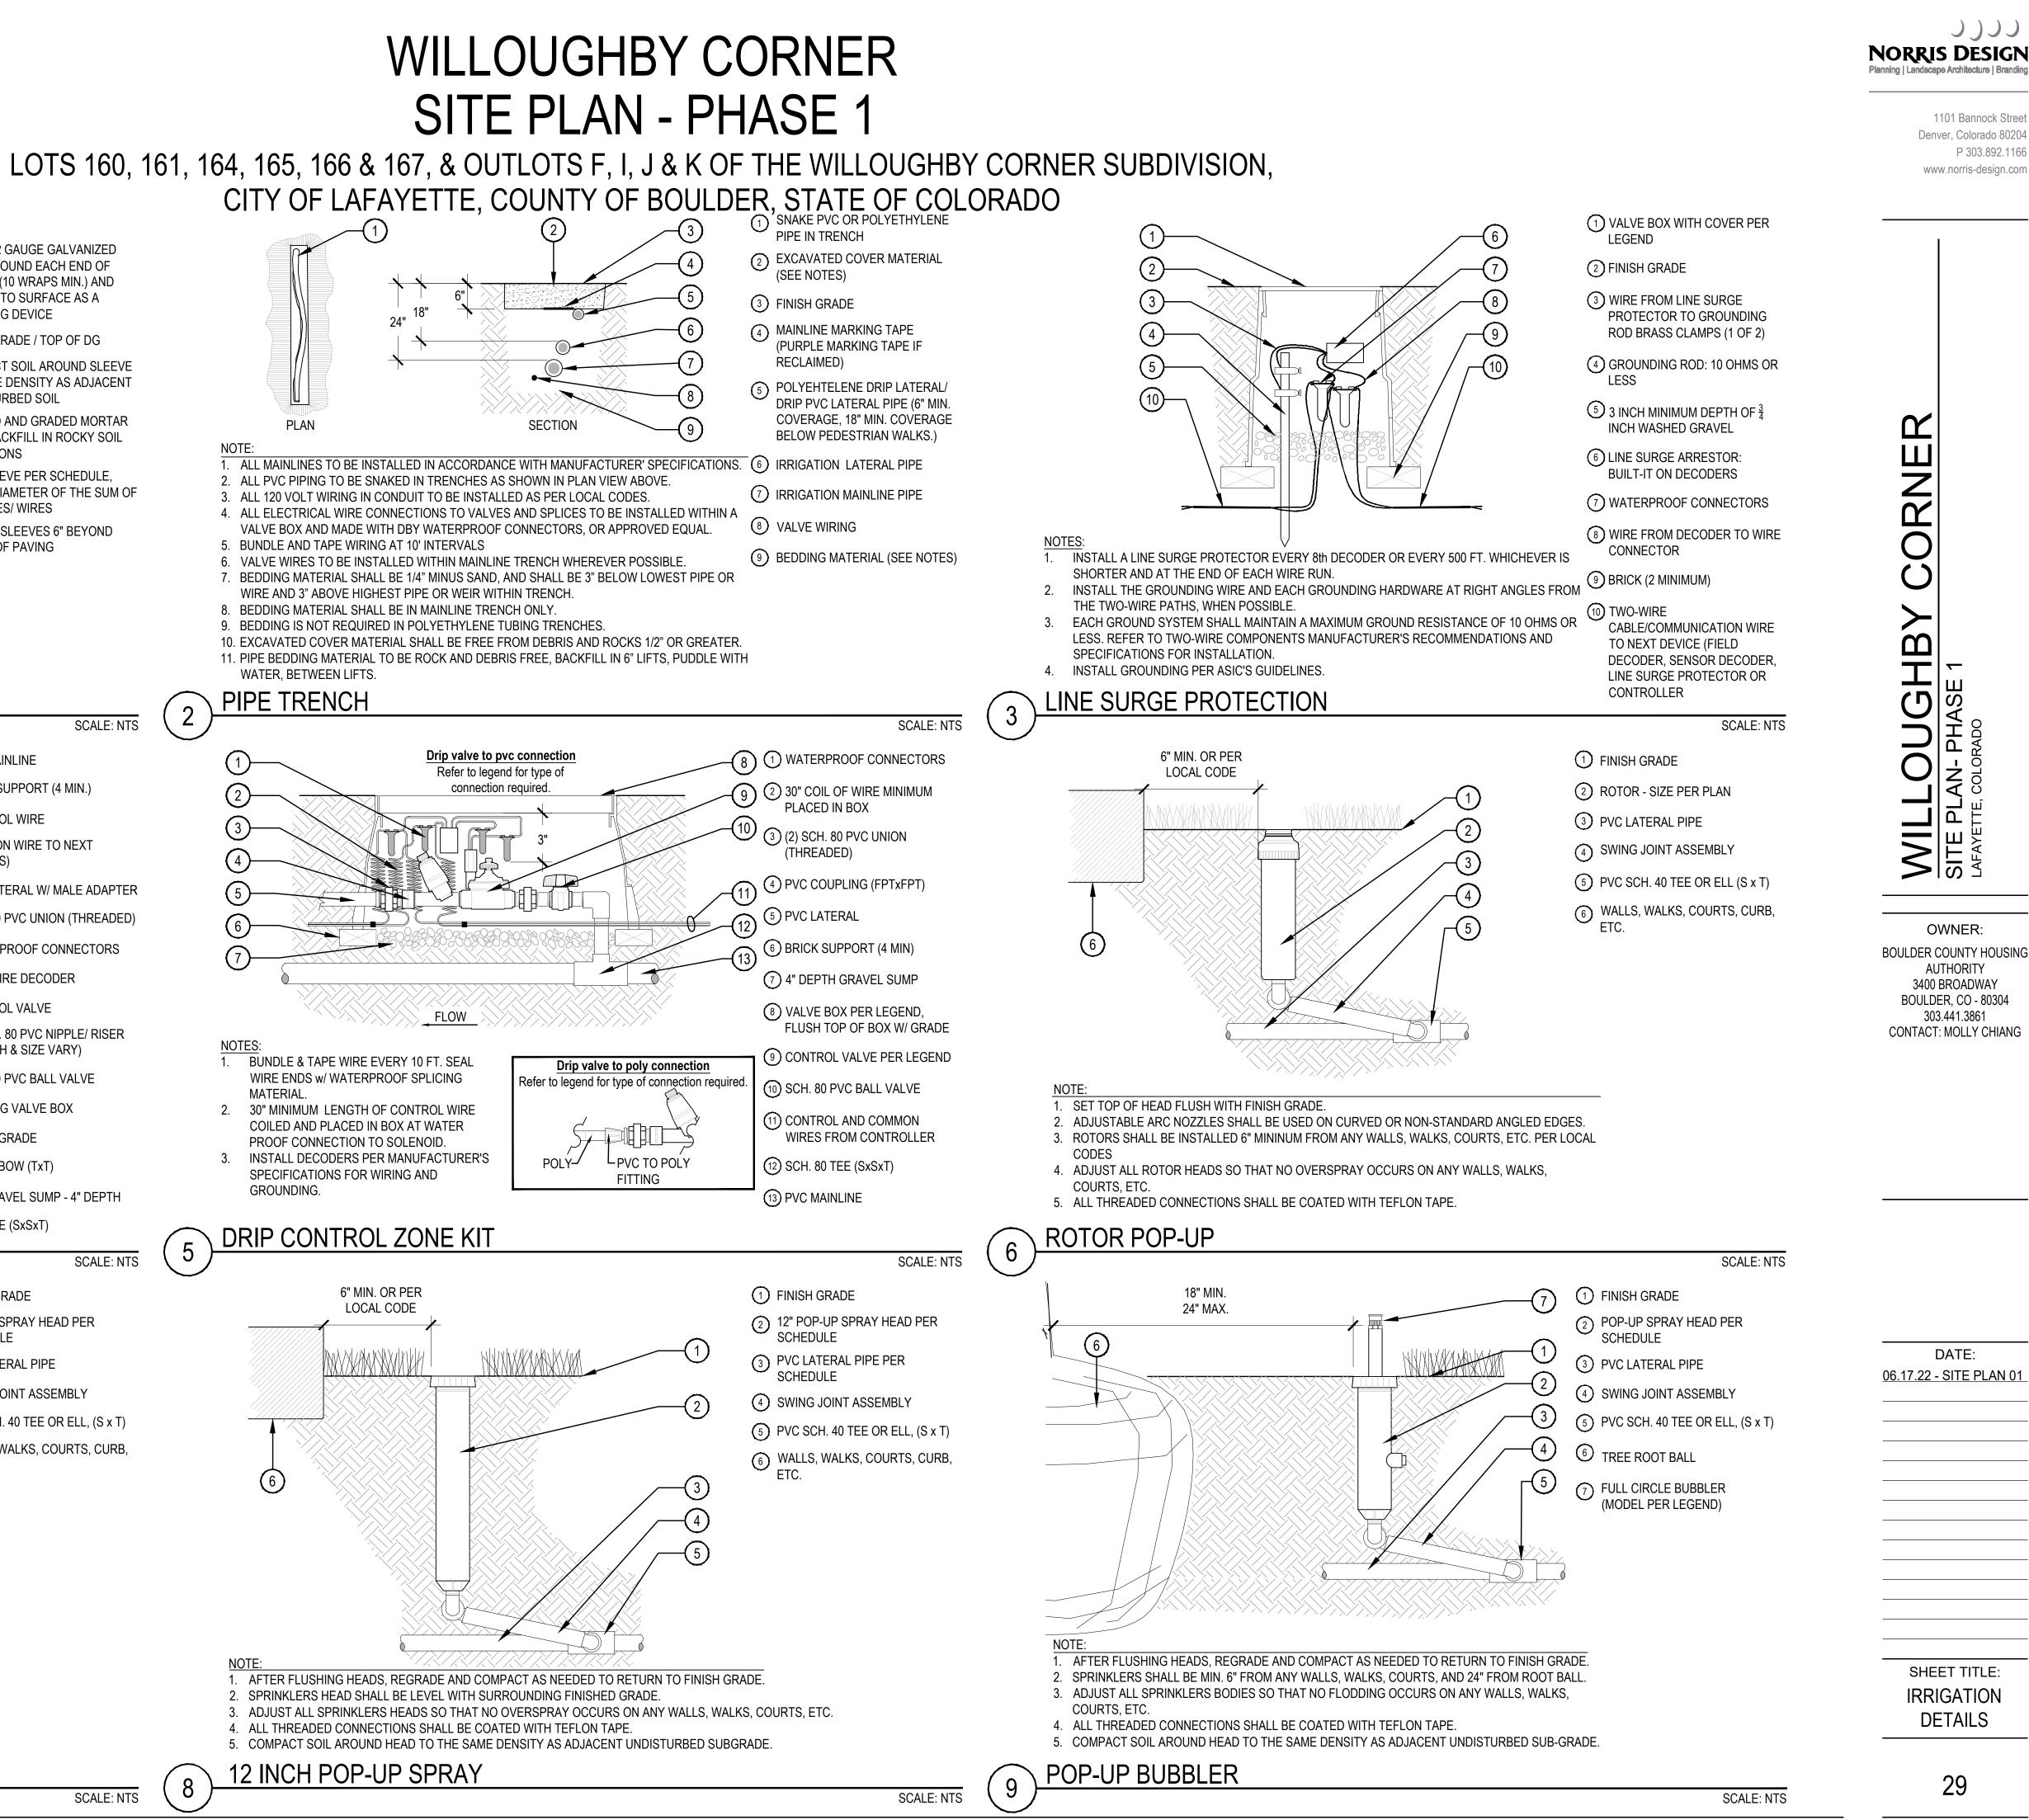

STAKE (RAIN BIRD TS-025)

(4) RAIN BIRD MDCF-COUP

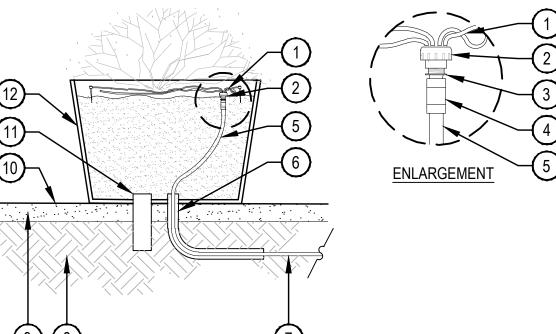CONTRACTOR TO SEAL POT



4. DRIP VALVE ZONES (HYDROZONES) ARE DESIGNED TO ACCOUNT FOR DIFFERENCES IN PLANT REQUIREMENTS AND SUN EXPOSURE. 5. CONTRACTOR SHALL ENSURE HYDROZONES ARE VALVED SEPARATELY AS SHOWN ON PLAN.

SINGLE OUTLET EMITTER PLACEMENT

SCALE: NTS

5

WILLOUGHBY CORNER SITE PLAN - PHASE 1 LOTS 160, 161, 164, 165, 166 & 167, & OUTLOTS F, I, J & K OF THE WILLOUGHBY CORNER SUBDIVISION,

CITY OF LAFAYETTE, COUNTY OF BOULDER, STATE OF COLORADO


4. THIS IS A WATERING GUIDE ONLY. SITE, SOIL AND PLANT CONDITIONS VARY GREATLY. CONTRACTOR MUST OBSERVE THE PLANT MATERIAL AND MAKE ADJUSTMENTS AS NECESSARY FOR PROPER PLANT WATER REQUIREMENT.

TREE EMITTER PLACEMENT

SCALE: NTS



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1. COMPACT SOIL AROUND VALVE BOX TO THE SAME DENSITY AS ADJACENT UNDISTURBED

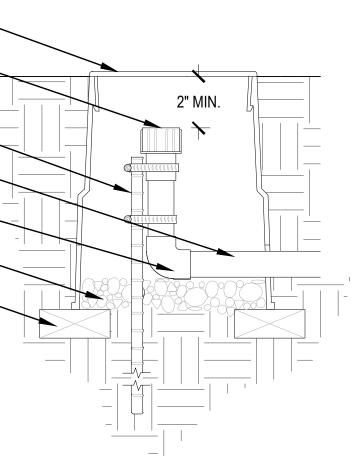2. SECURE STAKE TO FLUSH END CAP WITH A MIN. OF TWO S.S. CLAMPS.

SCALE: NTS

LOCKING ROUND BOX & COVER
 PER SCHEDULE. TOP OF BOX TO

(2) HOSE END SELF FLUSH CAP

5 POLYETHYLENE LATERAL

6 ELBOW COMPRESSION FITTING

(7) 3/4" GRAVEL SUMP- 4" DEPTH

(8) BRICK (2 REQUIRED MIN.)

(3) FINISH GRADE

CLAMPS

BE FLUSH WITH FINISH GRADE

24" #4 REBAR TO HOLD END CAP
 IN PLACE W/ (2) STAINLESS STEEL


CORNER \succ **GHB**

OWNER: BOULDER COUNTY HOUSING AUTHORITY 3400 BROADWAY BOULDER, CO - 80304 303.441.3861 CONTACT: MOLLY CHIANG

DATE:
06.17.22 - SITE PLAN 01
SHEET TITLE:
IRRIGATION
DETAILS

MATERIAL	DESCRIPTION
B-1	BRICK VENEER, LIGHT COLORED
B-2	BRICK VENEER, DARK COLORED
B-3	BRICK VENEER, CHARCOAL
MT-1	METAL PANEL
P-1	FIBER CEMENT PANEL BOARD SIDING, ACCENT COLOR
P-2	FIBER CEMENT BOARD & BATTEN SIDING
P-3	FIBER CEMENT 6" LAP SIDING
P-4	FIBER CEMENT VERTICAL WOOD GRAIN
P-5	FIBER CEMENT SHINGLE WALL PANEL
P-6	FIBER CEMENT 10" LAP SIDING BOARD
P-7	FIBER CEMENT PANEL BOARD SIDING
P-8	FIBER CEMENT VERTICAL SIDING
RF-1	ASPHALT SHINGLE ROOF
RF-2	MEMBRANE ROOF
RF-3	STANDING SEAM ROOF

WILLOUGHBY CORNER SITE PLAN - PHASE 1 LOTS 160, 161, 164, 165, 166 & 167, & OUTLOTS F, I, J & K OF THE WILLOUGHBY CORNER SUBDIVISION, CITY OF LAFAYETTE, COUNTY OF BOULDER, STATE OF COLORADO

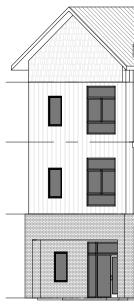





 $\begin{array}{|c|c|c|c|}\hline 3 & \text{SOUTH ELEVATION WEST WING} \\\hline 3^{1} & 1/8" = 1'-0" \end{array}$

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DATE: <u>06.17.22 - SITE PLAN 01</u>

> SHEET TITLE: SENIOR BLDG ELEVATIONS

MATERIAL	DESCRIPTION
B-1	BRICK VENEER, LIGHT COLORED
B-2	BRICK VENEER, DARK COLORED
B-3	BRICK VENEER, CHARCOAL
MT-1	METAL PANEL
P-1	FIBER CEMENT PANEL BOARD SIDING, ACCENT COLOR
P-2	FIBER CEMENT BOARD & BATTEN SIDING
P-3	FIBER CEMENT 6" LAP SIDING
P-4	FIBER CEMENT VERTICAL WOOD GRAIN
P-5	FIBER CEMENT SHINGLE WALL PANEL
P-6	FIBER CEMENT 10" LAP SIDING BOARD
P-7	FIBER CEMENT PANEL BOARD SIDING
P-8	FIBER CEMENT VERTICAL SIDING
RF-1	ASPHALT SHINGLE ROOF
RF-2	MEMBRANE ROOF
RF-3	STANDING SEAM ROOF

WILLOUGHBY CORNER SITE PLAN - PHASE 1 LOTS 160, 161, 164, 165, 166 & 167, & OUTLOTS F, I, J & K OF THE WILLOUGHBY CORNER SUBDIVISION, CITY OF LAFAYETTE, COUNTY OF BOULDER, STATE OF COLORADO $\left|\right\rangle$ \mathbf{F} $\left\{ \right\}$ ₽ K Ŕ







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SHEET TITLE: SENIOR BLDG ELEVATIONS

81





BRICK VENEER, LIGHT COLORED BRICK VENEER, DARK COLORED BRICK VENEER, CHARCOAL METAL PANEL FIBER CEMENT PANEL BOARD SIDING, ACCENT COLOR FIBER CEMENT BOARD & BATTEN SIDING FIBER CEMENT 6" LAP SIDING FIBER CEMENT 6" LAP SIDING FIBER CEMENT VERTICAL WOOD GRAIN FIBER CEMENT SHINGLE WALL PANEL FIBER CEMENT 10" LAP SIDING BOARD FIBER CEMENT PANEL BOARD SIDING FIBER CEMENT VERTICAL SIDING

DESCRIPTION

MATERIAL

B-1

B-2

B-3

MT-1

P-1

P-2

P-3

P-4

P-5

P-6

P-7

P-8

RF-1

RF-2

RF-3

ASPHALT SHINGLE ROOF

STANDING SEAM ROOF

MEMBRANE ROOF

WILLOUGHBY CORNER SITE PLAN - PHASE 1 LOTS 160, 161, 164, 165, 166 & 167, & OUTLOTS F, I, J & K OF THE WILLOUGHBY CORNER SUBDIVISION, CITY OF LAFAYETTE, COUNTY OF BOULDER, STATE OF COLORADO


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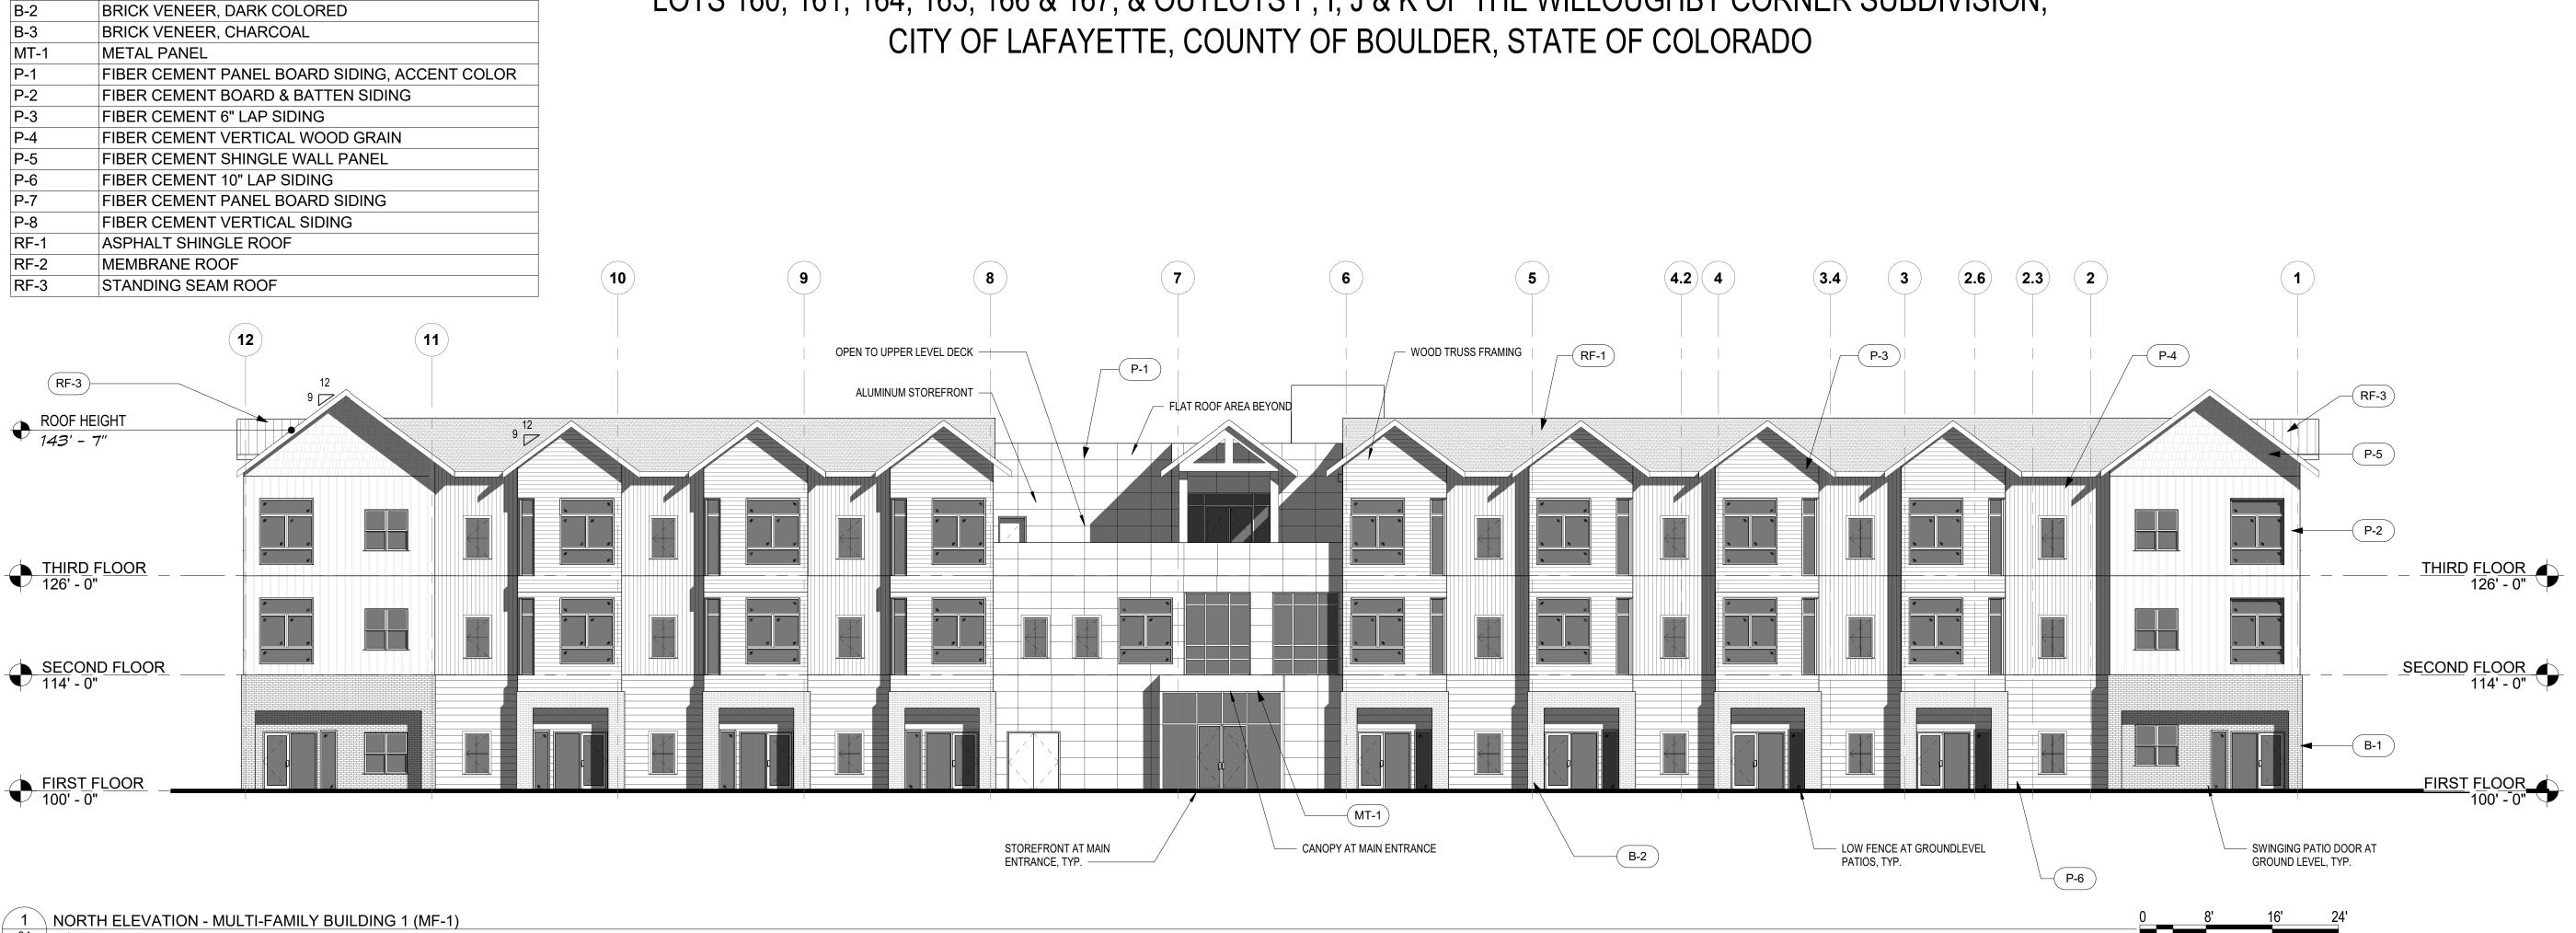
1101 Bannock Street Denver, Colorado 80204 P 303.892.1166 www.norris-design.com

CORNER OUGHBY TOP OF WALL 3 136' - 0" AN _T<u>HIRD FLOOR</u> 126' - 0" WILL SITE PLA SECOND FLOOR 114' - 0" FIRST FLOOR 100' - 0" OWNER: BOULDER COUNTY HOUSING AUTHORITY 3400 BROADWAY 0 8' 16' BOULDER, CO - 80304 303.441.3861 CONTACT: MOLLY CHIANG (**C**) D ROOF HEIGHT 143' - 7" DATE: <u>06.17.22 - SITE PLAN 01</u> THIRD FLOOR 126' - 0" SECOND FLOOR 114' - 0" FIRST FLOOR 100' - 0" SHEET TITLE: **SENIOR BLDG** VINYL WINDOWS, TYP -ELEVATIONS 8

2 SOUTH ELEVATION - MULTI-FAMILY BUILDING 1 (MF-1) ³⁴ 3/32" = 1'-0"





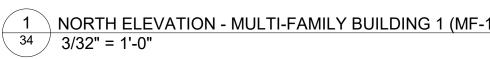

MATERIAL

B-1

DESCRIPTION

BRICK VENEER, LIGHT COLORED

WILLOUGHBY CORNER SITE PLAN - PHASE 1

LOTS 160, 161, 164, 165, 166 & 167, & OUTLOTS F, I, J & K OF THE WILLOUGHBY CORNER SUBDIVISION,



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OWNER: BOULDER COUNTY HOUSING AUTHORITY 3400 BROADWAY BOULDER, CO - 80304 303.441.3861 CONTACT: MOLLY CHIANG

DATE: <u>06.17.22 - SITE PLAN 01</u>


> SHEET TITLE: MF1 BUILDING ELEVATIONS

 $\underbrace{\operatorname{\mathfrak{SII}}}$

34

MATERIAL	DESCRIPTION
B-1	BRICK VENEER, LIGHT COLORED
B-2	BRICK VENEER, DARK COLORED
B-3	BRICK VENEER, CHARCOAL
MT-1	METAL PANEL
P-1	FIBER CEMENT PANEL BOARD SIDING, ACCENT COLOR
P-2	FIBER CEMENT BOARD & BATTEN SIDING
P-3	FIBER CEMENT 6" LAP SIDING
P-4	FIBER CEMENT VERTICAL WOOD GRAIN
P-5	FIBER CEMENT SHINGLE WALL PANEL
P-6	FIBER CEMENT 10" LAP SIDING
P-7	FIBER CEMENT PANEL BOARD SIDING
P-8	FIBER CEMENT VERTICAL SIDING
RF-1	ASPHALT SHINGLE ROOF
RF-2	MEMBRANE ROOF
RF-3	STANDING SEAM ROOF


 $\begin{array}{c|c} 1 & \text{WEST ELEVATION - MULTI-FAMILY BUILDING 1 (MF-1)} \\ \hline 35 & 3/32" = 1'-0" \end{array}$

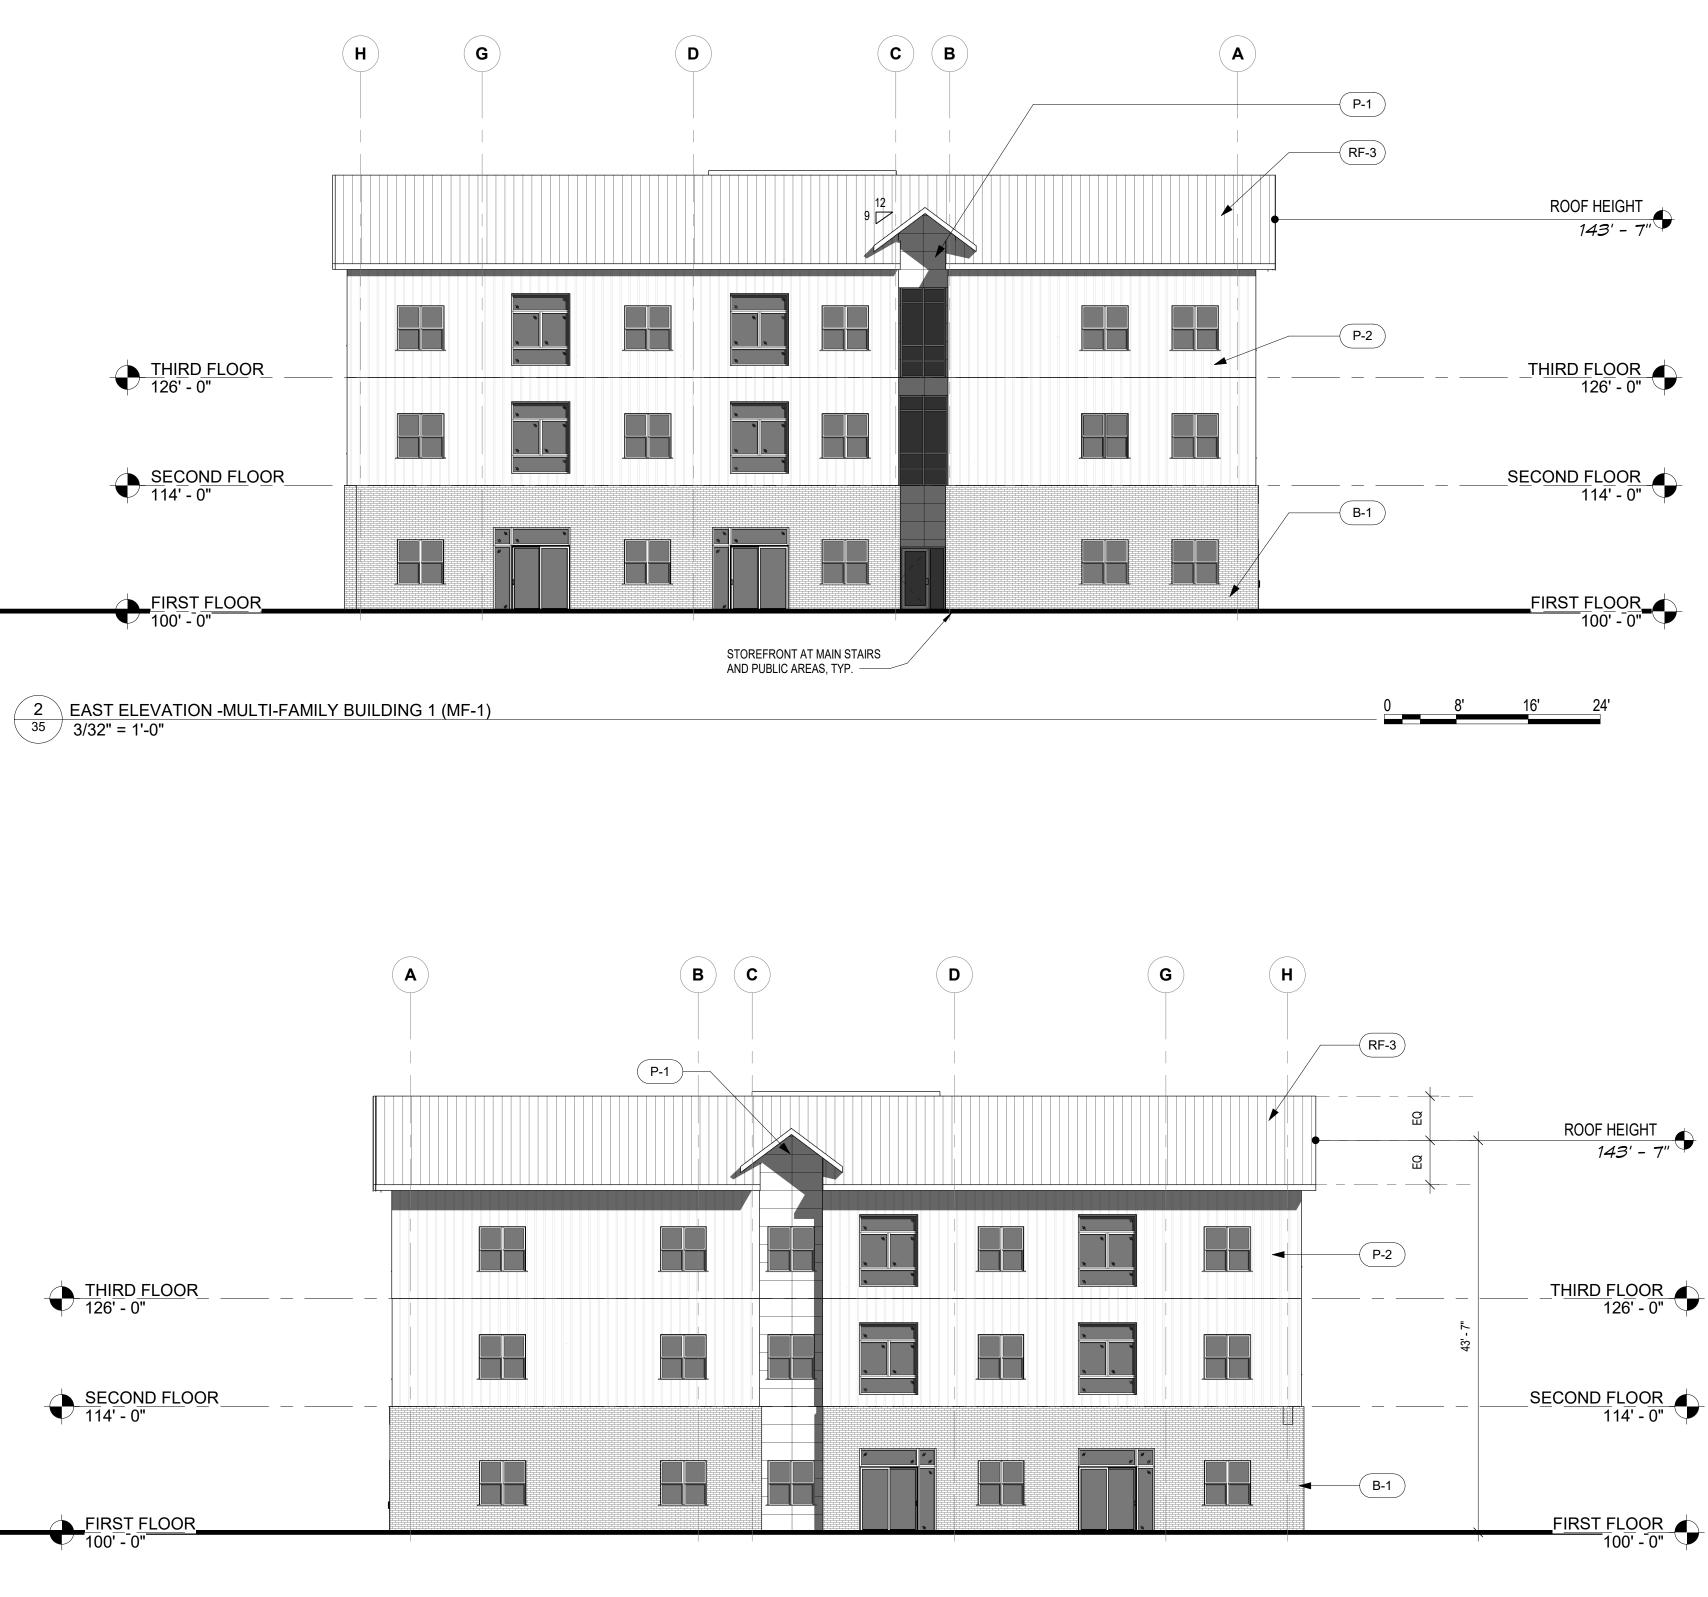

WILLOUGHBY CORNER SITE PLAN - PHASE 1 LOTS 160, 161, 164, 165, 166 & 167, & OUTLOTS F, I, J & K OF THE WILLOUGHBY CORNER SUBDIVISION, CITY OF LAFAYETTE, COUNTY OF BOULDER, STATE OF COLORADO

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DATE: <u>06.17.22 - SITE PLAN 01</u>

> SHEET TITLE: MF1 BUILDING ELEVATIONS

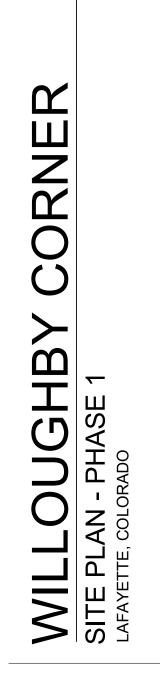

35

DESCRIPTION

B-1	BRICK VENEER, LIGHT COLORED
B-2	BRICK VENEER, DARK COLORED
B-3	BRICK VENEER, CHARCOAL
MT-1	METAL PANEL
P-1	FIBER CEMENT PANEL BOARD SIDING, ACCENT COLOR
P-2	FIBER CEMENT BOARD & BATTEN SIDING
P-3	FIBER CEMENT 6" LAP SIDING
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P-5	FIBER CEMENT SHINGLE WALL PANEL
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P-8	FIBER CEMENT VERTICAL SIDING
RF-1	ASPHALT SHINGLE ROOF
RF-2	MEMBRANE ROOF
RF-3	STANDING SEAM ROOF





WILLOUGHBY CORNER SITE PLAN - PHASE 1 LOTS 160, 161, 164, 165, 166 & 167, & OUTLOTS F, I, J & K OF THE WILLOUGHBY CORNER SUBDIVISION,

CITY OF LAFAYETTE, COUNTY OF BOULDER, STATE OF COLORADO

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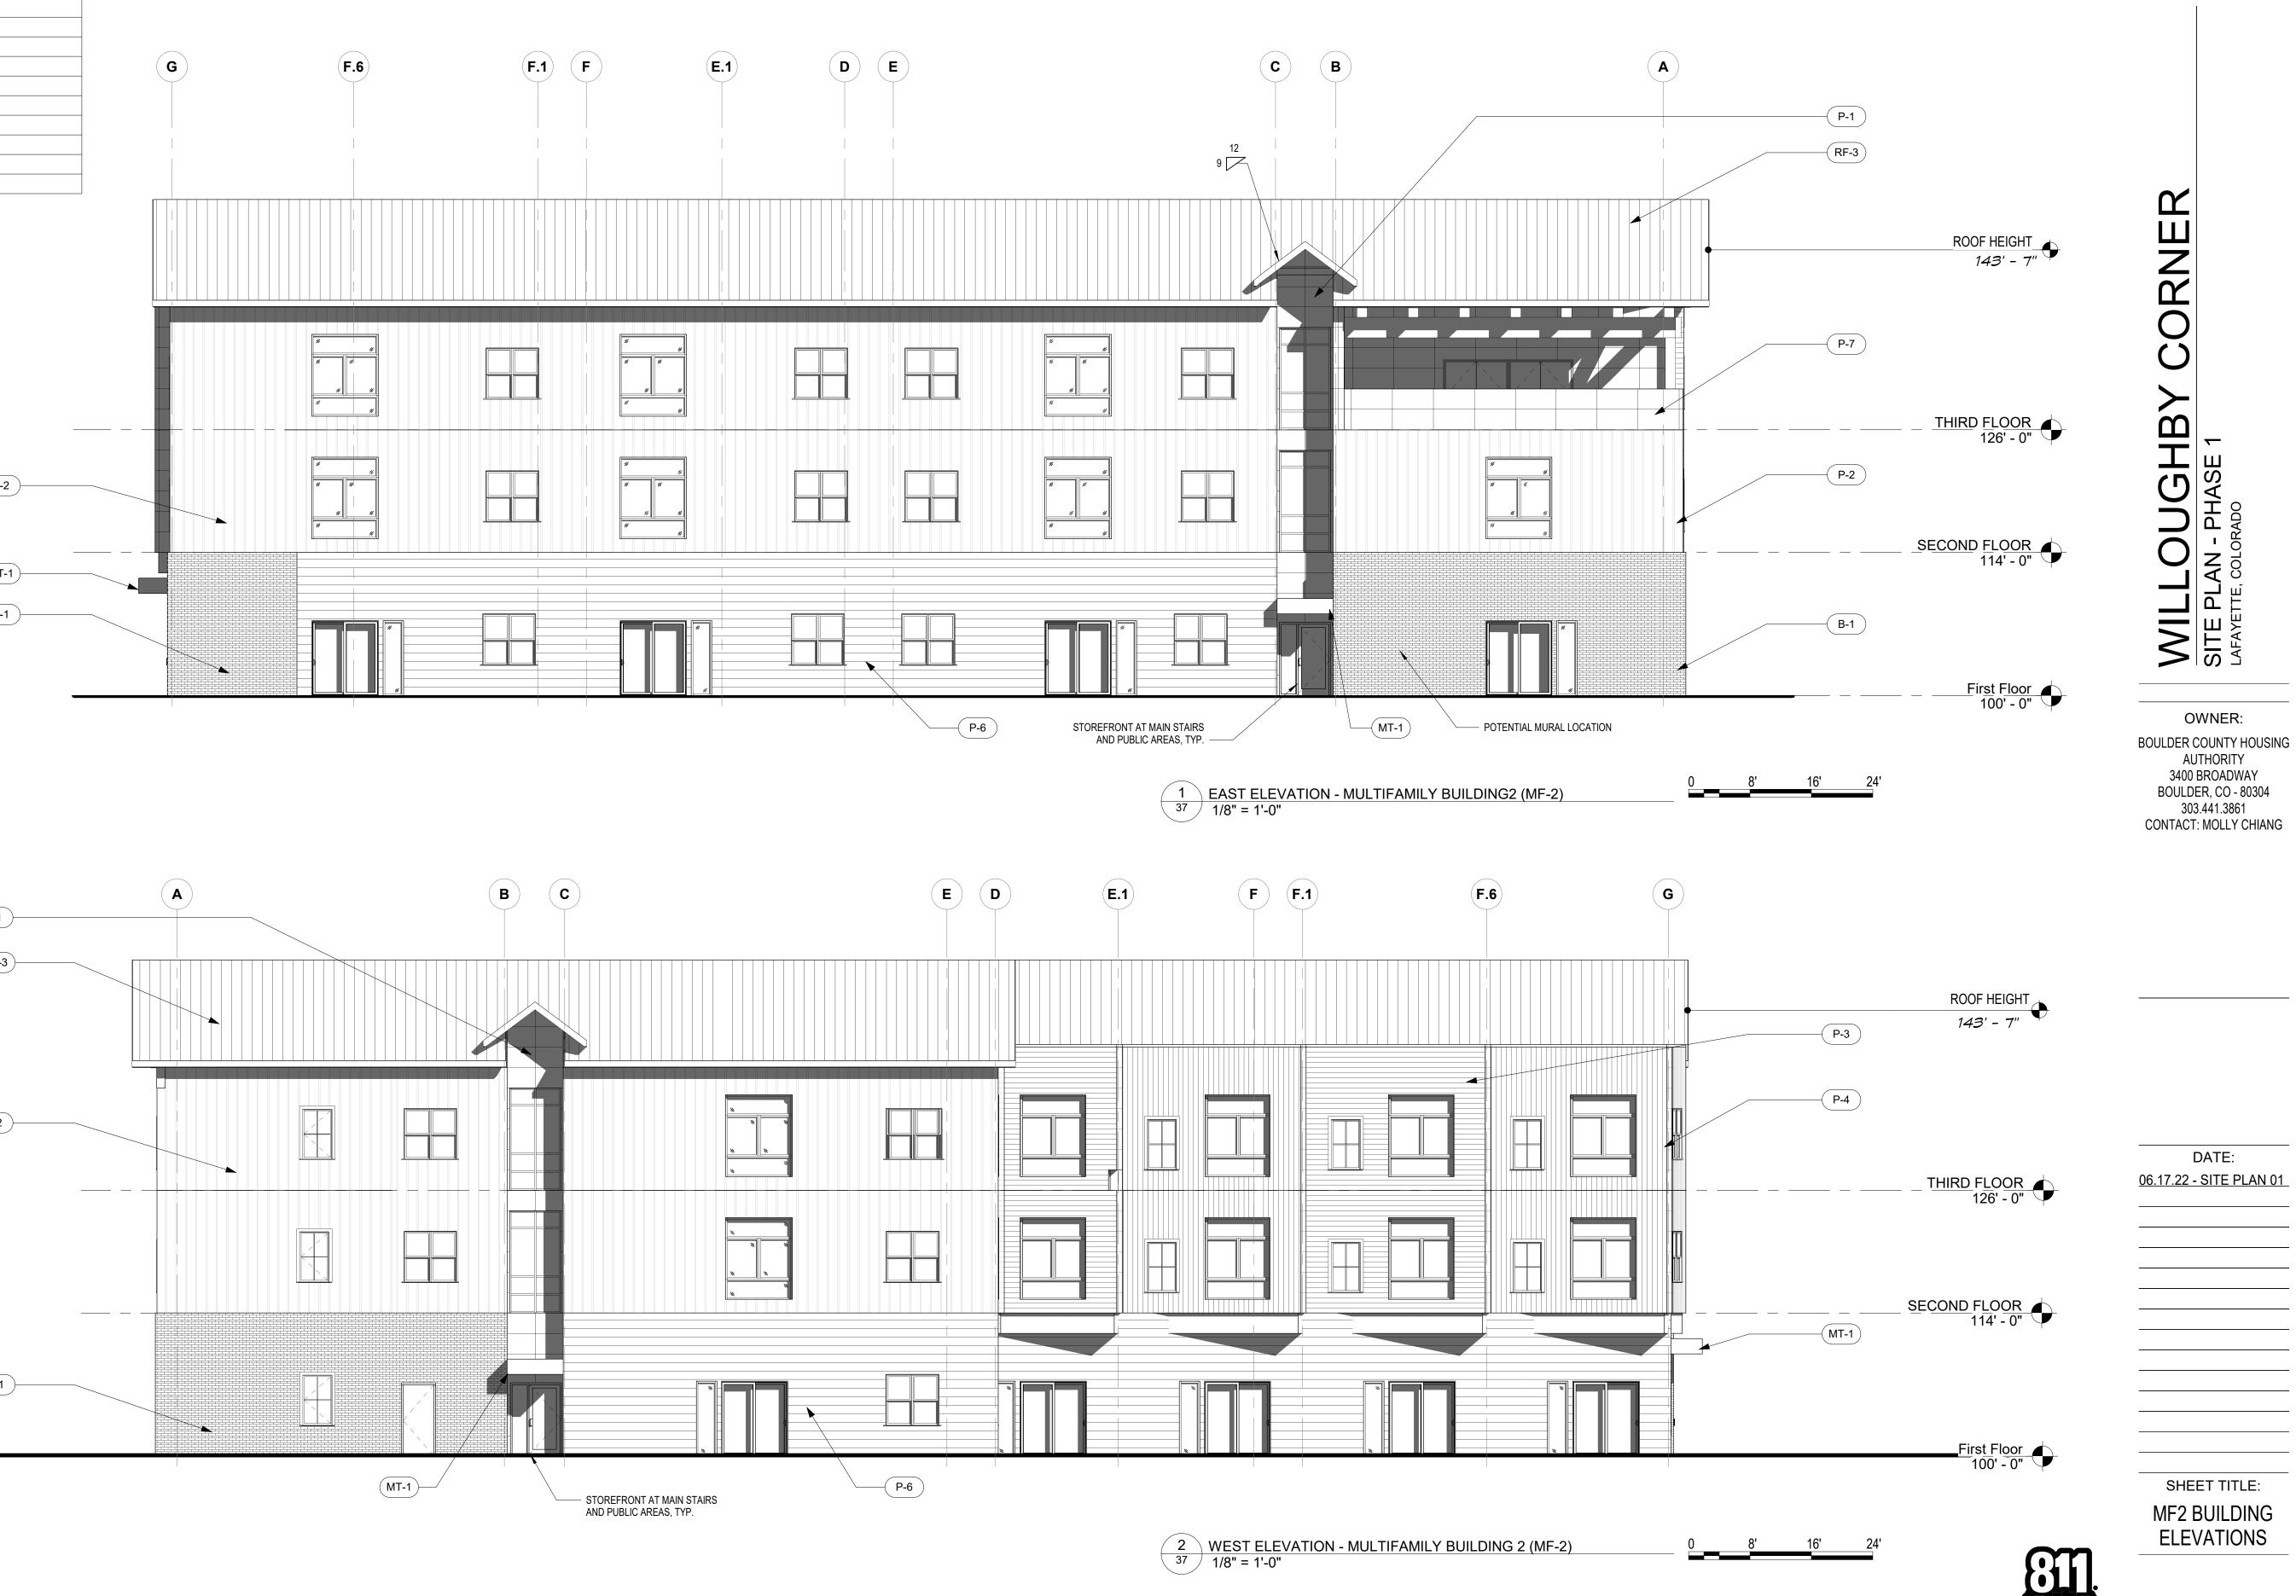
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SHEET TITLE: MF2 BUILDING ELEVATIONS

AN SITE F OWNER: BOULDER COUNTY HOUSING AUTHORITY 3400 BROADWAY BOULDER, CO - 80304 303.441.3861 CONTACT: MOLLY CHIANG

DATE: <u>06.17.22 - SITE PLAN 01</u>

MATERIAL	DESCRIPTION
B-1	BRICK VENEER, LIGHT COLORED
B-2	BRICK VENEER, DARK COLORED
B-3	BRICK VENEER, CHARCOAL
MT-1	METAL PANEL
P-1	FIBER CEMENT PANEL BOARD SIDING, ACCENT COLOR
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P-8	FIBER CEMENT VERTICAL SIDING
RF-1	ASPHALT SHINGLE ROOF
RF-2	MEMBRANE ROOF
RF-3	STANDING SEAM ROOF





Checker Author CHECKED BY: DRAWN BY:

WILLOUGHBY CORNER SITE PLAN - PHASE 1 LOTS 160, 161, 164, 165, 166 & 167, & OUTLOTS F, I, J & K OF THE WILLOUGHBY CORNER SUBDIVISION,

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MATERIAL	DESCRIPTION
B-1	BRICK VENEER, LIGHT COLORED
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RF-2	MEMBRANE ROOF
RF-3	STANDING SEAM ROOF

Checke Author CHECKED BY: DRAWN BY:

WILLOUGHBY CORNER SITE PLAN - PHASE 1 LOTS 160, 161, 164, 165, 166 & 167, & OUTLOTS F, I, J & K OF THE WILLOUGHBY CORNER SUBDIVISION,

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CORNER IGHBY OWNER: BOULDER COUNTY HOUSING AUTHORITY 3400 BROADWAY

BOULDER, CO - 80304 303.441.3861 CONTACT: MOLLY CHIANG


DATE: <u>06.17.22 - SITE PLAN 01</u>

> SHEET TITLE: COMM. BLDG ELEVATIONS





MATERIAL	DESCRIPTION
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B-2	BRICK VENEER, DARK COLORED
B-3	BRICK VENEER, CHARCOAL COLORED
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RF-2	ROOF MEMBRANE
RF-3	STANDING SEAM ROOF

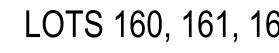







WILLOUGHBY CORNER SITE PLAN - PHASE 1 LOTS 160, 161, 164, 165, 166 & 167, & OUTLOTS F, I, J & K OF THE WILLOUGHBY CORNER SUBDIVISION, CITY OF LAFAYETTE, COUNTY OF BOULDER, STATE OF COLORADO

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MATERIAL	DESCRIPTION
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RF-2	ROOF MEMBRANE
RF-3	STANDING SEAM ROOF

WILLOUGHBY CORNER SITE PLAN - PHASE 1 LOTS 160, 161, 164, 165, 166 & 167, & OUTLOTS F, I, J & K OF THE WILLOUGHBY CORNER SUBDIVISION, CITY OF LAFAYETTE, COUNTY OF BOULDER, STATE OF COLORADO







Checke Author CHECKED BY: DRAWN BY:

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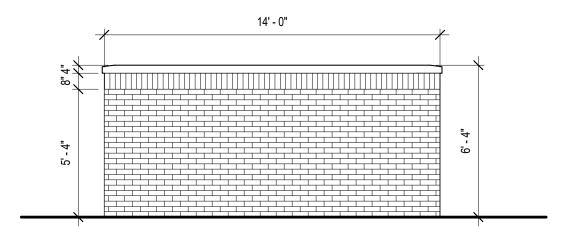
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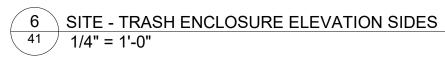
40


MATERIAL	DESCRIPTION
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P-8	FIBER CEMENT VERTICAL SIDING
RF-1	ASPHALT SHINGLE ROOF
RF-2	MEMBRANE ROOF
RF-3	STANDING SEAM ROOF

		17' - 4"	
- 1	~		_
8 "4 "4	<u> </u>		
5' - 4"			
	•		

SITE - TRASH ENCLOSURE ELEVATION REAR 8 SITE - TRAS





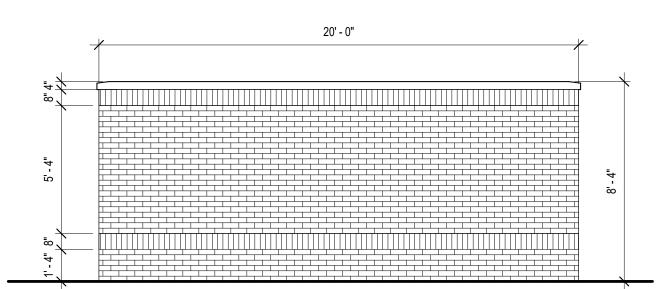





3 SITE - GENERATOR ENCLOSURE ELEVATION REAR 41 1/4" = 1'-0"

WILLOUGHBY CORNER SITE PLAN - PHASE 1

LOTS 160, 161, 164, 165, 166 & 167, & OUTLOTS F, I, J & K OF THE WILLOUGHBY CORNER SUBDIVISION, CITY OF LAFAYETTE, COUNTY OF BOULDER, STATE OF COLORADO

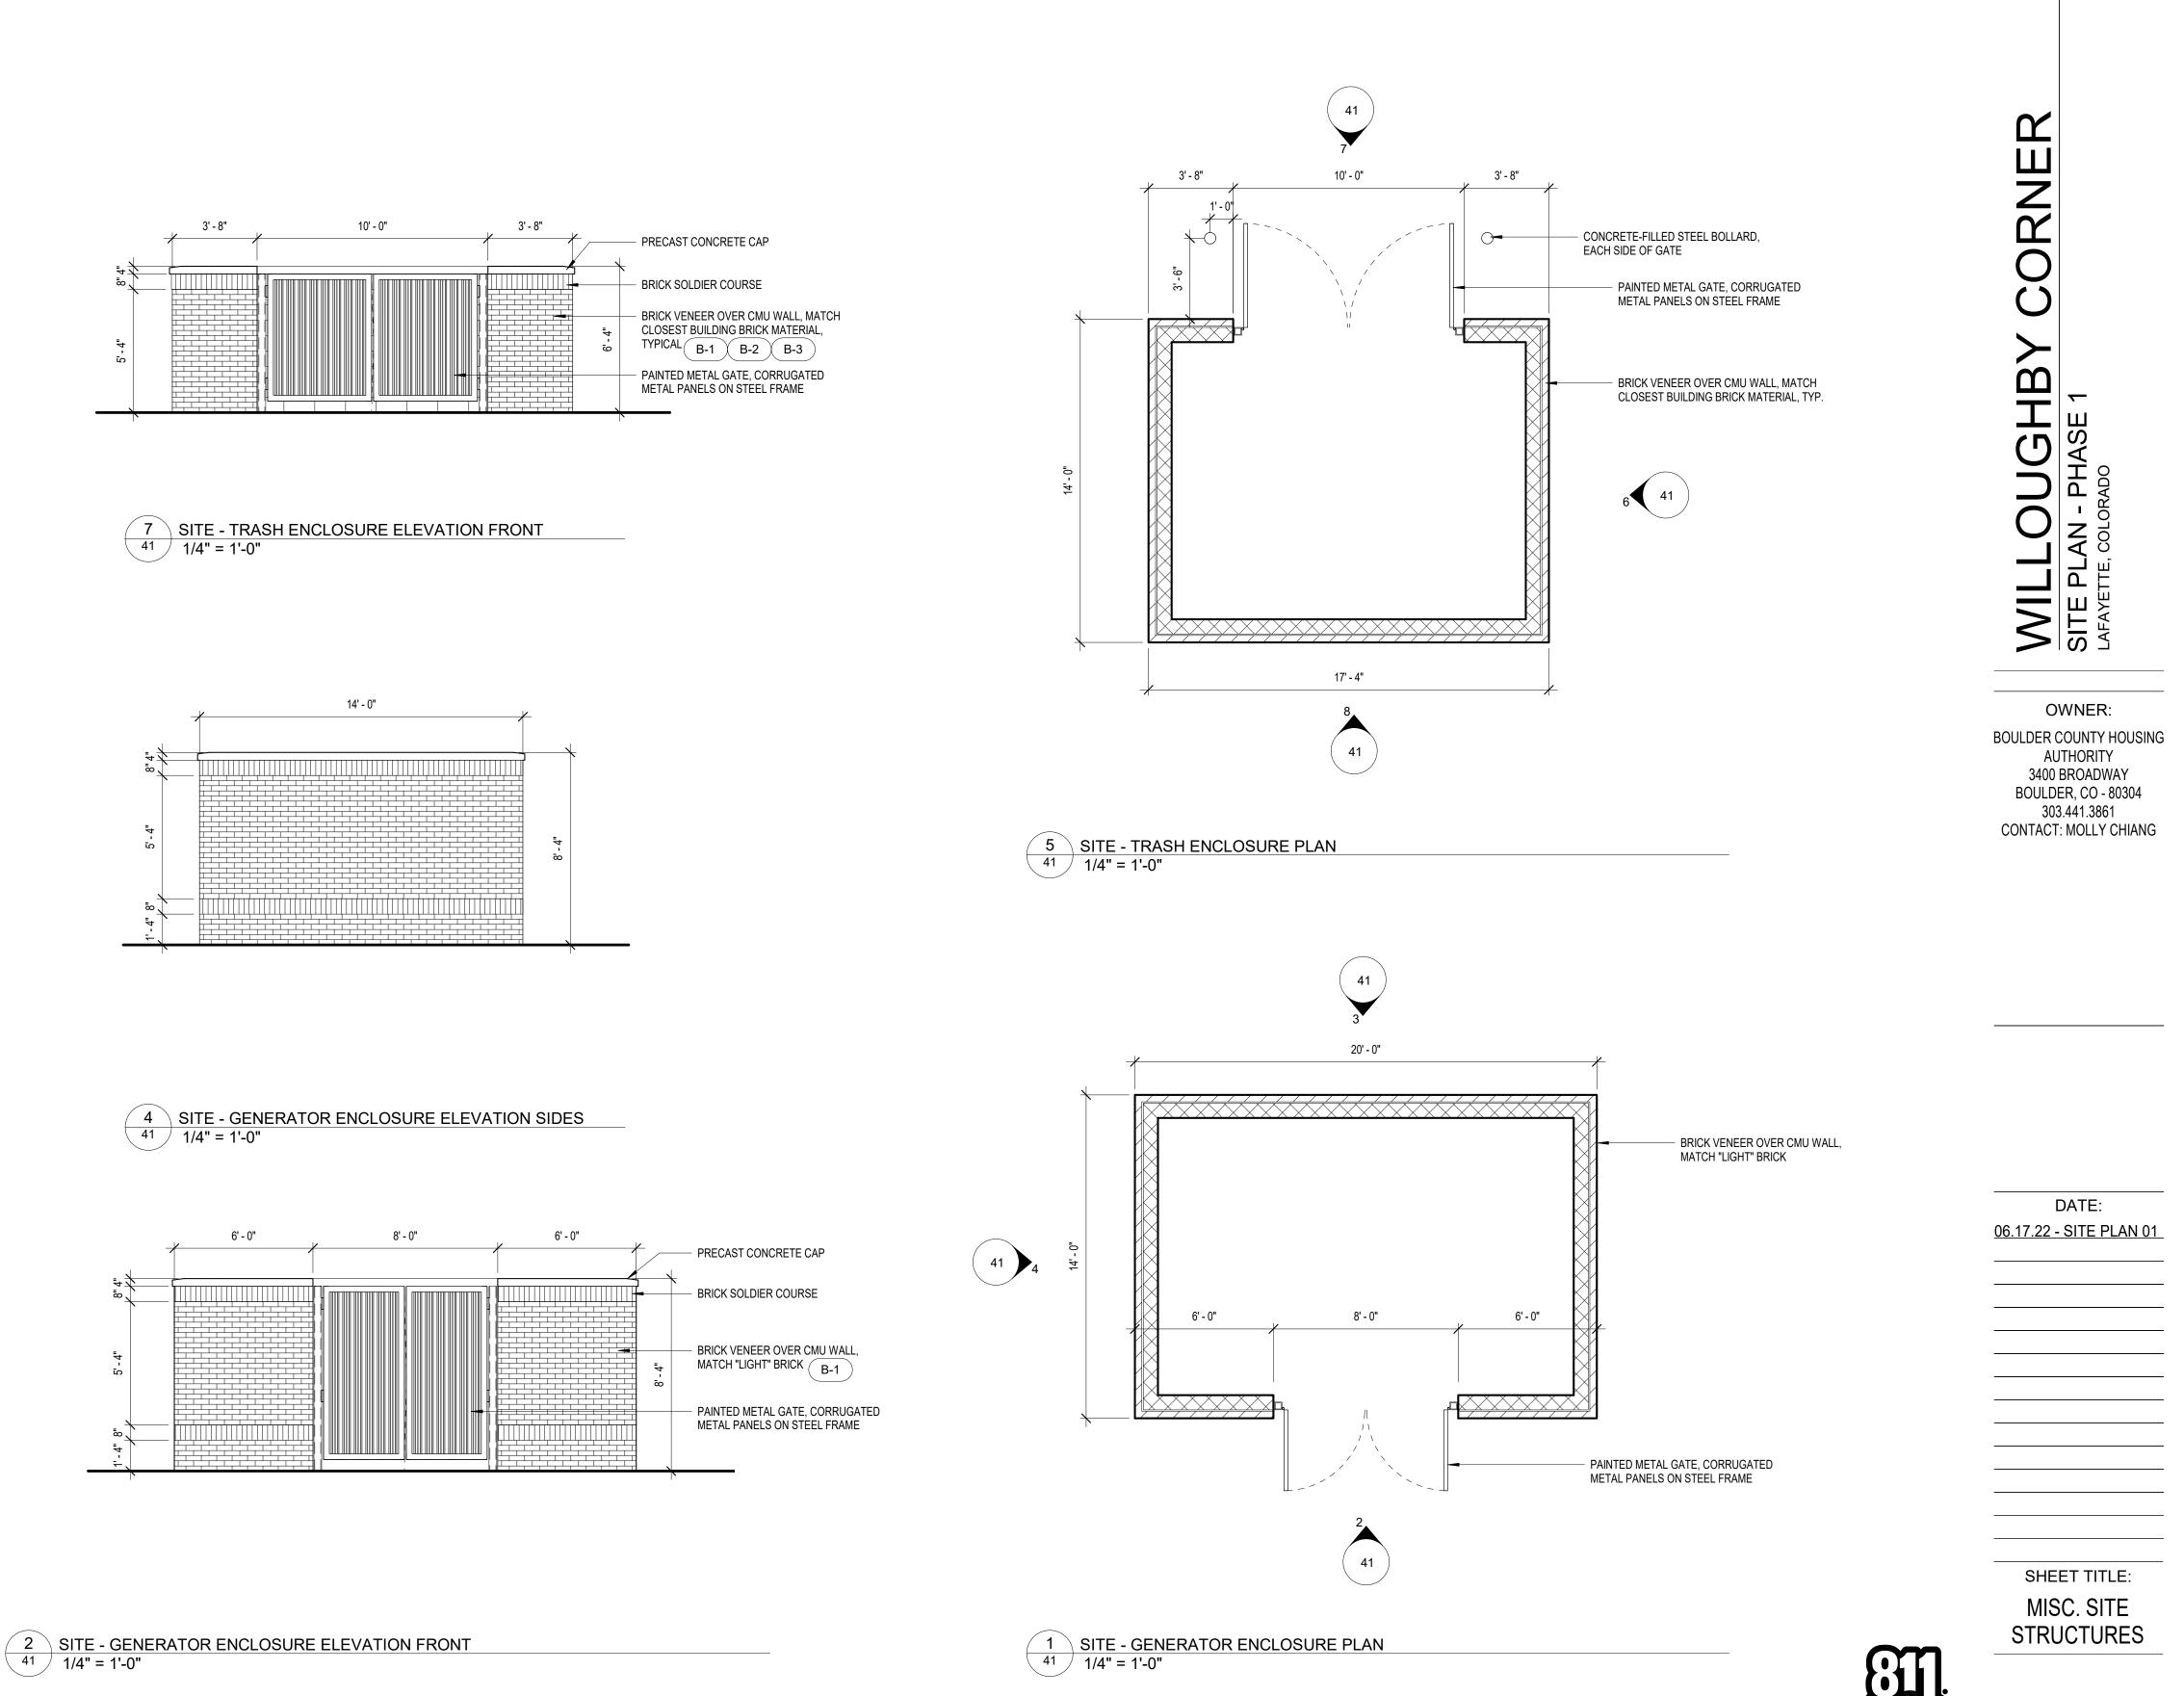

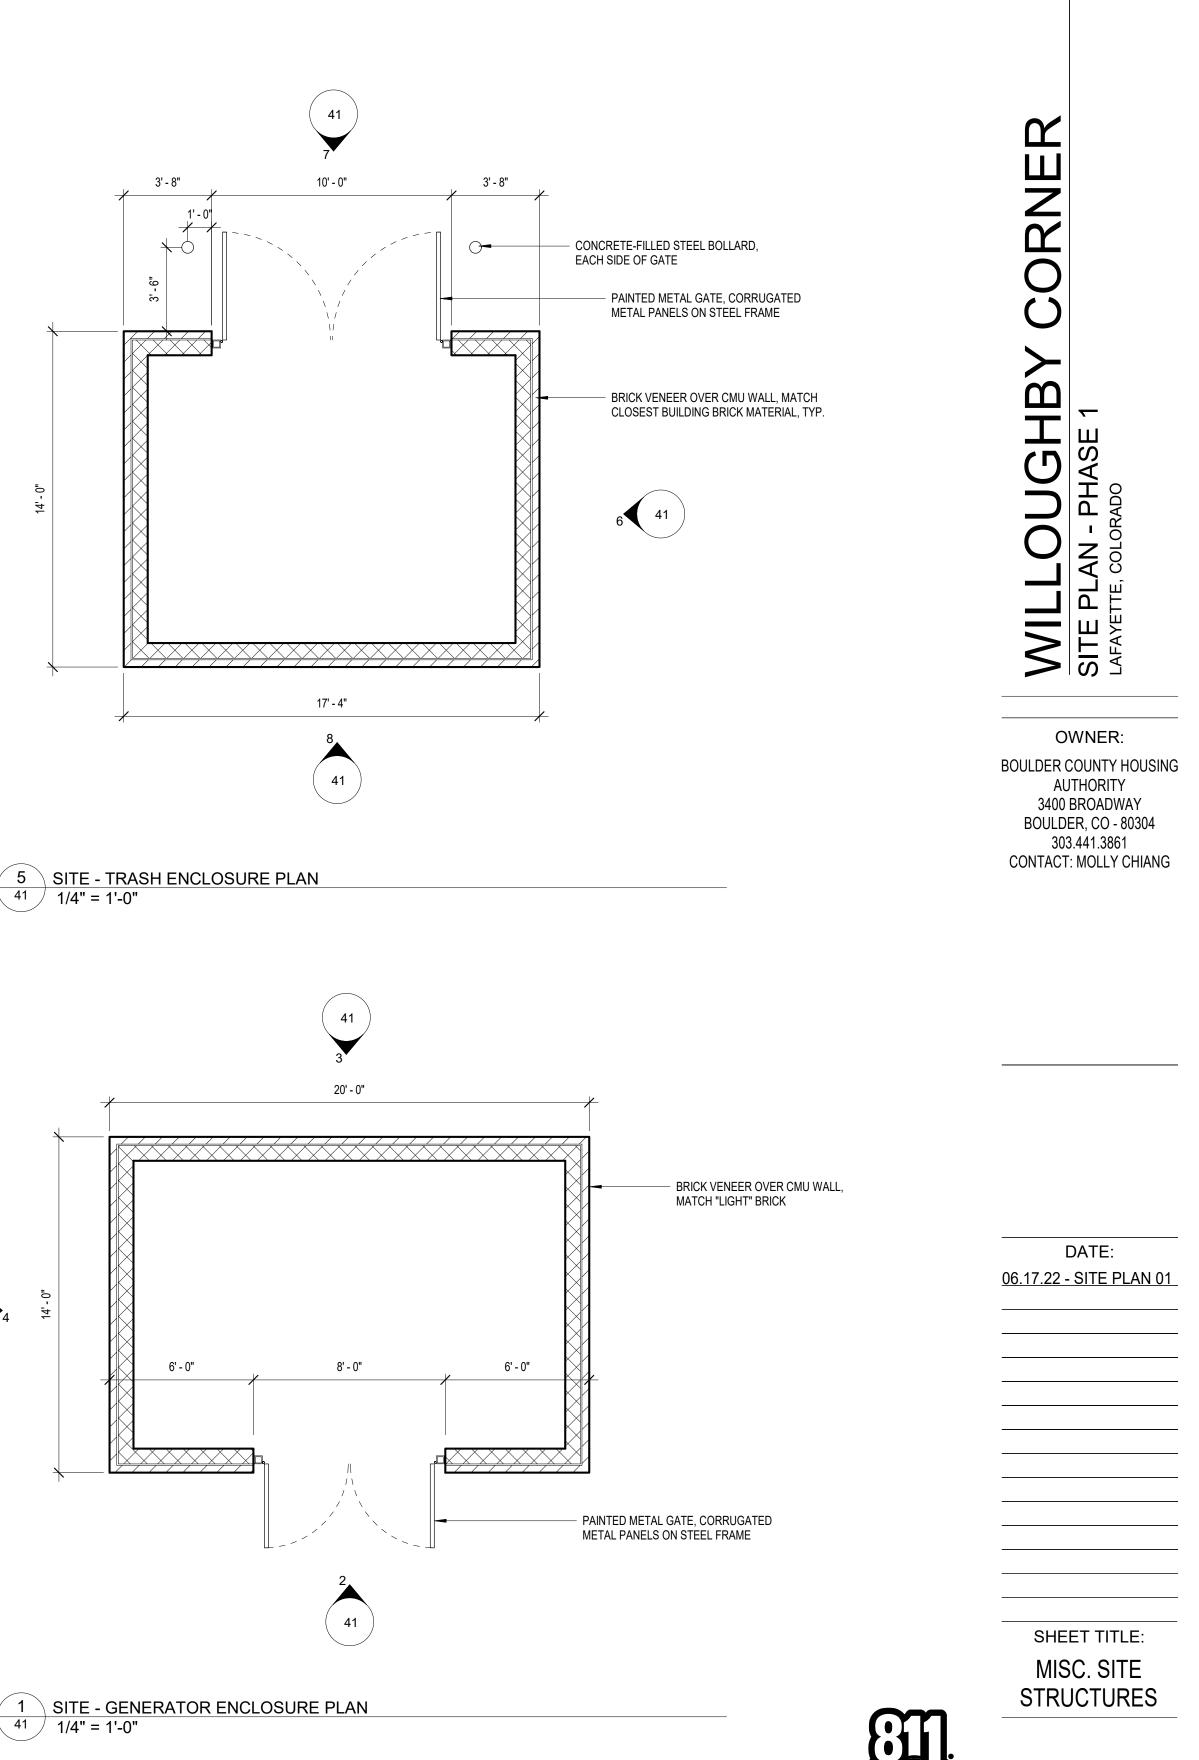

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						0.7 0.9 0.7 0.9 0.8 0.6 0.8 1.0 1.0 1.0 1.0 1.0 1.0 1.0 1.0	1.4 1.4 1.4 1.4 1.4 1.4 1.4 1.4			B1 8 0.7 0.5
				*****			0.9 1.0 1.1 0.9 1.2 1m,			
							A A B B C C C C C C C C C C C C C C C C			
	ISTIC	 S								
AVG	MAX	MIN	MAX/MIN	AVG/MIN			0.3 0.2			
.02 FC	6.6 FC	0.0 FC	NA	NA			1/2 8.64			
.03 FC .03 FC	4.9 FC 4.9 FC	0.1 FC 0.1 FC	49:1 49:1	10:1			BIELE			
.48 FC	5.2 FC	0.1 FC	52:1	10:1			7 3.0			$\langle \rangle \langle \rangle$
2.08 FC	5.5 FC	0.2 FC	27:1	10:1		Ŕ				\square
.97 FC .51 FC	5.4 FC 3.8 FC	0.5 FC 0.1 FC	11:1 38:01:00	4:1 15:01					H	\square
							0.5 0. 0.7 0. 0.7 1.0 0.7 1		.9 b.	

S

SYMBOL	AVG	MAX	MIN	MAX/MIN	AVG/MIN
+	1.02 FC	6.6 FC	0.0 FC	NA	NA
+	1.03 FC	4.9 FC	0.1 FC	49:1	10:1
+	1.03 FC	4.9 FC	0.1 FC	49:1	10:1
+	1.48 FC	5.2 FC	0.1 FC	52:1	10:1
+	2.08 FC	5.5 FC	0.2 FC	27:1	10:1
+	1.97 FC	5.4 FC	0.5 FC	11:1	4:1
+	1.51 FC	3.8 FC	0.1 FC	38:01:00	15:01
	+ + + + +	+ 1.03 FC + 1.48 FC + 2.08 FC + 1.97 FC	+ 1.03 FC 4.9 FC + 1.48 FC 5.2 FC + 2.08 FC 5.5 FC + 1.97 FC 5.4 FC	+ 1.03 FC 4.9 FC 0.1 FC + 1.48 FC 5.2 FC 0.1 FC + 2.08 FC 5.5 FC 0.2 FC + 1.97 FC 5.4 FC 0.5 FC	+ 1.03 FC 4.9 FC 0.1 FC 49:1 + 1.48 FC 5.2 FC 0.1 FC 52:1 + 2.08 FC 5.5 FC 0.2 FC 27:1 + 1.97 FC 5.4 FC 0.5 FC 11:1






1

WILLOUGHBY CORNER SITE PLAN - PHASE 1

LOTS 160, 161, 164, 165, 166 & 167, & OUTLOTS F, I, J & K OF THE WILLOUGHBY CORNER SUBDIVISION, CITY OF LAFAYETTE, COUNTY OF BOULDER, STATE OF COLORADO

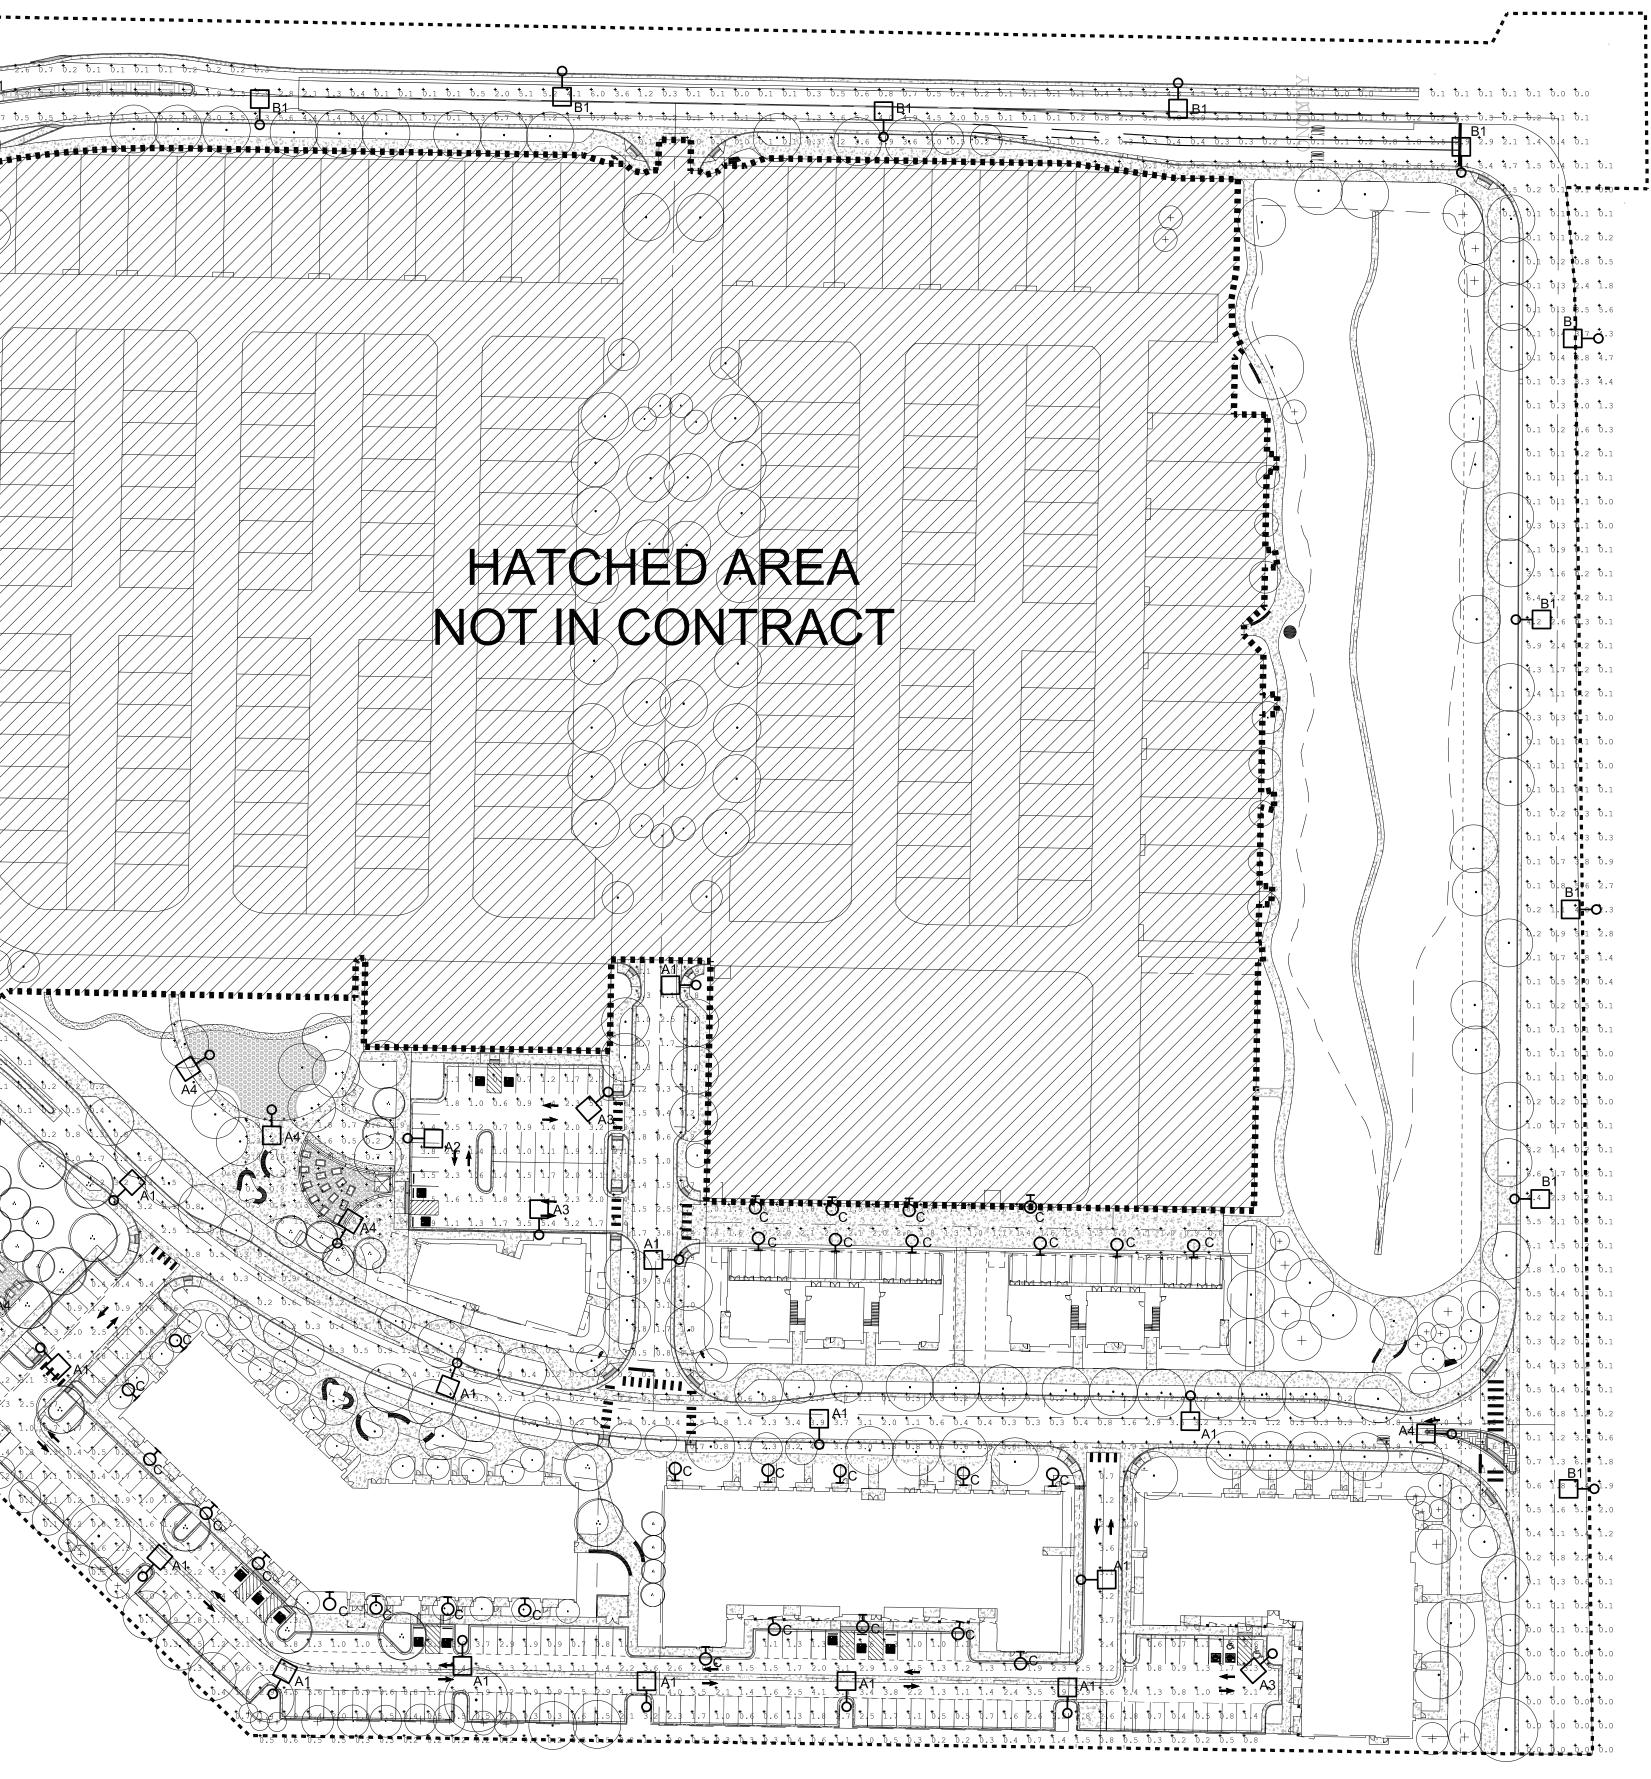



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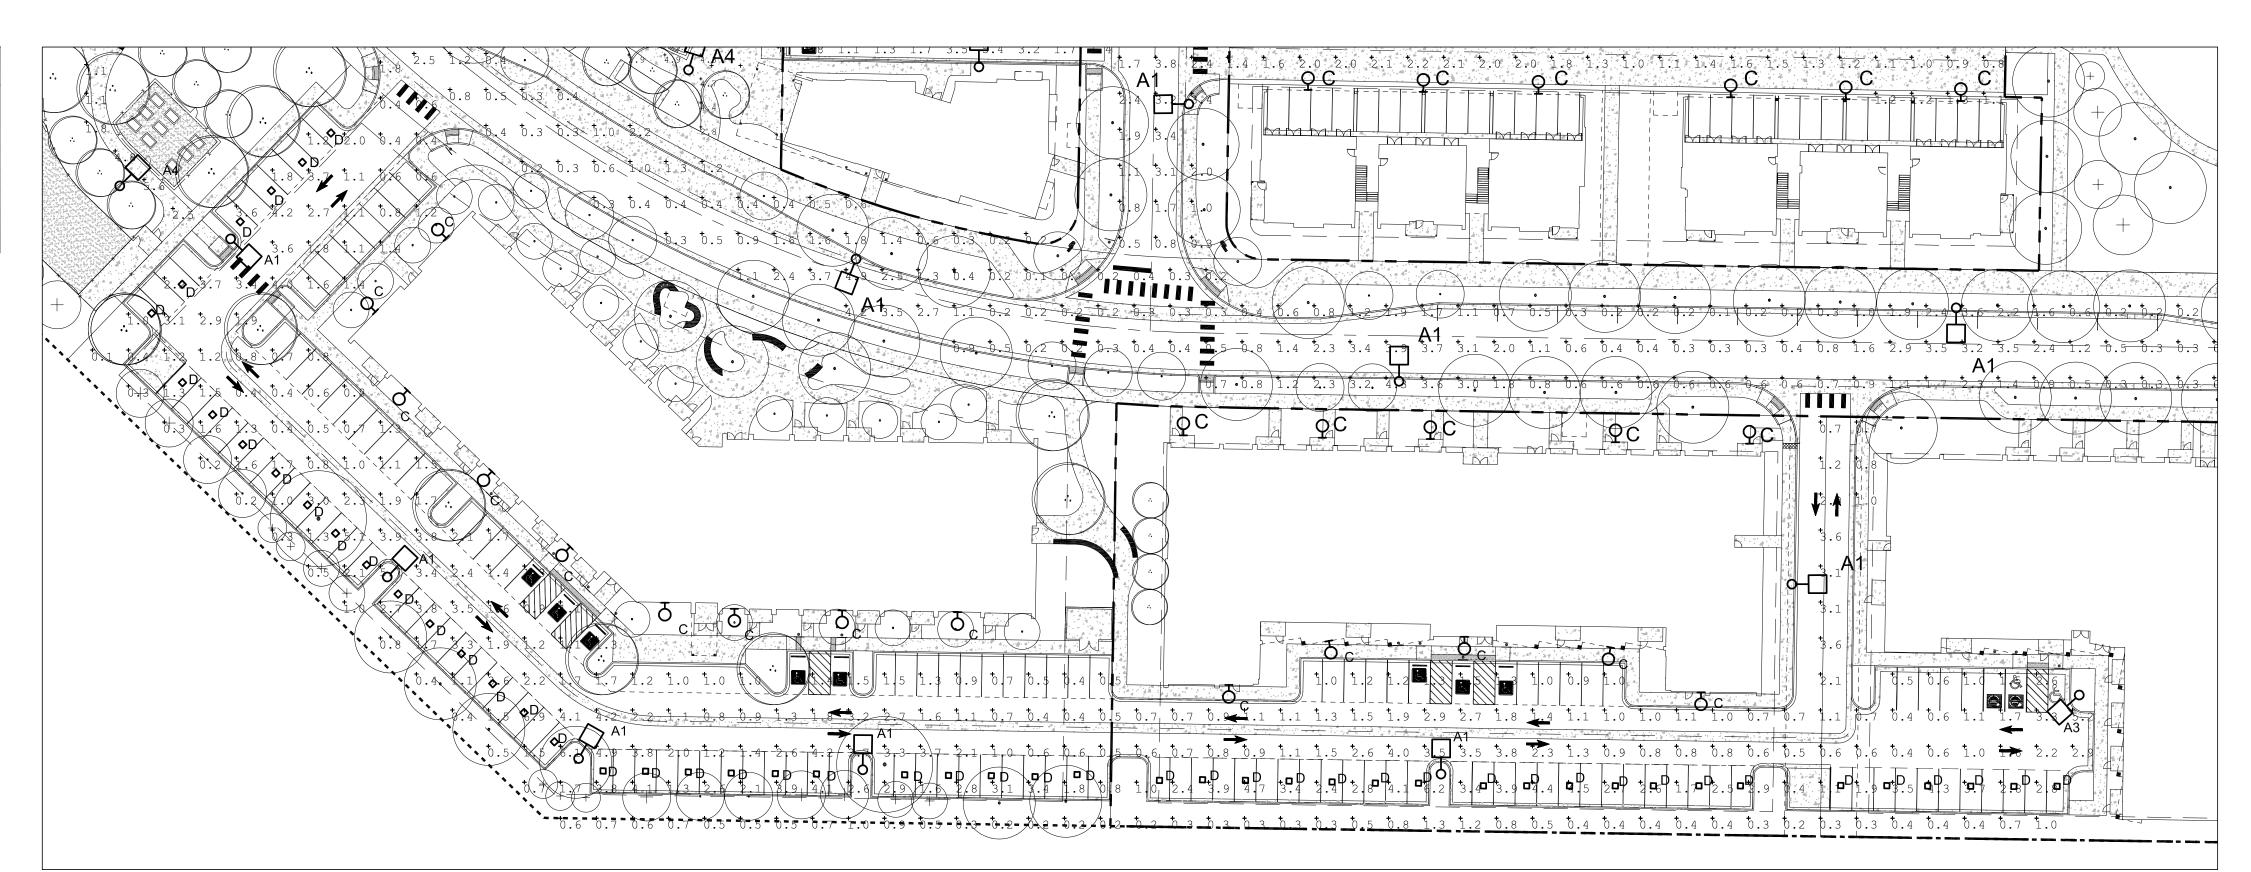
R ORNEI \mathbf{m}

OWNER: BOULDER COUNTY HOUSING AUTHORITY 3400 BROADWAY BOULDER, CO - 80304 303.441.3861 CONTACT: MOLLY CHIANG

DATE: <u>06.17.22 - SITE PLAN 01</u>

SHEET TITLE: SITE PHOTOMETRICS

TYPE	MANUFACTURER	CATALOG NUMBER	LAMP DESCRIPTION	VOLTAGE	LOAD (VA)	FINISH	MOUNTING	DESCRIPTION
A1	VISIONAIRE LIGHTING	DDEN SERIES (TYPE 2 DISTRIBUTION)	LED, 3000K	MVOLT	177 WATTS	BLACK	25′ POLE	SPUN ALUMINUM AREA/ROADWAY LUMINAIRE WITH YOLK MOUNT ARM, 20000 LUMEN LED, TYPE 2 DISTRIBUTION
A2	VISIONAIRE LIGHTING	DDEN SERIES (TYPE 3 DISTRIBUTION)	LED, 3000K	M∨OLT	140 WATTS	BLACK	25′ POLE	SPUN ALUMINUM AREA/ROADWAY LUMINAIRE WITH YOLK MOUNT ARM, 16700 LUMEN LED, TYPE 3 DISTRIBUTION
A3	VISIONAIRE LIGHTING	DDEN SERIES (TYPE 4 DISTRIBUTION)	LED, 3000K	MVOLT	177 WATTS	BLACK	25′ POLE	SPUN ALUMINUM AREA/ROADWAY LUMINAIRE WITH YOLK MOUNT ARM, 20000 LUMEN LED, TYPE 4 DISTRIBUTION
Α4	VISIONAIRE LIGHTING	DDEN SERIES (TYPE 5W DISTRIBUTION)	LED, 3000K	MVOLT	177 WATTS	BLACK	25′ POLE	SPUN ALUMINUM AREA/ROADWAY LUMINAIRE WITH YOLK MOUNT ARM, 20000 LUMEN LED, TYPE 4 DISTRIBUTION
B1	VISIONAIRE LIGHTING	RLX-1 SERIES (TYPE 4A DISTRIBUTION)	LED, 3000K	MVOLT	140 WATTS	BLACK	25′ POLE	DIE CAST ALUMINUM LED COBRA HEAD LUMIANIRE WITH TYPE 4A DISTRIBUTION, 16700 LUMEN LED
B2	VISIONAIRE LIGHTING	RLX-1 SERIES (TYPE 5W DISTRIBUTION)	LED, 3000K	MVOLT	177 WATTS	BLACK	25′ POLE	DIE CAST ALUMINUM LED COBRA HEAD LUMIANIRE WITH TYPE 5W DISTRIBUTION, 20000 LUMEN LED
С	MCGRAW EDISON	IMPACT ELITE LED SERIES	LED, 3000K	MVOLT	20 WATTS	BLACK	WALL MOUNTED	LED WALL PACK WITH BLACK FINISH, TRAPAZDIDAL PROFILE, TYPE 3 DISTRIBUTION, 2500 LUMEN LED
D	FAILE-SAFE	H∨L8 LED SERIES (ALTERNATE PLAN ONLY) WITH VIBRATION DAMPERS BY THE FACTORY.	LED, 3000K	M∨OLT	5.8 WATTS	WHITE	SURFACE	12"X8" VANDAL RESISTANT LED CANOPY LUMINAIRE WITH OPAL POLYCARBONATE LENS, HEAVY DUTY EXTRUDED ALUMINUM



STATISTICS									
DESCRIPTION	SYMBOL	AVG	MAX	MIN	MAX/MIN	A∨G/MIN			
120th St./Emma	+	1.02 FC	6.6 FC	0.0 FC	NA	NA			
St Caterbury Ave	+	1.03 FC	4.9 FC	0.1 FC	49:1	10:1			
Large Park	+	2.00 FC	5.3 FC	0.0 FC	NA	NA			
Walkway Large Parking	+	1.66 FC	6.9 FC	0.1 FC	69:1	10:1			
Small Park	+	2.00 FC	5.8 FC	0.2 FC	29:1	10:1			
Walkway Small Parking	+	1.98 FC	5.4 FC	0.5 FC	11:1	4:1			
Wiltoughby Drive	+	1.53 FC	3.8 FC	0.2 FC	19:1	8:1			



WILLOUGHBY CORNER SITE PLAN - PHASE 1


LOTS 160, 161, 164, 165, 166 & 167, & OUTLOTS F, I, J & K OF THE WILLOUGHBY CORNER SUBDIVISION, CITY OF LAFAYETTE, COUNTY OF BOULDER, STATE OF COLORADO

> POLE BASE DETAIL SCALE: NOT TO SCALE

WILLOUGHBY CORNER PHOTOMETRICS (CAR PORT/CANOPY ALTERNATE)



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ORNER \mathbf{m}

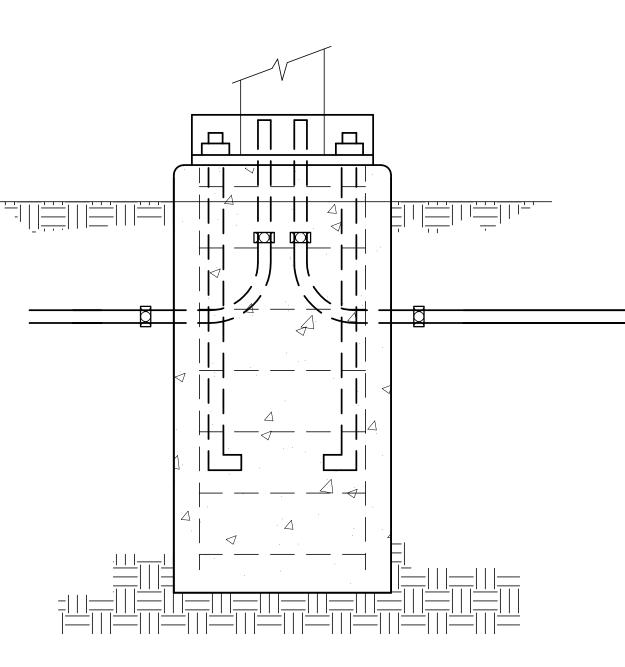OWNER: BOULDER COUNTY HOUSING AUTHORITY 3400 BROADWAY BOULDER, CO - 80304 303.441.3861

CONTACT: MOLLY CHIANG

DATE: <u>06.17.22 - SITE PLAN 01</u>

SHEET TITLE: SITE PHOTOMETRICS (CANOPY ALTERNATE)



ODEN ROADWAY LED Specifications



Project Name Catalog Number:

With six interchangeable caps and spun shade styles, the Oden - LED Roadway offers architects, designers and engineers endless possibilities for a custom fixture to fit their unique application.

The Oden - LED Roadway Array's high-quality, durable construct tion makes it an ideal fixture for any application.

Ordering Information

MODEL	OPTICS	LEDs	CURRENT	KELVIN	VOLTAGE		INISH CAP	SHADE OP	TIONS
ODN-1-L	T1 Type 1	16LC	3 350mA	3K 3000K	UNV *120-277V	MAP-01 Mast Arm Fitter *Designed to slip over 2-3/8" O.D.	BZ Bronze	C1 C2	PC-120 Button Type Photocell PC-208 Button Type Photocell
	T2 Type 2 T3	32LC 48LC	5 530mA 7	4K 4000K 5K	8 347∨ 5	MAP-02 Mast Arm Fitter	BK Black SBK	C3	PC-240 Button Type Photocell PC-277 Button Type Photocell PCR-120 Button Type Photocell
ODN-2-L	Type 3 T4 Type 4	48LC	_ 700mA	5000K	48 0 ∨	*Designed to slip over 2-3/8" O.D. mast arm. Includes provision only for twist lock	Smooth Black	C4 C5	PCR-208 Button Type Photocell PCR-240 Button Type Photocell
	T5 Type 5	64LC 80LC				receptacle Receptacle and shorting cap, to be ordered separately under	White SWH Smooth	C6	PCR-277 Button Type Photocell PCR-480 Button Type Photocell - PER 3 Pin Photo Receptacle
ODN-3-L	T5W Type 5 Wide	96LC 96LC	-			options. YM Yoke Mount *Slips over 3"ØD	White GP Graphite	H1 H2	w/shorting cap 5 Pin Photo Receptacle W/shorting cap Requires Dimming Driver
		128LC				tenon × 4" tall with special threaded mounting plate.	Grey Grey	H3 H4	7 PINPER 7 Pin Photo Receptacle W/shorting cap Requires Dimming Driver WSC-8 Motion Sensor 8' Mounting Height
						AM Arm Mount Size 1	SL Silver Metallic	H5 H6	WSC-20 Motion Sensor 9-20 Mounting Height WSC-40 Motion Sensor 21-40 Mounting Height This option will require (1) FSR 100 remote for programing
						Arm Mount Large Size 2 & 3 See decorative arm	Custom Color	ΠŪ	DIM 0-10v Dimming Driver
						section for arm & wall mount options.			VWC Visionaire Wireless Controis *Consult Factory IR-R Illuminated Rings Red
									IR-B Illuminated Rings Blue IR-G Illuminated Rings Green CLS Cutoff Louver Shield

Ordering Information



TYPE A1/A2/A3/A4 SCALE: NONE



408

VISIONAIRE LIGHTING

WHW JV CHECKED BY: DRAWN BY:

WILLOUGHBY CORNER SITE PLAN - PHASE 1

LOTS 160, 161, 164, 165, 166 & 167, & OUTLOTS F, I, J & K OF THE WILLOUGHBY CORNER SUBDIVISION, CITY OF LAFAYETTE, COUNTY OF BOULDER, STATE OF COLORADO

RLX-1 LED Specifications

Project Name:			
Catalog Number:			
Туре:			
the next generatio	n of LED green technolc	"Cobrahead" luminaire o ogy with energy savings op life well beyond 10 ye	of up to fifty per
		aluminum with integral h ment solution for long lif	
diameter mast arm		l with four bolt mounting erminal block for easy po	

universal bubble level for ease of leveling A 10 kV surge protector is supplied as standard. Maintenance, when required, is tool-less; with stainless steel pinch latches; accessing a removable power tray door holding the LED driver. LEDs and driver compartment are both IP65 rated. Choose from 32 to 80 LEDs with multiple drive currents of 350, 530, 700 1000 mA; 3000, 4000 or 5000 Kelvin, and seven (7) optical distribution patterns for complete design flexibility for street and roadway lighting. Consider the RLX-1 series, the new standard for roadway and street lighting, bringing LED technology with long life and low maintenance to your world.



Interactive Menu

Quick Facts


Dimensional Details



Product Certifications



Connected Systems

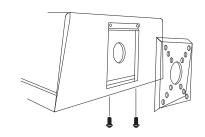



SCALE: NONE

PS500049EN page 1 November 30, 2021 10:39 AM



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