AND MATERIALS OF THE BUILDINGS.

MID-SIZE APARTMENT FLATS IN LAND USE AREA 'D' ARE LIMITED TO TWO STORIES IN HEIGHT WITH WALK-UP UNITS ON THE GROUND FLOOR AND PARKING UNDERNEATH A SECOND STORY OF UNITS. THE LARGEST APARTMENT BUILDINGS ARE LOCATED ALONG THE SOUTH EDGE OF THE SITE IN LAND USE AREAS 'E' AND 'F', AND ARE THREE STORIES IN HEIGHT. IN LAND USE AREA 'C' IN THE CENTER OF WILLOUGHBY CORNER, THE COMMUNITY BUILDING PROVIDES ADMINISTRATIVE OFFICES AND COMMUNAL GATHERING SPACE ADJACENT TO A VARIETY OF OUTDOOR AMENITIES AND THE MAIN BUS STOP.

TO BETTER ENGAGE THE NEIGHBORHOOD AND CREATE A LIVABLE, CONNECTED COMMUNITY, EACH OF THE BUILDING TYPOLOGIES FEATURES PORCHES, PATIOS, AND/OR BALCONIES, THE MID-SIZE APARTMENT FLATS FEATURE PARTIALLY COVERED PATIOS AS A SECONDARY ENTRANCE TO EACH GROUND FLOOR UNIT, AND SECOND LEVEL BALCONIES FOR THE UPPER UNITS. THE LARGE APARTMENT **BUILDINGS SIMILARLY INCLUDE PATIOS WITH PARTIALLY COVERED** SECONDARY ENTRANCES TO THE GROUND FLOOR UNITS. THE UPPER-LEVEL APARTMENTS FEATURE LARGE PICTURE WINDOWS TO BRING IN AIR AND LIGHT TO THE UNITS WITHOUT DIRECT ACCESS TO THE GROUND FLOOR

THE ARCHITECTURAL FEATURES ARE DIVERSE AND ECLECTIC WITH A CREATIVE USE OF COMMON ELEMENTS. PREDOMINANT ROOF FORMS FEATURE PITCHED ROOFS THROUGHOUT THE SITE, WITH A VARIETY OF SLOPES OFFERING DISTINCTIONS BETWEEN DIFFERENT BUILDING TYPES LARGE ROOF AREAS ARE BROKEN UP INTO SMALLER FORMS TO REDUCE THE OVERALL MASS OF THE BUILDINGS. THE APARTMENT BUILDINGS CONTAIN FLAT ROOF AREAS TO ACCOMMODATE MECHANICAL **EQUIPMENT AND PHOTOVOLTAIC SYSTEMS, WITH PITCHED ROOFS** FACING THE STREETS AND COMMUNITY SPACES. THE PRIMARY ROOFING MATERIALS ARE SHINGLES WITH METAL ROOF ACCENTS AND MEMBRANE **ROOFING AT FLAT AREAS.**

EXTERIOR BUILDING MATERIALS ARE PRIMARILY FIBER CEMENT SIDING IN KEEPING WITH THE RESIDENTIAL CHARACTER OF THE OVERALL NEIGHBORHOOD. A MIX OF HORIZONTAL LAP SIDING, VERTICAL BOARD-AND-BATTEN SIDING, PANEL SIDING, AND OTHER ACCENT SIDING MATERIALS AND TRIM PROVIDE VARIETY TO THE BUILDING TYPES. THE MID-SIZE APARTMENT FLATS INCLUDE COLOR ACCENTS AT THE PRIMARY ENTRANCES FOR WAYFINDING. THE LARGER APARTMENT BUILDINGS FEATURE BRICK MASONRY IN EARTHY COLORS TO FORM A SOLID, DURABLE BASE. RESIDENTIAL WINDOWS WILL BE VINYL OR FIBERGLASS AND COMMON AREA WINDOWS WILL BE OF ALUMINUM STOREFRONT, WITH ENERGY-EFFICIENT DETAILING. IN ADDITION TO THEIR AESTHETIC QUALITIES, THE EXTERIOR MATERIALS ARE SELECTED FOR DURABILITY AND FIRE-RESISTANT PROPERTIES.

WILLOUGHBY CORNER SITE PLAN - PHASE 1

LOTS 161, 164, 165, 166 & 167, & OUTLOTS F, I, J, K, L & N OF THE WILLOUGHBY CORNER SUBDIVISION, CITY OF LAFAYETTE, COUNTY OF BOULDER, STATE OF COLORADO

E GENESSE ST

E CHESTER ST

E SPAULDING ST

[UNINCORPORATED]

E EMMA STREET

[R4-PUD]

PHASE

ARTHUR ST

[M1-PUD]

[M1-PUD]

PEAK TO PEAK CHARTER SCHOOL

SOUTH BOULDER

VICINITY MAP

SCALE: 1"=500'

LANCELOT ST

PROJECT SUMMARY:

THE PHASE 1 SITE PLAN FOR WILLOUGHBY CORNER INCLUDES 192 PERMANETLY AFFORDABLE APARTMENTS, INCLUDING 63 **UNITS AGE-RESTRICTED FOR RESIDENTS 55+, SURFACE AND** TUCK-UNDER PARKING, A 4,300 SF COMMUNITY BUILDING, PARK, GARDEN AND RECREATION AREAS, THIS SITE PLAN INCLUDES AN RTD TRANSIT STOP ON CANTERBURY DR. AND OTHER MOBILITY INFRASTRUCTURE AMENITIES.

AFFORDABLE HOUSING:

RESIDENTIAL UNITS SHOWN ON THIS SITE PLAN MEET THE AFFORDABLE HOUSING COVENANT INCLUDING: 63 UNITS ON LOT 165 (AREA E); 60 UNITS ON LOT 166 (AREA F); 51 UNITS ON LOT 167 (AREA F); 18 UNITS ON LOT 164

ZONING:

EXISTING ZONING:

R-4 (RESIDENTIAL HIGH-DENSITY/WILLOUGHBY CORNER PUD)

CODE MODIFICATIONS:

CODE MODIFICATIONS APPLICABLE TO THIS SITE PLAN ARE BASED ON THOSE APPROVED WITH THE FINAL PUD AND ALSO **INCLUDES:**

- 1. PARKING STALL LENGTHS REDUCED FROM 19' TO 18'.
- 2. STREET TREES MAY BE PLANTED AT DISTANCES VARYING FROM THE REQUIRED 40' SPACING.
- 3. LOT 164 MAY HAVE MAY HAVE MULTIPLE PRINCIPAL BUILDINGS.
- 4. THE MINIMUM REQUIRED LANDSCAPING ON LOTS 159 AND LOT 161 MAY BE LESS THAN 15% AND IF THE LOT COVERAGE ON EITHER LOT IS OVER 80%; THE REQUIRED NUMBER OF TREES (1/1000 SF OF LANDSCAPED AREA) MAY BE REDUCED TO 0 IF ALLOWABLE LOT COVERAGE RESULTS IN UNSUITABLE **CONDITIONS FOR HEALTHY TREE GROWTH OR PRESERVATION** OF SIGHT TRIANGLES.
- 5. LOTS IN PLANNING AREA C WITH OVER 80% LOT COVERAGE WILL HAVE REDUCED MINIMUM LANDSCAPE COVERAGE AND REDUCED NUMBER OF REQUIRED TREES AND SHRUBS.

PHASE 1 SITE PLAN PARKING TABLE											
			REQU	IRED E	BY PUD	TOTAL REQUIRED	TOTAL PROPOSED	# ADA PARKING SPACES	# EV READY SPACES	# EV CAPABLE SPACES	# BICYCLE SPACES
PLANNINGAREA	TRACT/LOT	USE	1 BRs	2 BRs	3 BRs						
	OUTLOT K	PARK	0	0	0	0	0	0	0	0	6
	OUTLOT I	PARK	0	0	0	0	0	0	0	0	10
	OUTLOT J	STORMWATER POND	0	0	0	0	0	0	0	0	6
D	F & 164	MULTI-FAMILY	1.0	1.5	1.75	30	27	1	2 + 1 ADA	6	0
F	166 & 167	MULTI-FAMILY	1.0	1.5	1.75	123	59	3	4 + 2 ADA	12	6 + 23 (INTERIOR)
E	165	SENIOR HOUSING	0.75	1.25		54	97	4	9 + 1 ADA	20	4
С	N & 161	COMMUNITY CENTER		1/770 SF		6	34	3	3 + 1 ADA	7	6
		TOTAL:				213	217	11	18 + 5 ADA	45	61

PHASE 1 SITE DA	ATA TABLE		
COMPREHENSIVE PLAN LAND USE	HOUSING AREA		

* PER THE WILLOUGHBY CORNER PUD, SHARED PARKING IS ALLOWED ACROSS PARCELS WITHIN THE PUD.

BUILDING

4,495 (52.2%)

8,228 (33.6%)

SOFTSCAPE

(SF +%)

2,664 (31.0%)

7,912 (32.3%)

18,558 (22.7%)

20,078 (38.8%) 10,8592 (21.0%) 20,851 (40.2%)

17,730 (43.1%) 11,458 (27.9%)

HARDSCAPE

1,446 (16.8%)

8,373 (34.1%)

11,952 (29.0%)

LOT COVERAGE

MAXIMUM PROPOSED

38.8

COMPREHENSIVE PLAN LAND USE	HOUSING AREA
ZONING	R4-HIGH DENSITY RESIDENTIAL
TOTAL PHASE 1 SITE AREA*	17.95 ACRES
TOTAL ROW	8.22 ACRES
TOTAL LANDSCAPE / PARK AREAS IN OUTLOTS I, J, K & N	3.60 ACRES

AREA RESIDENTIAL

UNITS

18

IN OUTLOTS I, J, K & N	3.0
INCLUDES AREA OF PHASE 1 OFFSITE IMPRO	OVEMENTS.

161 COMMUNITY

166 MULTI-FAMILY

167 MULTI-FAMILY

* CODE MODIFICATION AS PER APPROVED PUD *+++EXCEPT THE SIDES FACING WILLOUGHBY ST.

+++++ FRONT PORCHES MAY ENCROACH 5 FT. INTO REQUIRED SETBACK.

BUILDING DATA TABLE								
LOT		NO. OF VISITABLE	NO. OF BEDROOMS					
LOT	BUILDING	UNITS	1 BRs	2 BRs	3 BRs	TOTAL		
161	COMMUNITY BUILDING 1	0	0	0	0	0		
164	FLAT BUILDING 1	3	0	3	6	9		
164	FLAT BUILDING 2	3	0	3	6	9		
165	SENIOR BUILDING 1	63	50	13	0	63		
166	MULTI-FAMILY BUILDING 1	60	47	13	0	60		
167	MULTI-FAMILY BUILDING 2	51	40	11	0	51		

HEIGHT

26

44

44

NO. OF FLOORS

3 3

BUILDING

SEPARATION

www.hbaa.com						
Contact: Tino Leone, Principal & Architect						
CIVIL-SURVEY:						
DREXEL, BARRELL & CO.						
1376 Miners Dr., Suite 107, Lafayette, CO 80026						
Phone: (303) 442-4338						
www.drexelbarrell.com						
Contact Civil: Cameron Knapp,P.E.						
Contact Survey: Mathew Selders, P.L.S.						
•						

DEVELOPMENT TEAM:

3400 Broadway, Boulder, CO 80304

Phone: (303) 441-3861

Phone: (719) 473-7063

ARCHITECTURE:

BOULDER COUNTY HOUSING AUTHORITY

Contact: Molly Chiang, Senior Developer

102 E. Moreno Avenue, Colrado Springs, CO 80903

REAR SETBACK

85

REQUIRED

0*/6' FROM ALLEY FOR NORTH

BUILDING/10' FROM

CANTERBURY FOR SOUTH BUILDING

10*

OWNER:

FRONT SETBACK

REQUIRED

(FRONTS OF

BUILDINGS FAC

PARKING LOT)

15++++

15

<u>PLAN</u>	NER-LANDSCAPE:
NORF	RIS DESIGN
1101 I	Bannock Street, Denver, CO 80204
Phone	e: (303) 892-1166
www.	norris-design.com
Conta	ct: Kristin Dean, Senior Associate

Contact: Will Mettling

TRAFFIC ENGINEER:
KIMLEY HORN
4582 S. Ulster Street, Suite 1500, Denver, CO 80237
Phone: (303) 228-2329
Contact: Chris Hopkins, P.E.

PHOTOMETRIC/LIGHTING:
FARNSWORTH GROUP
5613 Dtc Prky, Suite 1100, Greenwood Village, CO 80111
Phone: (303) 692-8838

[UNINCORPORATED]

FLAGG DR

[UNINCORPORATED]

[UNINCORPORATED]

[UNINCORPORATED]

		SIDE SETBACK (FEET)		SETBACK FROM CANTERBURY		SETBACK FROM WILLOUGHBY	
D	REQUIRED	PROPOSED	REQUIRED	PROPOSED	REQUIRED	PROPOSED	
	0*+++	0	10*	10	10*	10	
	2*+++	10	10*	10	10*	10	
	20	30	15++++	15	N/A	N/A	
	20	20	15+++++	15	N/A	N/A	

Sheet Number	Sheet Title
1	COVER SHEET
2	GENERAL NOTES
3	OVERALL SITE
4-12	SITE PLANS
13-16	GRADING PLANS
17-26	UTILITY PLANS
27	LANDSCAPE NOTES
28-29	LANDSCAPE PLANT SCHEDULE
30	LANDSCAPE AMENITY/MATERIAL SCHEDULE
31	OVERALL LANDSCAPE PLAN
32-35	LANDSCAPE PLANS
36-38	LANDSCAPE ENLARGEMENT
39-40	LANDSCAPE DETAILS
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42	IRRIGATION SCHEDULE
43	OVERALL IRRIGATION PLAN
44-47	IRRIGATION PLANS
48-50	IRRIGATION DETAILS
51-53	SENIOR BUILDING ELEVATIONS
54-55	MULTI-FAMILY 1 BUILDING ELEVATIONS
56-57	MULTI-FAMILY 2 BUILDING ELEVATIONS
58	COMMUNITY BUILDING 1 ELEVATIONS
59	FLATS BUILDING 1 ELEVATIONS
60	FLATS BUILDING 2 ELEVATIONS
61-62	MISCELLANEOUS STRUCTURE ELEVATIONS
63	SITE PHOTOMETRICS
64	SITE PHOTOMETRICS (CANOPY ALT)
65	PHOTOMETRIC DETAILS

SHEET INDEX TABLE

LEGAL DESCRIPTION:

A TRACT OF LAND LOCATED IN THE SE1/4 OF SECTION 2, T1S, R69W OF THE 6TH P.M., CITY OF LAFAYETTE, COUNTY OF BOULDER, STATE OF **COLORADO. BEING MORE PARTICULARLY DESCRIBED AS FOLLOWS:**

LOTS 161, 164, 165, 166 & 167, & OUTLOTS F. I, J, K, L, N OF THE WILLOUGHBY CORNER SUBDIVISION, CITY OF LAFAYETTE, COUNTY OF **BOULDER, STATE OF COLORADO**

TOTAL WATER REQUIRED								
	UNITS	ACRE-FEET /UNIT	_	TOTAL CBT (.7 /ACRE-FEET)				
COMMUNITY BLDG (ACRES)	0.1	8.3	0.83	1.185714				
MULTIFAMILY NO IRRIGATION (DWELLING UNITS)	400	0.25	100	142.8571				
NONRESIDENTIAL AREAS (ACRES-FT)			8.76	12.51429				

WATER REQUIRED BY PHASE				
	DWELLING UNITS	ACRE-FEET /UNIT	ACRE-FEET	TOTAL CBT (.7 /ACRE-FEET
PHASE 1 DWELLING UNITS	192	0.25	48	68.57143
PHASE 1 COMMUNITY BLDG.	1	0.83	0.83	1.185714
PHASE 1 LANDSCAPING	1	5.5	5.5	7.857143
PHASE 1 TOTAL WATER REQUIRED			54.33	77.61429
PHASE 2 DWELLING UNITS	128	0.25	32	
PHASE 2 LANDSCAPING	1	3.3	3.3	
PHASE 3 DWELLING UNITS (FOR SALE)	80	0.25	20	
TOTAL PHASE 2 & 3 WATER REQUIRED			55.3	
TOTAL				

WATER REQUIRED BY RESIDENTIAL BLDG.				
PHASE 1 DWELLING UNITS	DWELLING UNITS	ACRE-FEET /UNIT	ACRE-FEET	TOTAL CBT (.7 /ACRE-FEET
SENIOR BUILDING	63	0.25	15.75	22.5
MULTI-FAMILY 1	60	0.25	15	21.42857
MULTI-FAMILY 2	51	0.25	12.75	18.21429
9-PLEX FLATS	18	0.25	4.5	6.428571
PHASE 1 SUBTOTAL	192		48	68.57143

APPROVED:

CITY ENGINEER

REVIEW IS FOR GENERAL CONFORMANCE WITH THE CITY OF LAFAYETTE "STANDARDS AND SPECIFICATIONS," LATEST EDITION. SOLE RESPONSIBILITY FOR COMPLETENESS AND/OR ACCURACY OF THESE DOCUMENTS SHALL REMAIN WITH THE REGISTERED PROFESSIONAL ENGINEER SEALING THESE PLANS. THE CITY DOES NOT ACCEPT LIABILITY FOR FACILITIES DESIGNED BY OTHERS.

COVER SHEET & INDEX

SHEET TITLE:

ソソソノ

1101 Bannock Street

P 303.892.1166

Denver, Colorado 80204

www.norris-design.com

OWNER:

BOULDER COUNTY HOUSING

AUTHORITY

3400 BROADWAY

BOULDER, CO - 80304

303.441.3861

CONTACT: MOLLY CHIANG

DATE:

<u>06.17.22 - SITE PLAN 01</u> <u>09.15.22 - SITE PLAN 02</u>

NORRIS DESIGN

LOTS 161, 164, 165, 166 & 167, & OUTLOTS F, I, J, K, L & N OF THE WILLOUGHBY CORNER SUBDIVISION, CITY OF LAFAYETTE, COUNTY OF BOULDER, STATE OF COLORADO

NORRIS DESIGN

1101 Bannock Street
Denver, Colorado 80204
P 303.892.1166
www.norris-design.com

1BY CORNER

WILLOUGHB
SITE PLAN- PHASE 1
LAFAYETTE, COLORADO

OWNER:
BOULDER COUNTY HOUSING
AUTHORITY
3400 BROADWAY
BOULDER, CO - 80304
303.441.3861

CONTACT: MOLLY CHIANG

DATE:

06.17.22 - SITE PLAN 01 09.15.22 - SITE PLAN 02

SHEET TITLE: NOTES SHEET

GENERAL NOTES

- 1. ALL CONSTRUCTION IN THE PUBLIC RIGHT-OF-WAY, OR PUBLIC EASEMENTS SHALL CONFORM TO THE CITY OF LAFAYETTE STANDARDS AND SPECIFICATIONS.
- 2. SIGNS AND MARKINGS INSTALLED IN THE RIGHT-OF-WAY TO COMPLY WITH THE MANUAL OF UNIFORM TRAFFIC CONTROL DEVICES. LATEST REVISION EDITION.
- 3. THE LOCATION OF EXISTING UNDERGROUND UTILITIES ARE SHOWN IN AN APPROXIMATE WAY ONLY AND HAVE NOT BEEN INDEPENDENTLY VERIFIED BY THE OWNER OR ITS REPRESENTATIVE. THE CONTRACTOR SHALL DETERMINE THE EXACT LOCATION OF ALL EXISTING UTILITIES, WHETHER SHOWN ON THESE PLANS OR NOT, BEFORE COMMENCING WORK, AND AGREES TO BE FULLY RESPONSIBLE FOR ANY AND ALL DAMAGES WHICH MIGHT BE OCCASIONED BY THE CONTRACTOR'S FAILURE TO EXACTLY LOCATE AND PRESERVE ANY AND ALL UTILITIES.
- 4. ALL DAMAGED EXISTING CURB, GUTTER, AND SIDEWALK MUST BE BROUGHT TO CURRENT CITY STANDARDS PRIOR TO INITIAL ACCEPTANCE.
- 5. PRIOR TO ANY CONSTRUCTION WITHIN THE PUBLIC RIGHT-OF-WAY, THE CONTRACTOR SHALL ACQUIRE ANY NECESSARY PERMITS FROM THE DEPARTMENT OF PUBLIC WORKS AS REQUIRED BY ORDINANCE.
- 6. CONTRACTOR SHALL CONTACT ALL APPROPRIATE UTILITY COMPANIES AND THE CITY OF LAFAYETTE TO OBTAIN ALL NECESSARY LOCATES 48 HOURS BEFORE CONSTRUCTION BEGINS.
- 7. NO VARIANCE FROM THE SPECIFICATIONS AND NOTES HEREIN SHALL BE ACCEPTED WITHOUT PRIOR WRITTEN APPROVAL BY THE CITY OF LAFAYETTE.
- 8. ALL PHASES OF THE WORK SHALL BE INSPECTED AND APPROVED BY THE CITY OF LAFAYETTE.

DEMOLITION NOTES

- 1. THE CONTRACTOR SHALL DOCUMENT THE CONDITION OF ALL EXISTING FEATURES TO REMAIN PRIOR TO THE BEGINNING OF WORK. ALL ITEMS DAMAGED OR DISTURBED SHALL BE REPAIRED OR REPLACED IN KIND TO THE SATISFACTION OF THE OWNER AT NO ADDITIONAL CONTRACT COST.
- 2. DRAINAGE STRUCTURES SHALL NOT BE REMOVED UNTIL SATISFACTORY ARRANGEMENTS HAVE BEEN MADE TO ACCOMMODATE TRAFFIC AND DRAINAGE.
- 3. WHERE PORTIONS OF IMPROVEMENTS ARE TO BE REMOVED, THE PORTIONS DESIGNATED TO REMAIN SHALL BE PROTECTED FROM DAMAGE. ALL DAMAGE TO STRUCTURES DESIGNATED TO REMAIN IN PLACE SHALL BE REPAIRED AT THE CONTRACTOR'S EXPENSE.
- 4. EXISTING IMPROVEMENTS, SUCH AS PAVEMENT, SIDEWALKS, CURBS, THE CONTRACTOR SHALL SAW CUT AT LIMITS OF REMOVAL TO A TRUE LINE, WITH A VERTICAL FACE AND TO A MINIMUM DEPTH OF 2-INCHES OR TO THE DEPTH OF THE REINFORCING STEEL, WHICHEVER OCCURS FIRST. IF THE EDGE IS DAMAGED DURING CONSTRUCTION, IT SHALL BE RE-CUT PRIOR TO CONSTRUCTING THE NEW IMPROVEMENTS.
- 5. SAW CUTS MAY DEVIATE SLIGHTLY FROM THE DESIGN IF A CONTROL JOINT IS WITHIN A REASONABLE DISTANCE FROM THE SAW CUT AS SHOWN ON THIS PLAN. COSTS ASSOCIATED WITH THE REMOVAL AND REPLACEMENT OF ANY ADDITIONAL CURB, GUTTER, OR SIDEWALK THAT IS REQUIRED DUE TO DEVIATIONS IN THE SAW CUT LOCATION WILL BE THE RESPONSIBILITY OF THE CONTRACTOR.
- 5. COORDINATE ANY SHUTDOWN OF EXISTING UTILITIES WITH UTILITY OWNERS PRIOR TO PROCEEDING WITH THE WORK.
- 6. CONTRACTOR SHALL INSTALL EROSION AND SEDIMENT CONTROL MEASURES PRIOR TO SITE CLEARING OR DEMOLITION ACTIVITIES.
- 7. ABANDONMENT PROCEDURES SHALL CONFORM TO SECTION 1000, CITY OF LAFAYETTE STANDARDS & SPECIFICATIONS. LATEST VERSION.

ADJACENT PROPERTY - COORDINATION AND RESTORATION

- 1. THE PROPOSED CONSTRUCTION INCLUDES WORK OFF SITE AND IN PROPRIETIES OWNED BY PRIVATE PROPERTY OWNERS (WITHIN EASEMENTS) AND THE CITY. THE WORK IS WITHIN EASEMENTS DEDICATED FOR THE PROPOSED USE.
- 2. IF WORKING IN LANDS OWNED BY THE CITY, THE CONTRACTOR SHALL WORK UNDER THE REQUIREMENTS OF THE PERMIT FROM THE CITY.
- 3. IF WORKING IN LANDS OWNED BY PRIVATE PROPERTY OWNERS, THE CONTRACTOR SHALL NOTIFY SAID OWNER OF UPCOMING WORK AND ALLOW SAID OWNER A MINIMUM OF TWO WEEKS TO REMOVE ANY ITEMS WITHIN THE EASEMENT WHICH MAY IMPEDE CONSTRUCTION. THE CONTRACTOR SHALL PROVIDED ANY AND ALL MEANS NECESSARY TO MAINTAIN ANY FENCES OR ENCLOSURES FOR PROTECTION AND SECURITY OF THE PRIVATE HOMEOWNER. THE CONTRACTOR SHALL RESTORE THE AREA TO MATCH EXISTING CONDITIONS, OR BETTER, AND SHALL OBTAIN WRITTEN APPROVAL SIGN OFF FROM THE OWNER UPON COMPLETION.
- 4. THE CONTRACTOR SHALL PREPARE A TRAFFIC CONTROL PLAN FOR ANY ROAD CLOSURES.

UTILITY NOTES

- 1. ALL WATER AND SANITARY SEWER MATERIALS AND CONSTRUCTION SHALL CONFORM TO CITY OF LAFAYETTE STANDARDS AND SPECIFICATIONS, LATEST EDITION THEREOF.
- 2. WATER SERVICE LINE TAPS SHALL BE WET TAPS INSTALLED BY A CONTRACTOR OR PLUMBER LICENSED BY THE CITY WHO SPECIALIZES IN THE INSTALLATION OF WATER TAPS.
- 3. CONTRACTOR SHALL PROTECT ALL ADJACENT IMPROVEMENTS (BUILDINGS, PARKING LOTS, LANDSCAPE AREAS, ETC...) FROM DAMAGE AND EROSION. ALL DISTURBED AREAS OFF—SITE SHALL BE RESTORED TO A MINIMUM OF THEIR ORIGINAL CONDITION AT THE CONTRACTOR'S EXPENSE.
- 4. THE CONTRACTOR SHALL OBTAIN ALL NECESSARY PERMITS TO COMPLETE THE PROPOSED WORK AND SHALL COMPLY WITH ALL LOCAL, STATE AND FEDERAL REGULATIONS.
- 5. PAVING CONTRACTOR SHALL ADJUST ALL VALVE BOXES AND MANHOLE COVERS TO FINAL GRADE.
- 6. ALL EXISTING UTILITY LINE LOCATIONS SHALL BE VERIFIED BY THE CONTRACTOR AND THE ENGINEER NOTIFIED PRIOR TO CONSTRUCTION. IT IS THE PLANS' INTENT TO SHOW ALL EXISTING UTILITIES, HOWEVER IT SHALL BE THE CONTRACTOR'S RESPONSIBILITY TO VERIFY THAT ALL EXISTING UTILITIES, WHETHER SHOWN ON THESE PLANS OR NOT, HAVE BEEN PROPERLY LOCATED.
- 7. PROVIDE CONCRETE THRUST BLOCKING AT ALL BENDS, TEES, PLUGS AND HYDRANTS.
- 8. WATER, STORM SEWER AND SANITARY SEWER PIPE SHALL BE BEDDED IN ACCORDANCE WITH CITY OF LAFAYETTE STANDARDS AND SPECIFICATIONS, LATEST EDITION THEREOF.
- 9. ALL WATER LINES SHALL HAVE A MINIMUM FOUR AND A HALF (4-1/2) FEET OF COVER BELOW FINISHED GRADE
- 10. CONTRACTOR SHALL COORDINATE DRY UTILITY LOCATIONS WITH ARCHITECT AND PROVIDER AGENCY.
- 11. ALL STATIONING AND OFFSETS ARE FROM ROAD CENTERLINE ALIGNMENT TO THE CENTERLINES OF MANHOLES, INLETS AND UTILITY LINES UNLESS NOTED OTHERWISE.
- 12. SANITARY SEWER LINES SHALL BE POLYVINYL CHLORIDE (PVC) PIPE, SDR 35, IN ACCORDANCE WITH OR MEETING ASTM D3034
- 13. SANITARY SEWER MAINS IN "ALLEY" MAY HAVE LESS THAN 9 FEET OF ELEVATION DIFFERENCE BETWEEN FINISHED LOT GRADE AT BUILDING LINE AND THE TOP OF THE SANITARY MAIN. SERVICE LINES SHALL BE INSTALLED WITH A MINIMUM OF 4 FEET OF COVER AND NO LESS THAN 2.0% SLOPE.
- 14. WATER LINES SHALL BE A.W.W.A. C-900 CLASS 200 PVC PRESSURE PIPE. ALL WATER SERVICES WITH PIPE DIAMETERS THROUGH 2 INCHES SHALL BE TYPE K COPPER IN ACCORDANCE WITH ASTM B88. ALL WATER SERVICE LINES LARGER THAN 2-INCH ARE TO BE C-900. SEE CITY DETAIL 200-4 FOR LOCATOR TAPE AND TRACER WIRE STANDARDS. ALL HARDWARE SHALL BE STAINLESS STEEL. ALL FIRE LINES ARE TO BE RESTRAINED JOINT.
- 15. WATERLINE FITTINGS SHALL BE DUCTILE—IRON OR CAST—IRON CONFORMING TO THE REQUIREMENTS SET FORTH IN ANSI A21.10, A.W.W.A. C110. CAST—IRON FITTINGS 12—INCH SIZE AND SMALLER SHALL BE CLASS 250. ALL DUCTILE IRON PIPE FITTINGS AND APPURTENANCES WILL BE PROTECTED WITH A 10—MIL THICK POLYETHYLENE FILM WRAP.
- 16. MANHOLES SHALL BE STANDARD PRECAST CONCRETE. SEE CITY STANDARD DETAILS.
- 17. STANDARD FIRE HYDRANT ASSEMBLY SHALL INCLUDE THE SWIVEL TEE, VALVE, 6" PIPE TO THE HYDRANT AND THE HYDRANT.
- 18. STORM SEWER PIPE IN THE ROW SHALL BE REINFORCED CONCRETE PIPE (RCP) IN ACCORDANCE WITH ASTM C-76. PIPE SHALL BE CLASS III.
- 19. ALL STORM SEWER PIPE JOINTS SHALL BE INTEGRAL BELL AND SPIGOT WITH RUBBER O-RING TYPE GASKETS PER ASTM C-361.
- 20. ALL STORM SEWER PIPE FLARED END SECTIONS SHALL BE INSTALLED WITH PREFABRICATED TRASH RACKS APPROPRIATE FOR THE PIPE SIZE AND AS SPECIFIED OR SUPPLIED BY THE MANUFACTURER.
- 21. PIPING FOR UNDERDRAIN SYSTEM AND ROOF DRAINS SHALL BE PVC PIPE, SDR 35, OR APPROVED EQUIVALENT AND SHALL BE A COLOR OF PVC OTHER THAN GREEN OR BLUE.
- 22. PROVIDE APPROPRIATE WARNING TAPE FOR EACH UTILITY.
- 22. AS-BUILT DRAWINGS SHALL BE PROVIDED IN ACCORDANCE WITH SECTION 106.2.2 OF THE CITY OF LAFAYETTE STANDARDS AND SPECIFICATIONS. AS-BUILT INFORMATION MUST INCLUDE ELEVATIONS FOR WATER, SANITARY SEWER, STORM SEWER, AND UNDERDRAIN ELEVATIONS. AS-BUILTS SHALL BE PREPARED BY THE CONTRACTOR AND SUBMITTED TO THE CITY OF LAFAYETTE FOR APPROVAL.

EROSION CONTROL NOTES

- 1. ALL TEMPORARY EROSION CONTROL FACILITIES AND ALL PERMANENT FACILITIES INTENDED TO CONTROL EROSION OF ANY EARTH DISTURBANCE OPERATIONS TAKE PLACE.
- 2. ANY EARTH DISTURBANCE SHALL BE CONDUCTED IN SUCH MANNER SO AS TO EFFECTIVELY REDUCE ACCELERATED SOIL EROSION AND RESULTING SEDIMENTATION AND SHOULD NOT EXCEED THE EROSION EXPECTED TO OCCUR FOR THE SITE IN ITS TOTALLY UNDEVELOPED STATE.
- 3. ALL PERSONS ENGAGED IN EARTH DISTURBANCES SHALL DESIGN, IMPLEMENT AND MAINTAIN ACCEPTABLE SOIL EROSION AND SEDIMENTATION CONTROL MEASURES, IN CONFORMANCE WITH THE EROSION CONTROL TECHNICAL STANDARDS ADOPTED BY THE CITY.
- 4. ALL EARTH DISTURBANCES SHALL BE DESIGNED, CONSTRUCTED AND COMPLETED IN SUCH A MANNER SO THAT THE EXPOSED AREA OF ANY DISTURBED LAND SHALL BE LIMITED TO THE SHORTEST POSSIBLE PERIOD OF TIME.
- 5. SEDIMENT CAUSED BY ACCELERATED SOIL EROSION SHALL BE REMOVED FROM RUNOFF WATER BEFORE IT LEAVES THE SITE OF THE EARTH DISTURBANCE.
- 6. ANY TEMPORARY OR PERMANENT FACILITY DESIGNED AND CONSTRUCTED FOR THE CONVEYANCE OF WATER AROUND, THROUGH OR FROM THE EARTH DISTURBANCE AREA SHALL BE DESIGNED TO LIMIT THE WATER FLOW TO A NON-EROSIVE VELOCITY.
- 7. TEMPORARY SOIL EROSION CONTROL FACILITIES SHALL BE REMOVED AND EARTH DISTURBANCE AREAS GRADED AND STABILIZED WITH PERMANENT SOIL EROSION CONTROL MEASURES PURSUANT TO THE CITY STANDARDS AND SPECIFICATIONS AND IN ACCORDANCE WITH THE PERMANENT EROSION CONTROL FEATURES SHOWN ON THE GRADING AND EROSION CONTROL PLAN.
- 8. PERMANENT SOIL EROSION CONTROL MEASURES FOR ALL SLOPES, CHANNELS, DITCHES OR ANY DISTURBED LAND AREA SHALL BE COMPLETED WITHIN FOURTEEN (14) CALENDAR DAYS AFTER FINAL GRADING OR THE EARTH DISTURBANCE HAS BEEN COMPLETED. WHEN IT IS NOT POSSIBLE TO PERMANENTLY STABILIZE A DISTURBED AREA AFTER AN EARTH DISTURBANCE HAS BEEN COMPLETED OR WHERE SIGNIFICANT EARTH DISTURBANCE ACTIVITY CEASES, TEMPORARY SOIL EROSION CONTROL MEASURES SHALL BE IMPLEMENTED WITHIN FOURTEEN (14) CALENDAR DAYS. ALL TEMPORARY SOIL EROSION CONTROL MEASURES SHALL BE MAINTAINED UNTIL PERMANENT SOIL EROSION MEASURES ARE IMPLEMENTED.

GRADING NOTES

- 1. ALL SPOT ELEVATIONS ARE FLOWLINE OF CURB AND GUTTER, TOP OF PAVING, OR FINISHED GRADE UNLESS OTHERWISE NOTED.
- 2. ALL PROPOSED CONTOURS ARE TO TOP OF FINISHED PAVING AND LANDSCAPED AREAS UNLESS OTHERWISE NOTED.
- 3. MAXIMUM LANDSCAPE SLOPE SHALL BE 4(HOR) TO 1(VERT) MINIMUM SLOPE ON LANDSCAPED AREAS SHALL BE 2.00% MINIMUM SLOPE ON ASPHALT SURFACES SHALL BE 1.00% MINIMUM SLOPE ON CONCRETE SURFACES SHALL BE 0.50% UNLESS OTHERWISE NOTED.
- 4. REFER TO SOILS REPORT FURNISHED BY OWNER FOR ALL COMPACTION REQUIREMENTS.
- 5. ADD 5100 TO ALL (TRUNCATED) SPOT ELEVATIONS AND CONTOUR ELEVATIONS TO REACH PROJECT VERTICAL DATUM.
- 6. PAVING CONTRACTOR SHALL ADJUST ALL VALVE BOXES AND MANHOLE COVERS TO THE FINAL GRADES INDICATED ON PLANS.
- 7. EXISTING SPOT ELEVATIONS AND TOPOGRAPHIC INFORMATION COMES FROM AN ALTA AND FIELD SURVEY CONDUCTED BY DREXEL, BARRELL & CO. COMPLETED IN JUNE 1, 2017
- 8. CONCRETE WALKS SHALL HAVE A DESIGNED CROSS SLOPE NOT TO EXCEED 2% ONCE CONSTRUCTED PER ADA REQUIREMENTS.
- 9. CONTRACTOR SHALL NOTIFY THE SURVEY AND/OR ENGINEER PRIOR TO CONSTRUCTION OF ALL CURB RAMPS TO VERIFY THAT DESIGN ELEVATIONS AT THE TOP OF THE RAMPS WILL MEET ADA REQUIREMENTS BASED ON CONSTRUCTED FLOWLINE ELEVATIONS.
- 10. IT SHALL BE THE RESPONSIBILITY OF THE CONTRACTOR TO MAINTAIN AND PROVIDE FOR ADEQUATE DRAINAGE THROUGH THE SITE DURING THE PROCESS OF EXCAVATION, GRADING AND EMBANKMENT. THE GRADE SHALL BE MAINTAINED IN SUCH CONDITION THAT IT IS WELL DRAINED AT ALL TIMES.

WILLOUGHBY CORNER SITE PLAN - PHASE 1 LOTS 161, 164, 165, 166 & 167, & OUTLOTS F, I, J, K, L & N OF THE WILLOUGHBY CORNER SUBDIVISION, CITY OF LAFAYETTE, COUNTY OF BOULDER, STATE OF COLORADO 12' LEFT TURN LANE EX. 60' ACCESS & WANEKA PARCEL S89°00'56"E 1003.23' EAST 1 CORNER, SECTION 2, TOWNSHIP 1S, ORIGINAL SCALE: 1"=60' RANGE 69W TURN LANE INDICATES BOUNDARY OF PHASE 1 IMPROVEMENTS **LEGEND** PROPOSED -RIGHT OF WAY AREA A **AREA A** ·L=164.89' N0°59'04"E PROPERTY LINE. ⁻ 250.00' PUBLIC — ART PIECE CH=N4*25'20"W PRE-WIRED EV STALLS. STORMWATER DETENTION LOT 1 COAL PARK SUB. BE DEDICATED OWNER: PRAIRIE VIEW, INC. PROPOSED CONCRETE 4' WIDE CONCRETE TRICKLE MULTI-MODAL RTD BUS STOP LOCATION -SIDEWALK **AREA** 10' WIDE -CONCRETE S89°00'56"E-►EX. EDGE OF ASPHALT JLTI-MODAL SIDEWALK 28.50' PLANNING AREA BOUNDARIES. AREA B **AREA B** BIKE RACKS HANDICAP PARKING SPACE. OUTLOT J N0°00'00"E-ART PIECE ELECTRIC VEHICLE PARKING SPACE. **AREA** LOT 2 COAL PARK SUB. OWNER: PRAIRIE VIEW, INC. PROPOSED L=92.66' -R=200.00'
\(\text{A} = 26'32'47'' \)
CH=\$13'16'24"E STORMWATER DENTENTION CONTACT: MOLLY CHIANG FACILITY FLAGG DR. PUBLIC ART PIECE -L=123.10'
R=100.00'
A=70'31'44"
CH=N8'43'05"E TRAIL OUTLOT I RAISED 12' UTILITY IN CRUSHER FINE AREA AREA C -PROPOSED EDGE OF ASPHALT PROPOSED -ROUND-ABOUT PLAY GROUND AREA D FUTURE RTD
BUS STOP
LOCATION BUS STOP SHELTER — GATHERING SPACE 7 PROPOSED
BIKE RACKS RAISED PLANTERS IN CRUSHER RCHARD/GARDENS "QUTLOT K🐚 🥼 EAST LINE OF SECTION 2, TOWNSHIP 1S, EX. EXIT ONLY DRIVEWAY FROM PEAK TO PEAK EASEMENT OUTDOOR BENCH SEAT RANGE 69W CHARTER SCHOOL-■ PROPOSED -BIKE RACKS CANTERBURY DR. BURLINGTON **NORTHERN** -3/4 MOVEMENT PORKCHOP ISLAND PROPOSED TRASH AREA PUBLIC **ENCLOSURE** ART PIECE -LOT 167 GENERATOR SENIOR BUILDING #1 AREA F MULTI-FAMILY #2 (51 UNITS/3-STORY) (63 UNITS/3-STORY) MULTI-FAMILY #1 (60 UNITS/3-STORY) EX. GRAVEL TRAIL-CONCRETE MULTI-MODAL SIDEWALK — N89°10'00"W 798.18 PLATTNER TRACT

EX. 10' UTILITY EX. 10' ELECTRICITY & NATURAL
EASEMENT GAS EASEMENT & AGREEMENT
(REC. NO. 2255539)

PROPOSED TRASH-ENCLOSURE

-TRACT A-2

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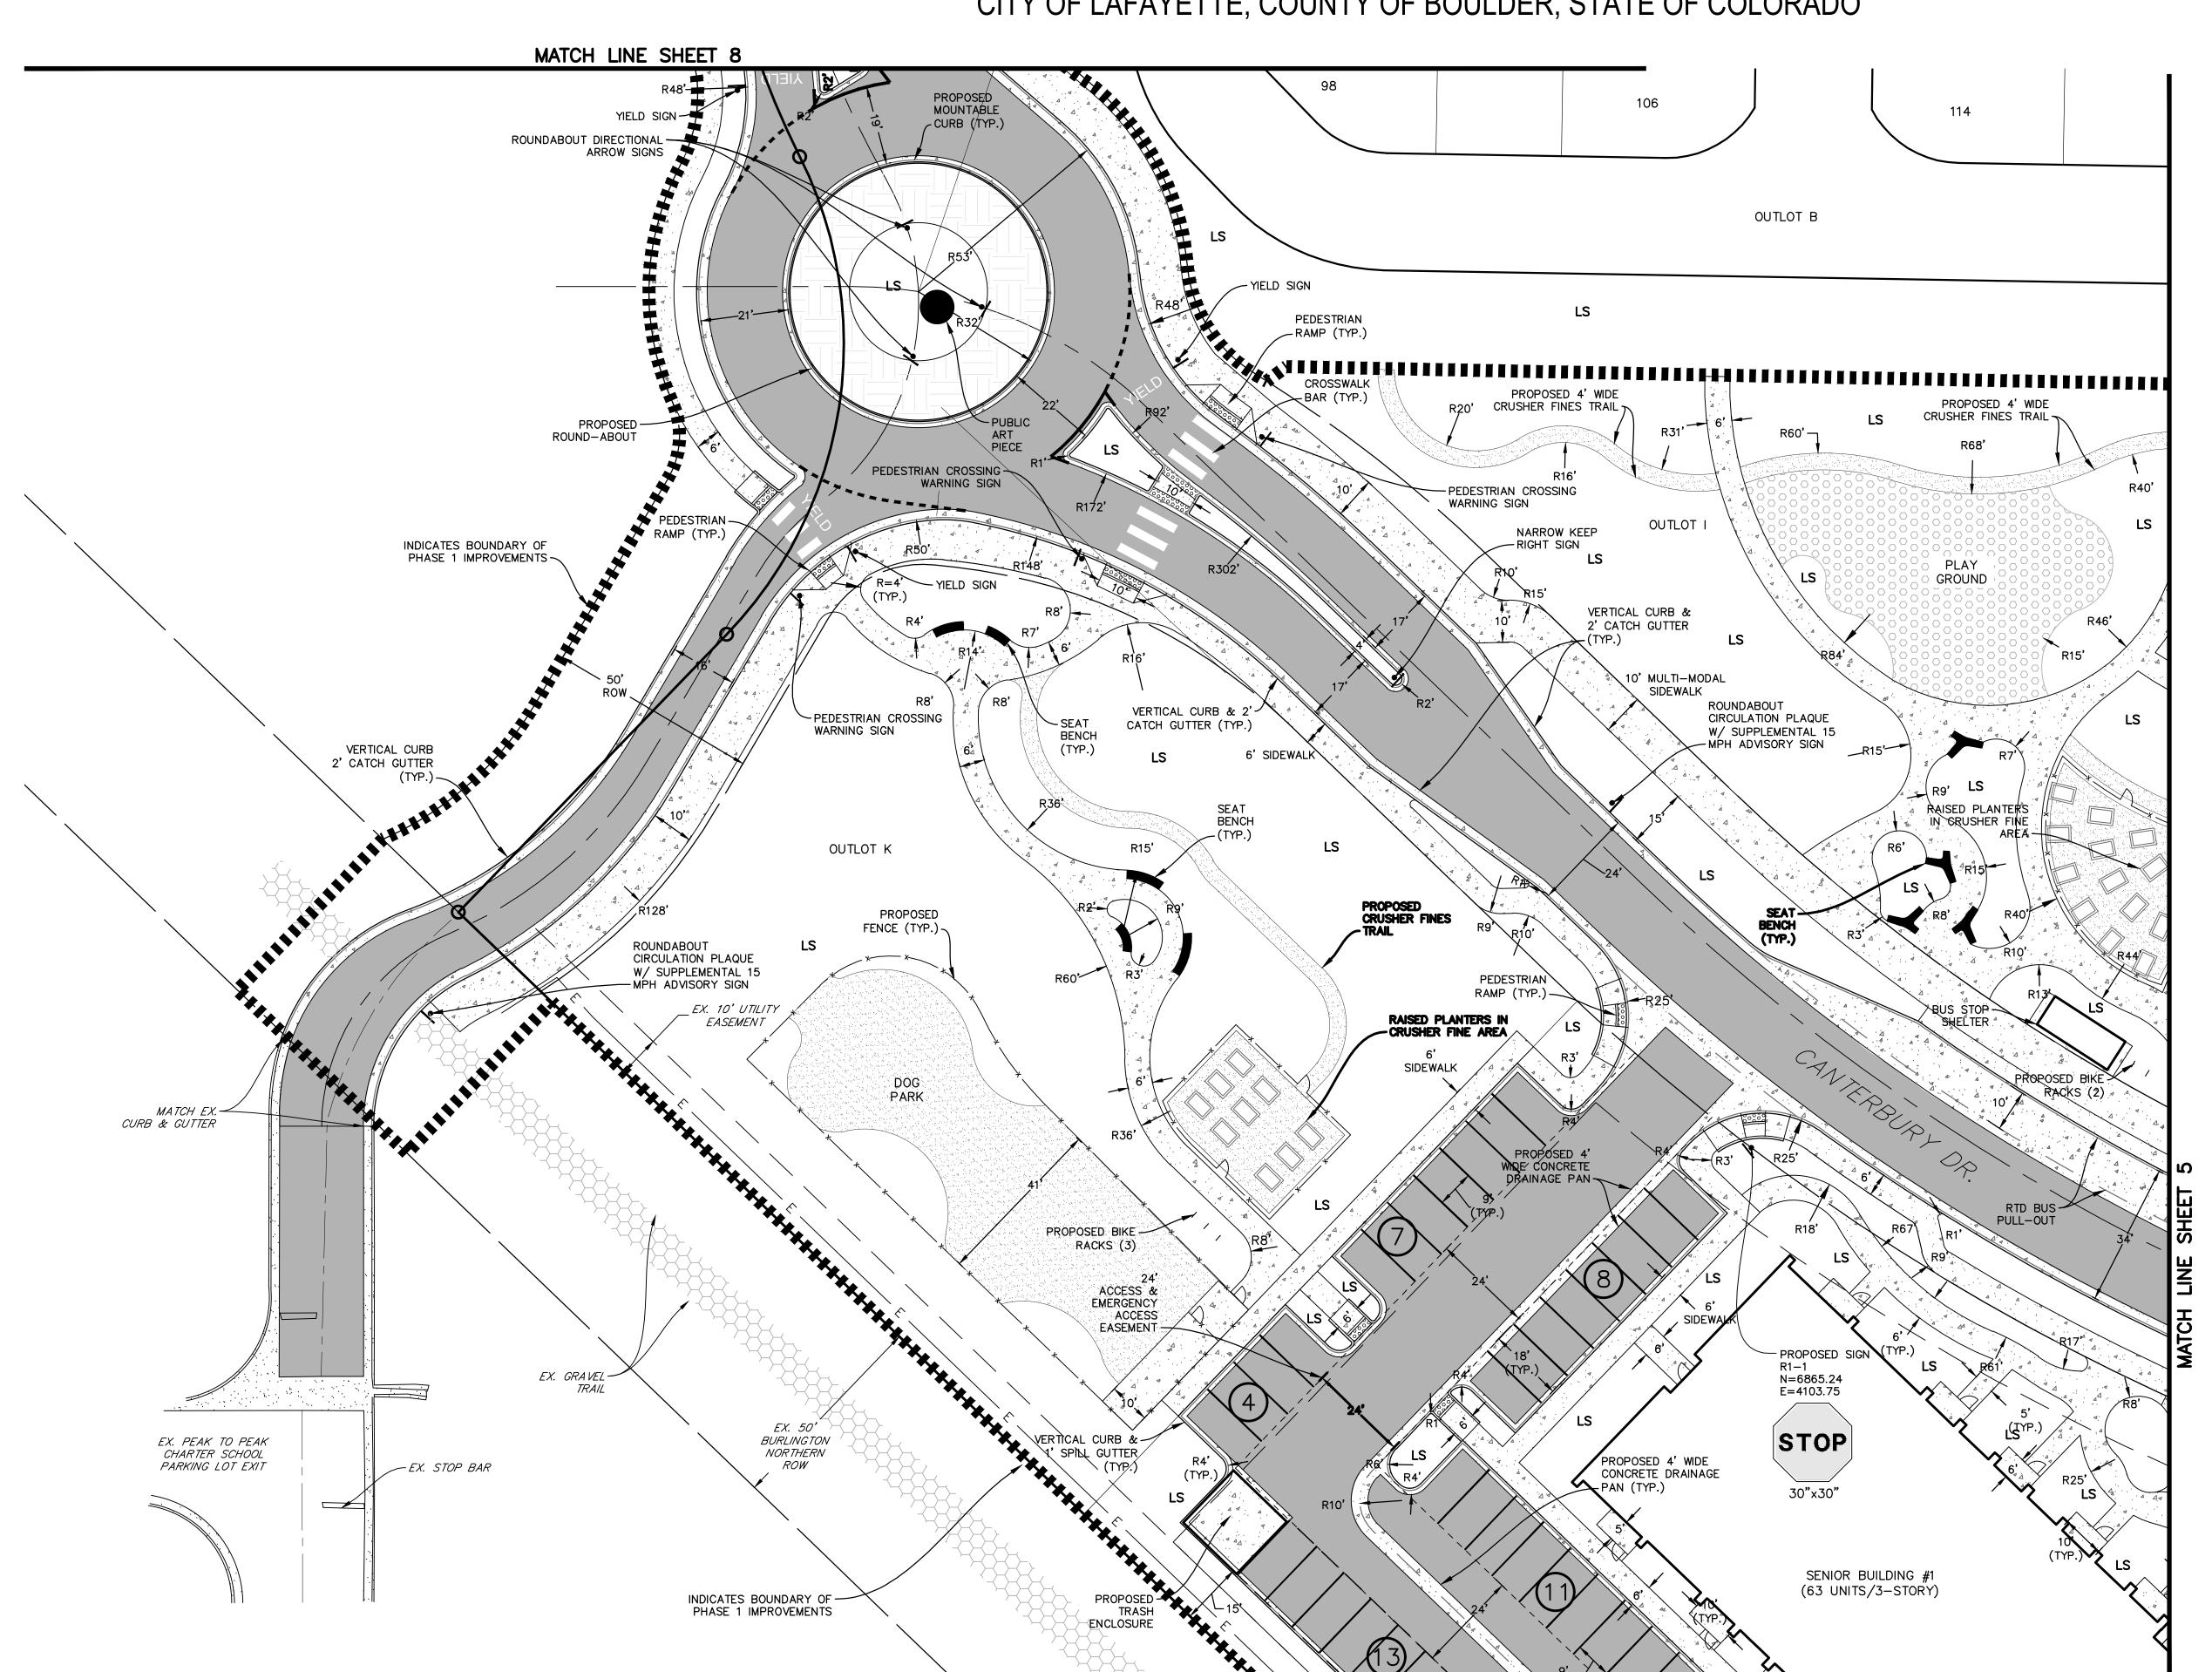
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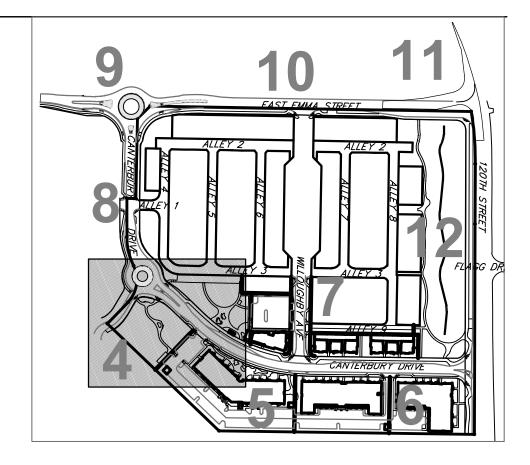
09.15.22 - SITE PLAN 02


SHEET TITLE:

OVERALL SITE PLAN

LOTS 161, 164, 165, 166 & 167, & OUTLOTS F, I, J, K, L & N OF THE WILLOUGHBY CORNER SUBDIVISION, CITY OF LAFAYETTE, COUNTY OF BOULDER, STATE OF COLORADO





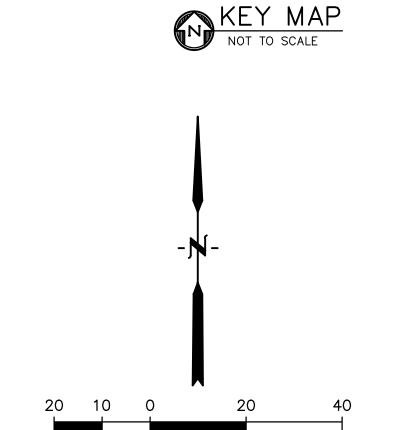

<u>LEGEND</u>

ORIGINAL SCALE: 1"=20'

PROPERTY LINE
PARKING SPACES
PRE-WIRED EV STALLS
LANDSCAPE AREALS
PROPOSED CONCRETE
PROPOSED ASPHALT
PROPOSED SIGN
PROPOSED PHASE LINE
HANDICAP PARKING SPACE

ELECTRIC VEHICLE PARKING SPACE

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WILLOUGHBY CORNE

OWNER:

BOULDER COUNTY HOUSING

AUTHORITY 3400 BROADWAY

BOULDER, CO - 80304 303.441.3861 CONTACT: MOLLY CHIANG


DATE: 06.17.22 - SITE PLAN 01 09.15.22 - SITE PLAN 02


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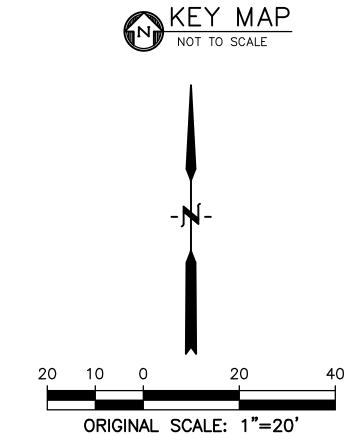
SITE PLAN

1

LOTS 161, 164, 165, 166 & 167, & OUTLOTS F, I, J, K, L & N OF THE WILLOUGHBY CORNER SUBDIVISION, CITY OF LAFAYETTE. COUNTY OF BOULDER. STATE OF COLORADO



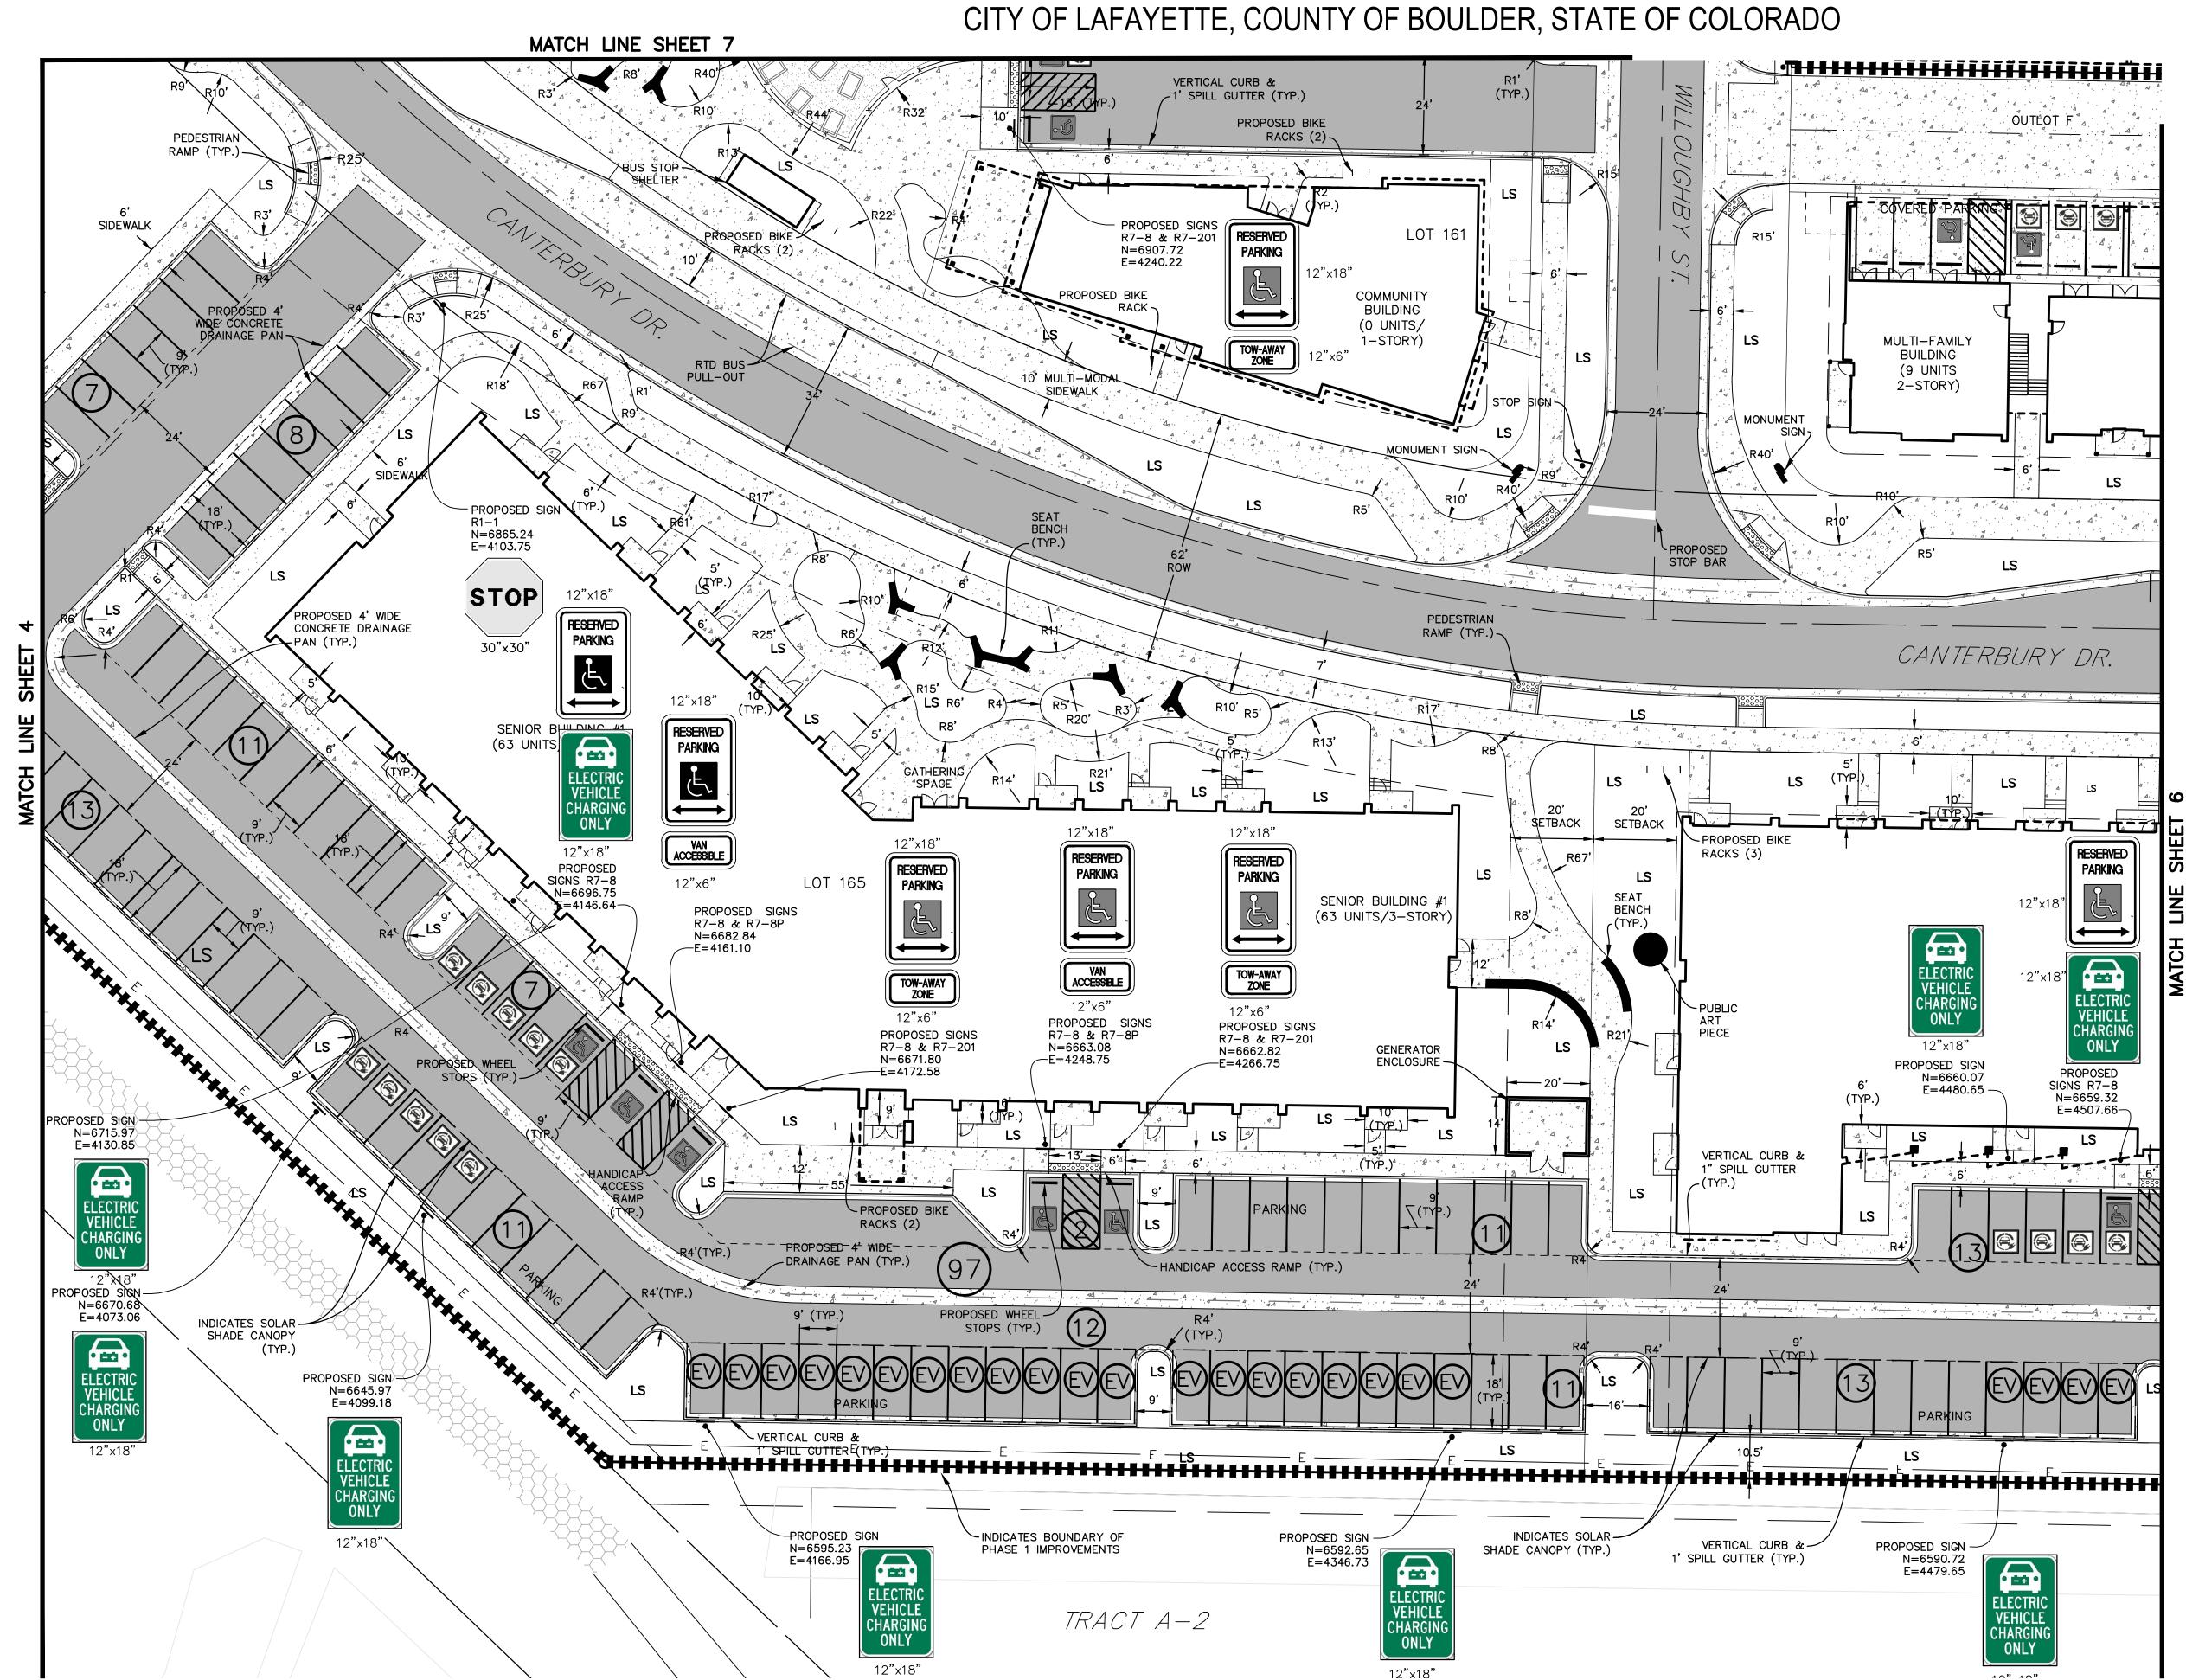

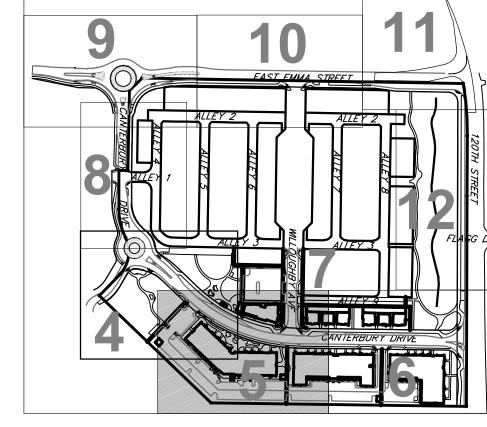

LEGEND

<u>LL GLIVD</u>
PROPERTY LINE
PARKING SPACES
PRE-WIRED EV STALLS
LANDSCAPE AREA LS
PROPOSED CONCRETE
PROPOSED ASPHALT
PROPOSED SIGN
PROPOSED PHASE LINE
HANDICAP PARKING SPACE

ELECTRIC VEHICLE PARKING SPACE.

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WILLOUGHBY CORNE SITE PLAN- PHASE 1

BOULDER COUNTY HOUSING

AUTHORITY

3400 BROADWAY

BOULDER, CO - 80304


303.441.3861

CONTACT: MOLLY CHIANG

DATE: 06.17.22 - SITE PLAN 01 09.15.22 - SITE PLAN 02

SHEET TITLE:

PLAN

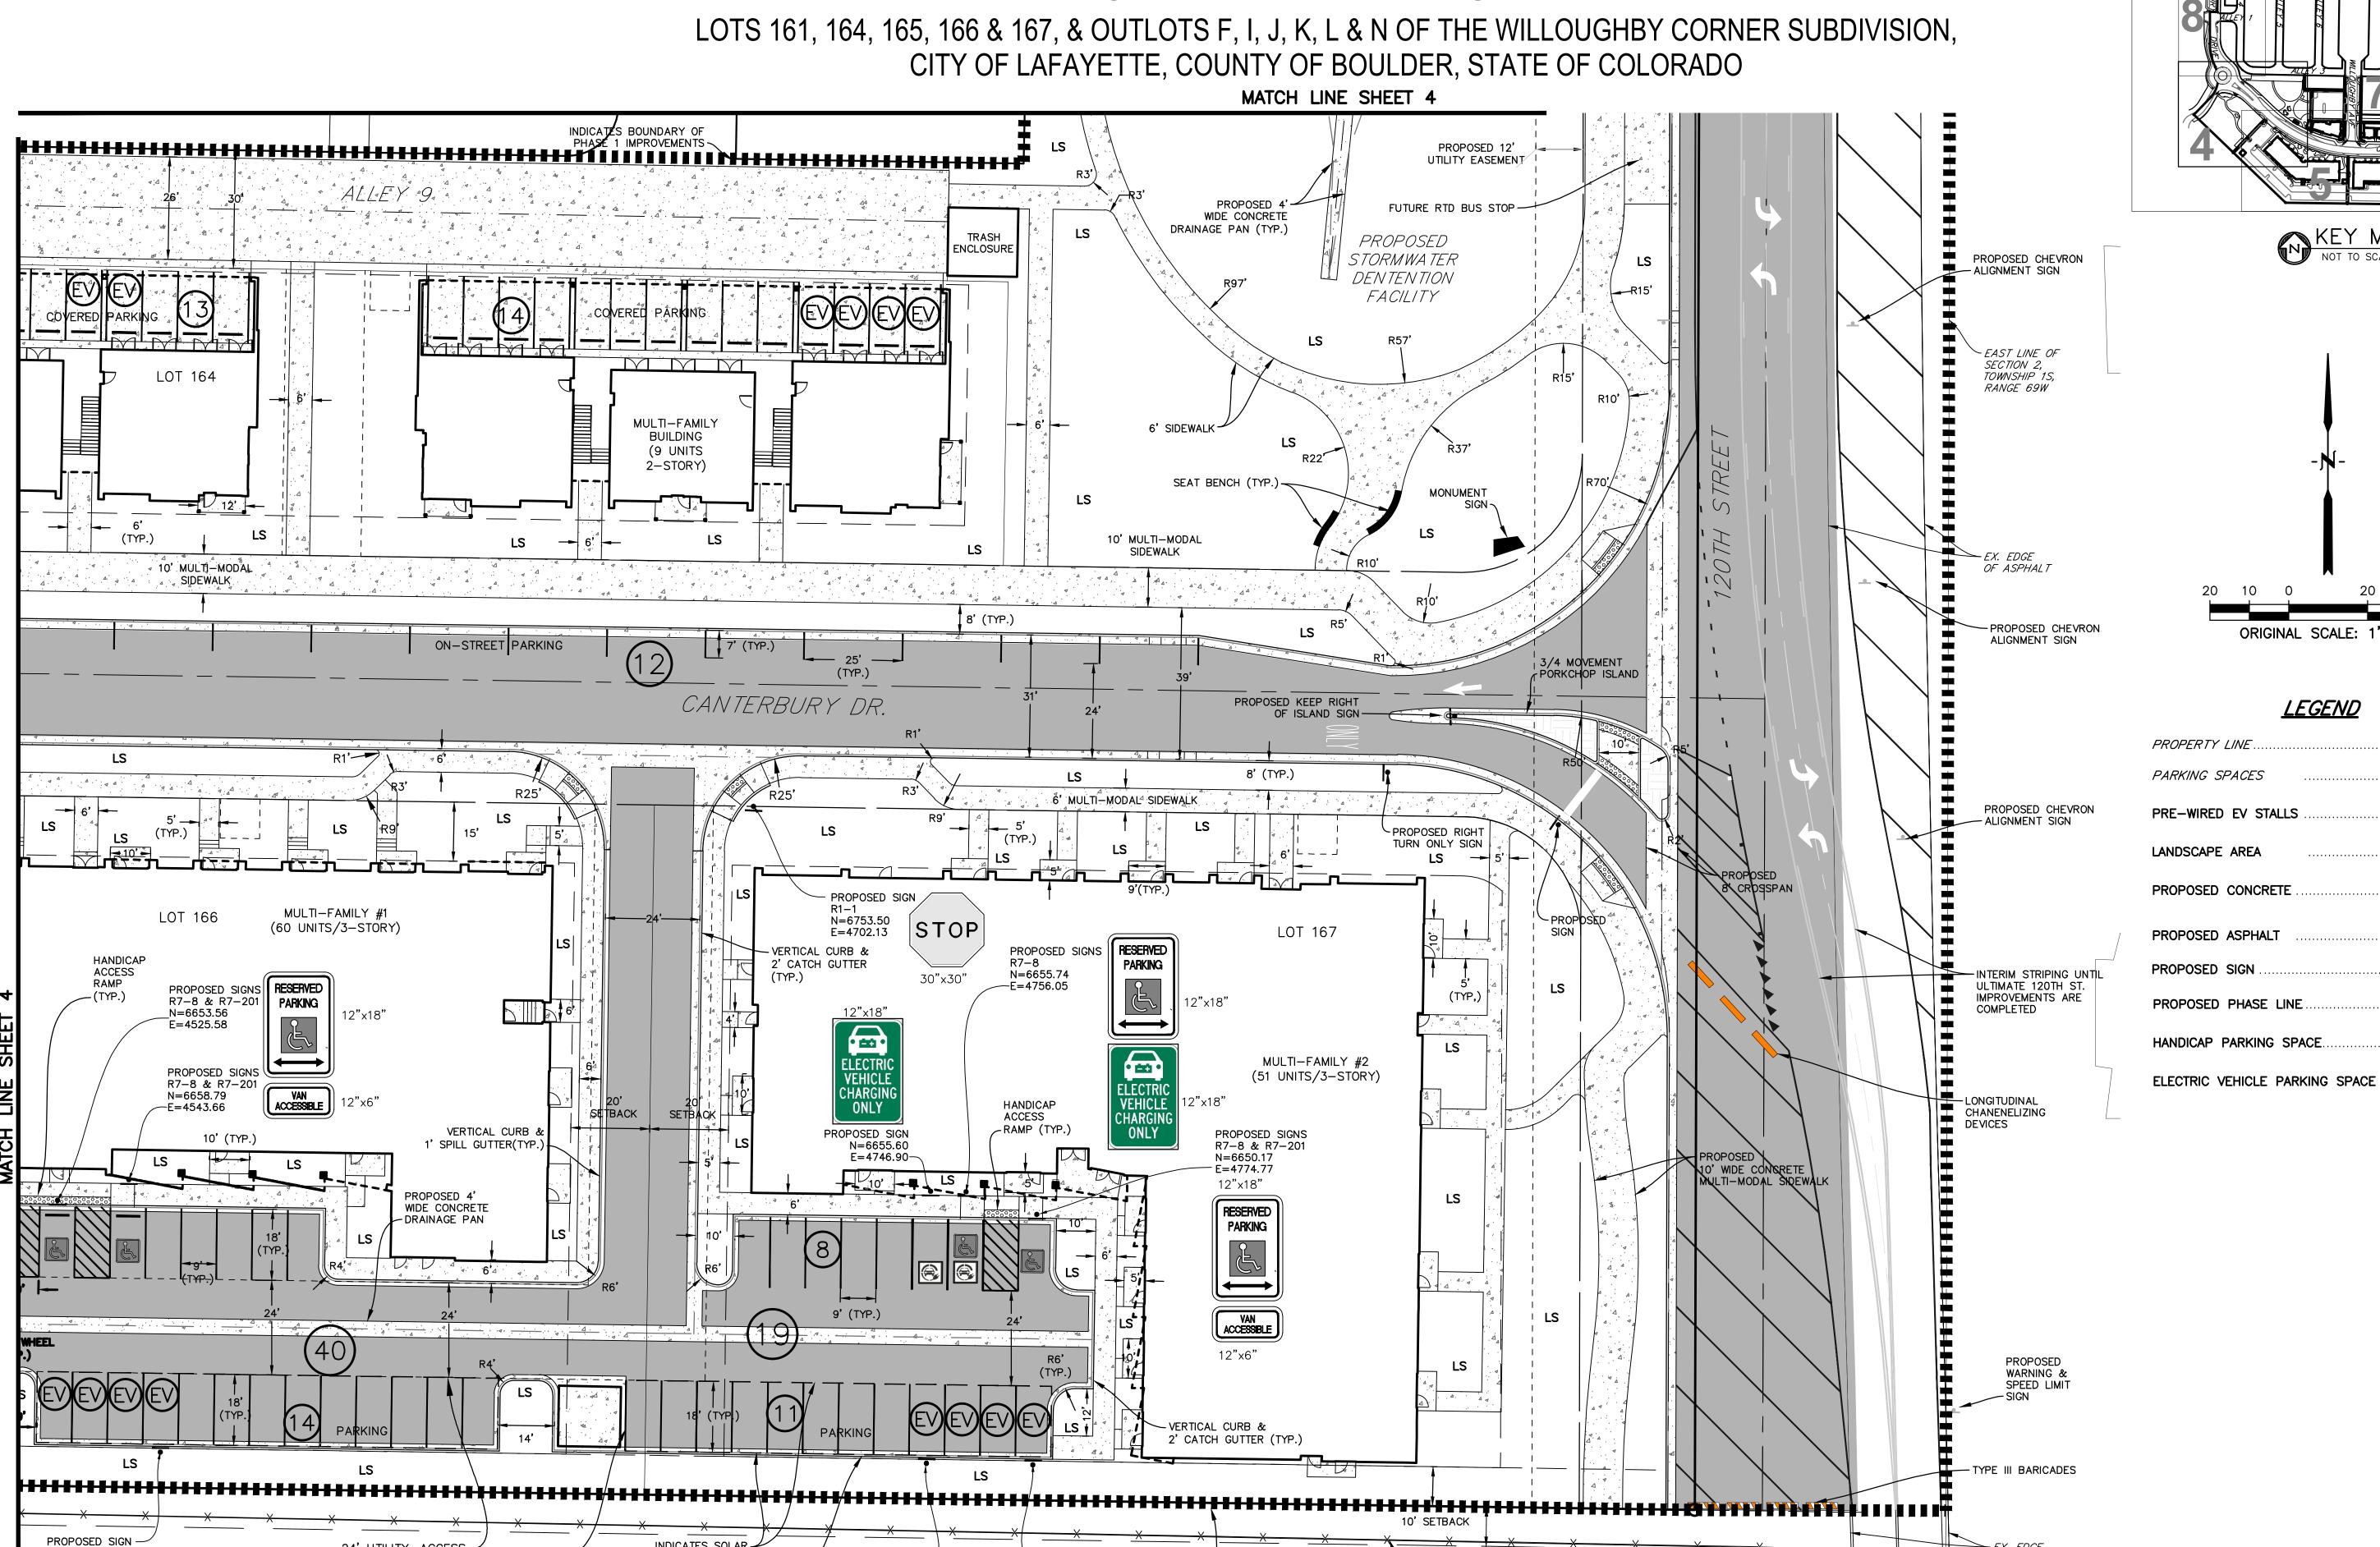

NDICATES BOUNDARY OF PHASE 1 IMPROVEMENTS

N=6586.45

E = 4772.98

ONLY

INDICATES SOLAR

VERTICAL CURB &-

1' SPILL GUTTER (TYP.)

PROPOSED SIGN-

N=6586.19 E=4745.76

SHADE CANOPY (TYP.)

24' UTILITY, ACCESS-

ACCESS EASEMENT

E=4551.64

ONLY

AND EMERGENCY

ENCLOSURE

PLATTNER TRACT



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BOULDER COUNTY HOUSING

AUTHORITY

3400 BROADWAY

BOULDER, CO - 80304 303.441.3861

CONTACT: MOLLY CHIANG

.

─ EX. EDGE

STRUCTURE

- EX. FENCE

EX. 10' ELECTRICITY & NATURAL


(REC. NO. 2255539)

– GAS EASEMENT & AGREEMENT


~ EX. FENCE


DATE: <u>06.17.22 - SITE PLAN 01</u> 09.15.22 - SITE PLAN 02

LOTS 161, 164, 165, 166 & 167, & OUTLOTS F, I, J, K, L & N OF THE WILLOUGHBY CORNER SUBDIVISION, CITY OF LAFAYETTE, COUNTY OF BOULDER, STATE OF COLORADO

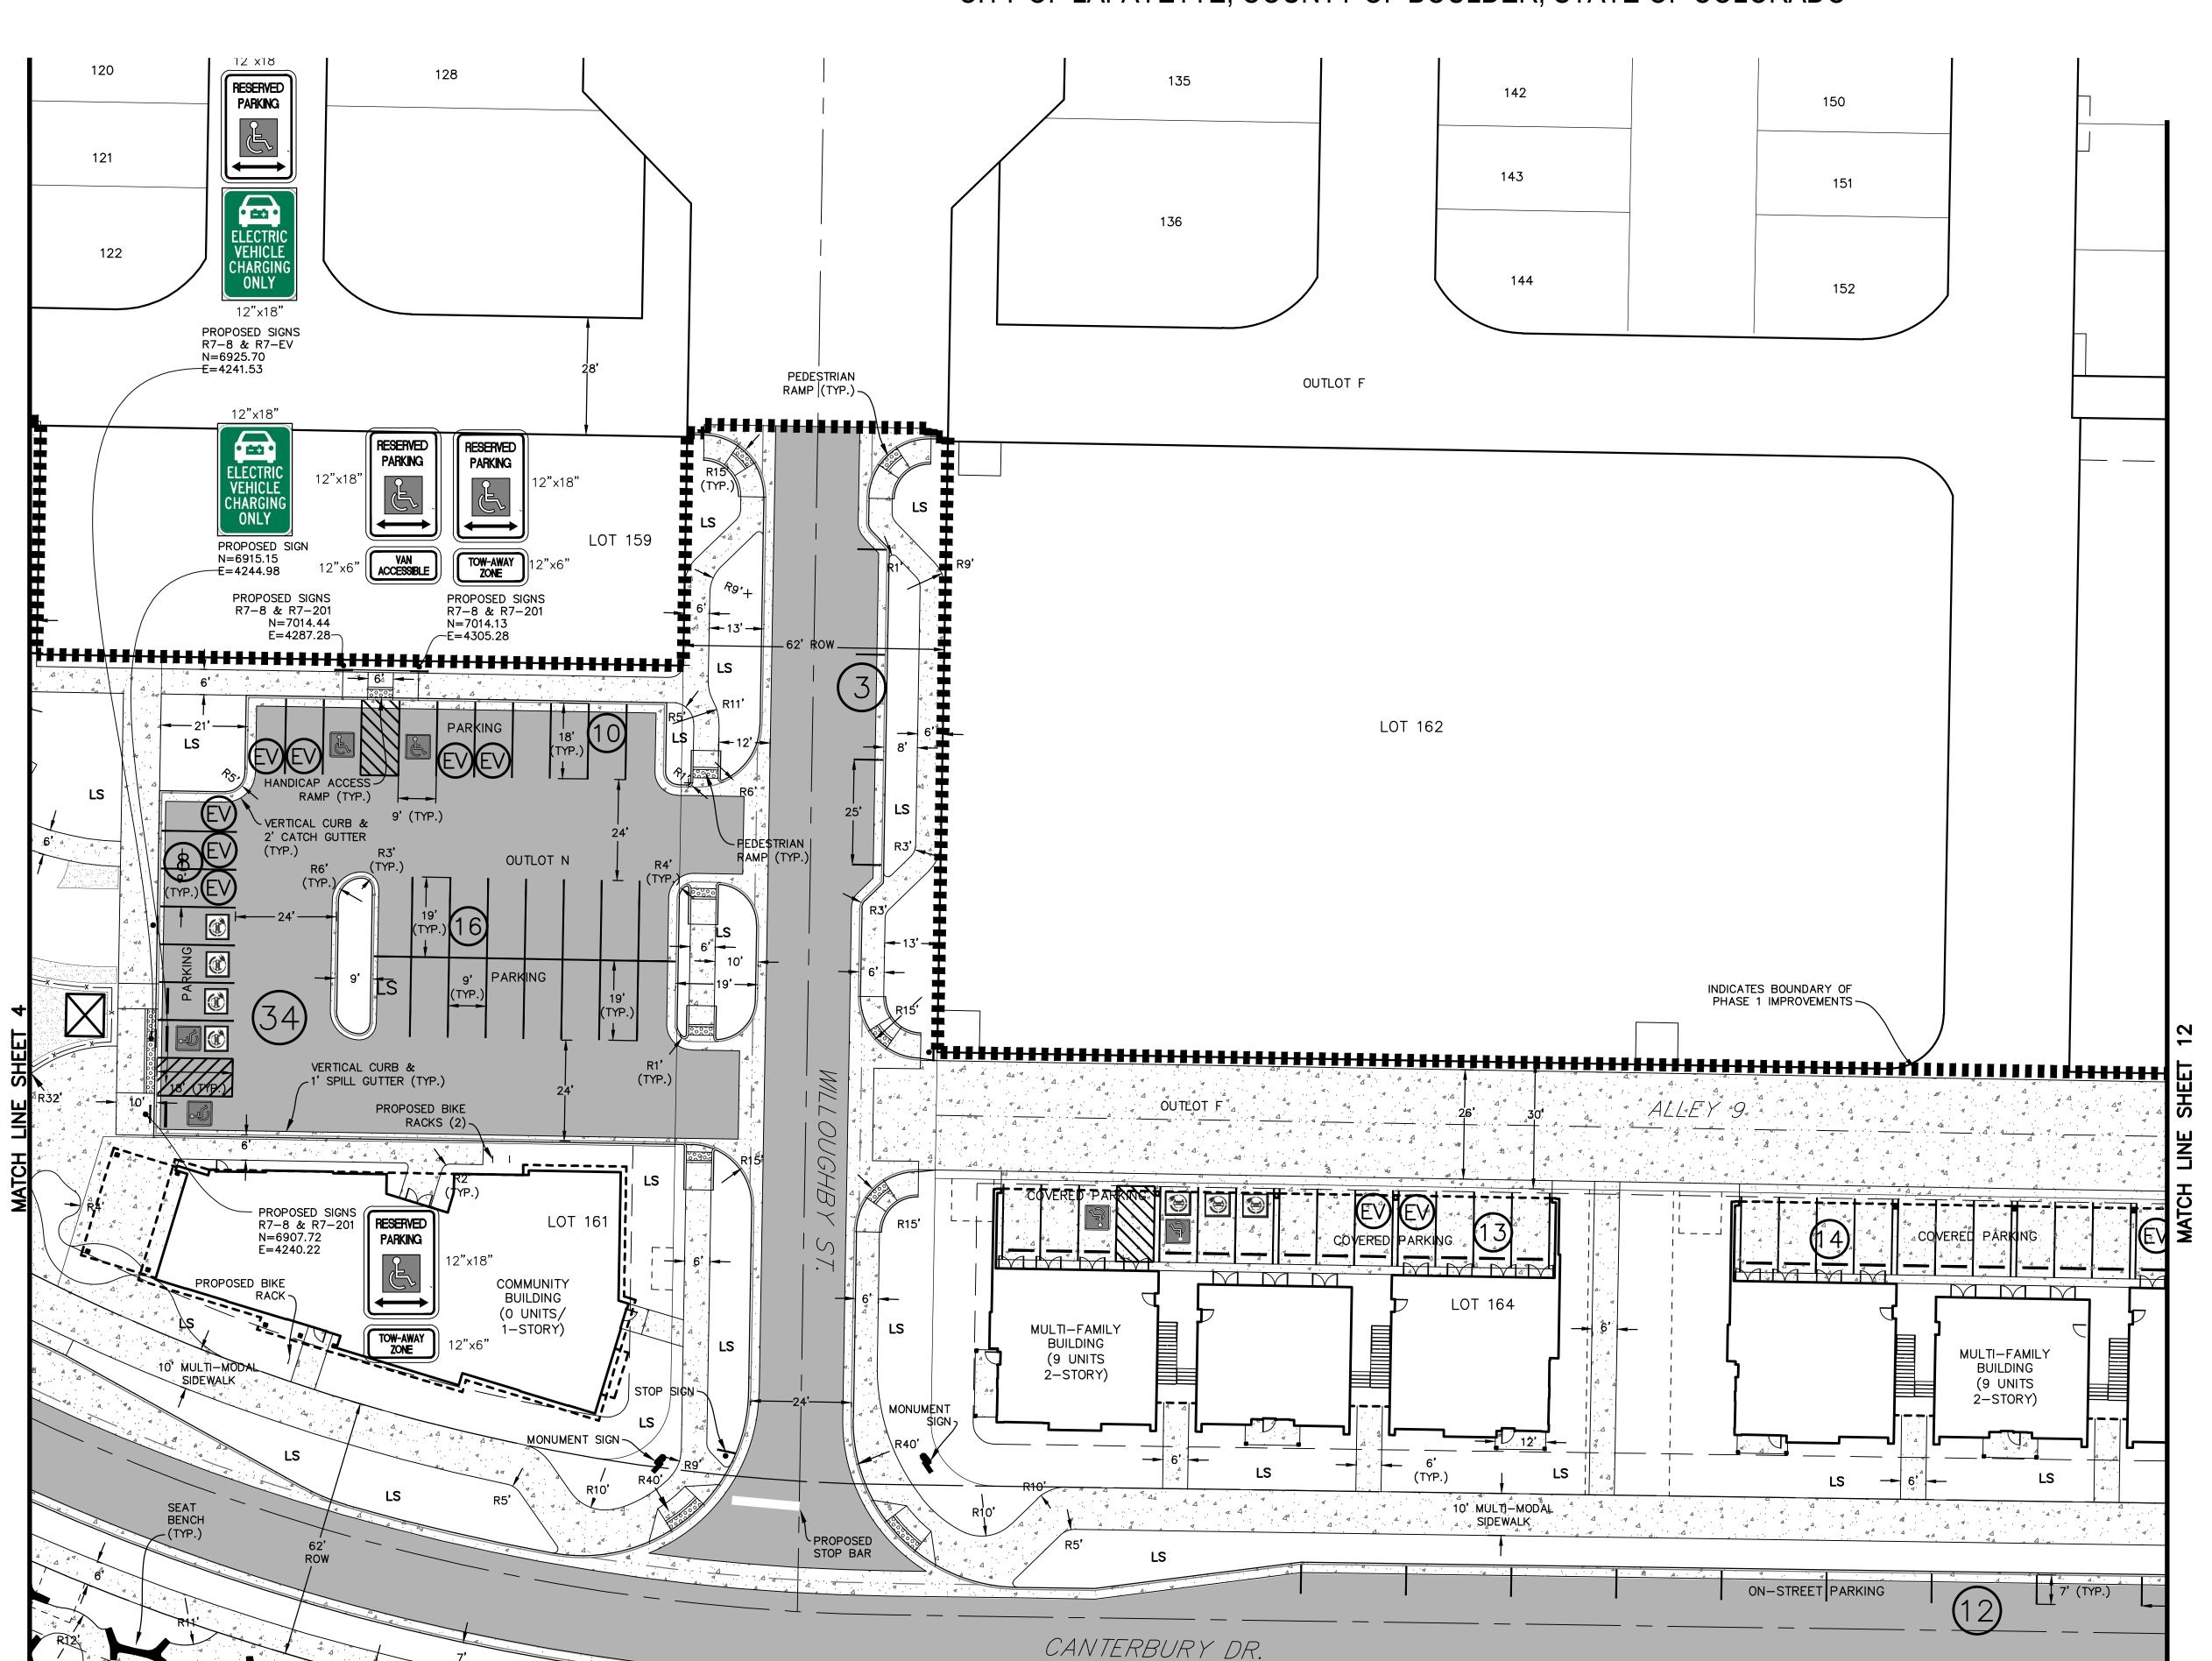

MATCH LINE SHEET 5

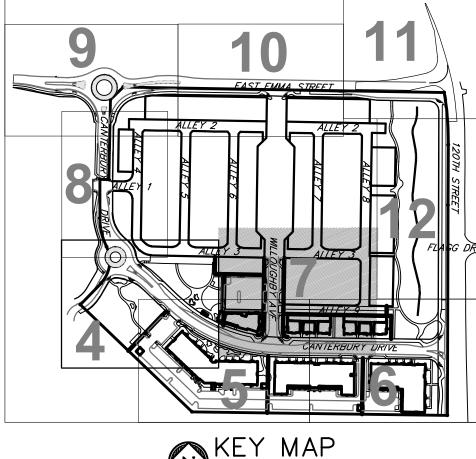

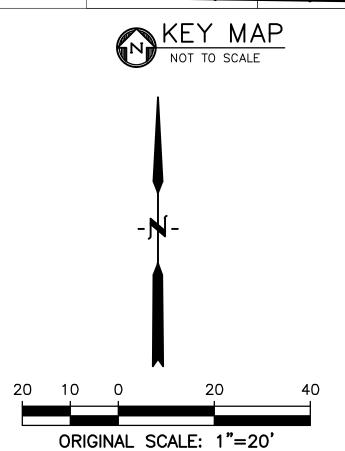

<u>LEGEND</u>

PROPERTY LINE
PARKING SPACES
PRE-WIRED EV STALLS
LANDSCAPE AREA LS
PROPOSED CONCRETE
PROPOSED ASPHALT
PROPOSED SIGN
PROPOSED PHASE LINE
HANDICAP PARKING SPACE

ELECTRIC VEHICLE PARKING SPACE

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WILLOUGHBY CORNEF SITE PLAN- PHASE 1
LAFAYETTE, COLORADO

BOULDER COUNTY HOUSING AUTHORITY 3400 BROADWAY BOULDER, CO - 80304 303.441.3861

CONTACT: MOLLY CHIANG

DATE: 06.17.22 - SITE PLAN 01 09.15.22 - SITE PLAN 02


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PLAN


LOTS 161, 164, 165, 166 & 167, & OUTLOTS F, I, J, K, L & N OF THE WILLOUGHBY CORNER SUBDIVISION, CITY OF LAFAYETTE, COUNTY OF BOULDER, STATE OF COLORADO

29


28

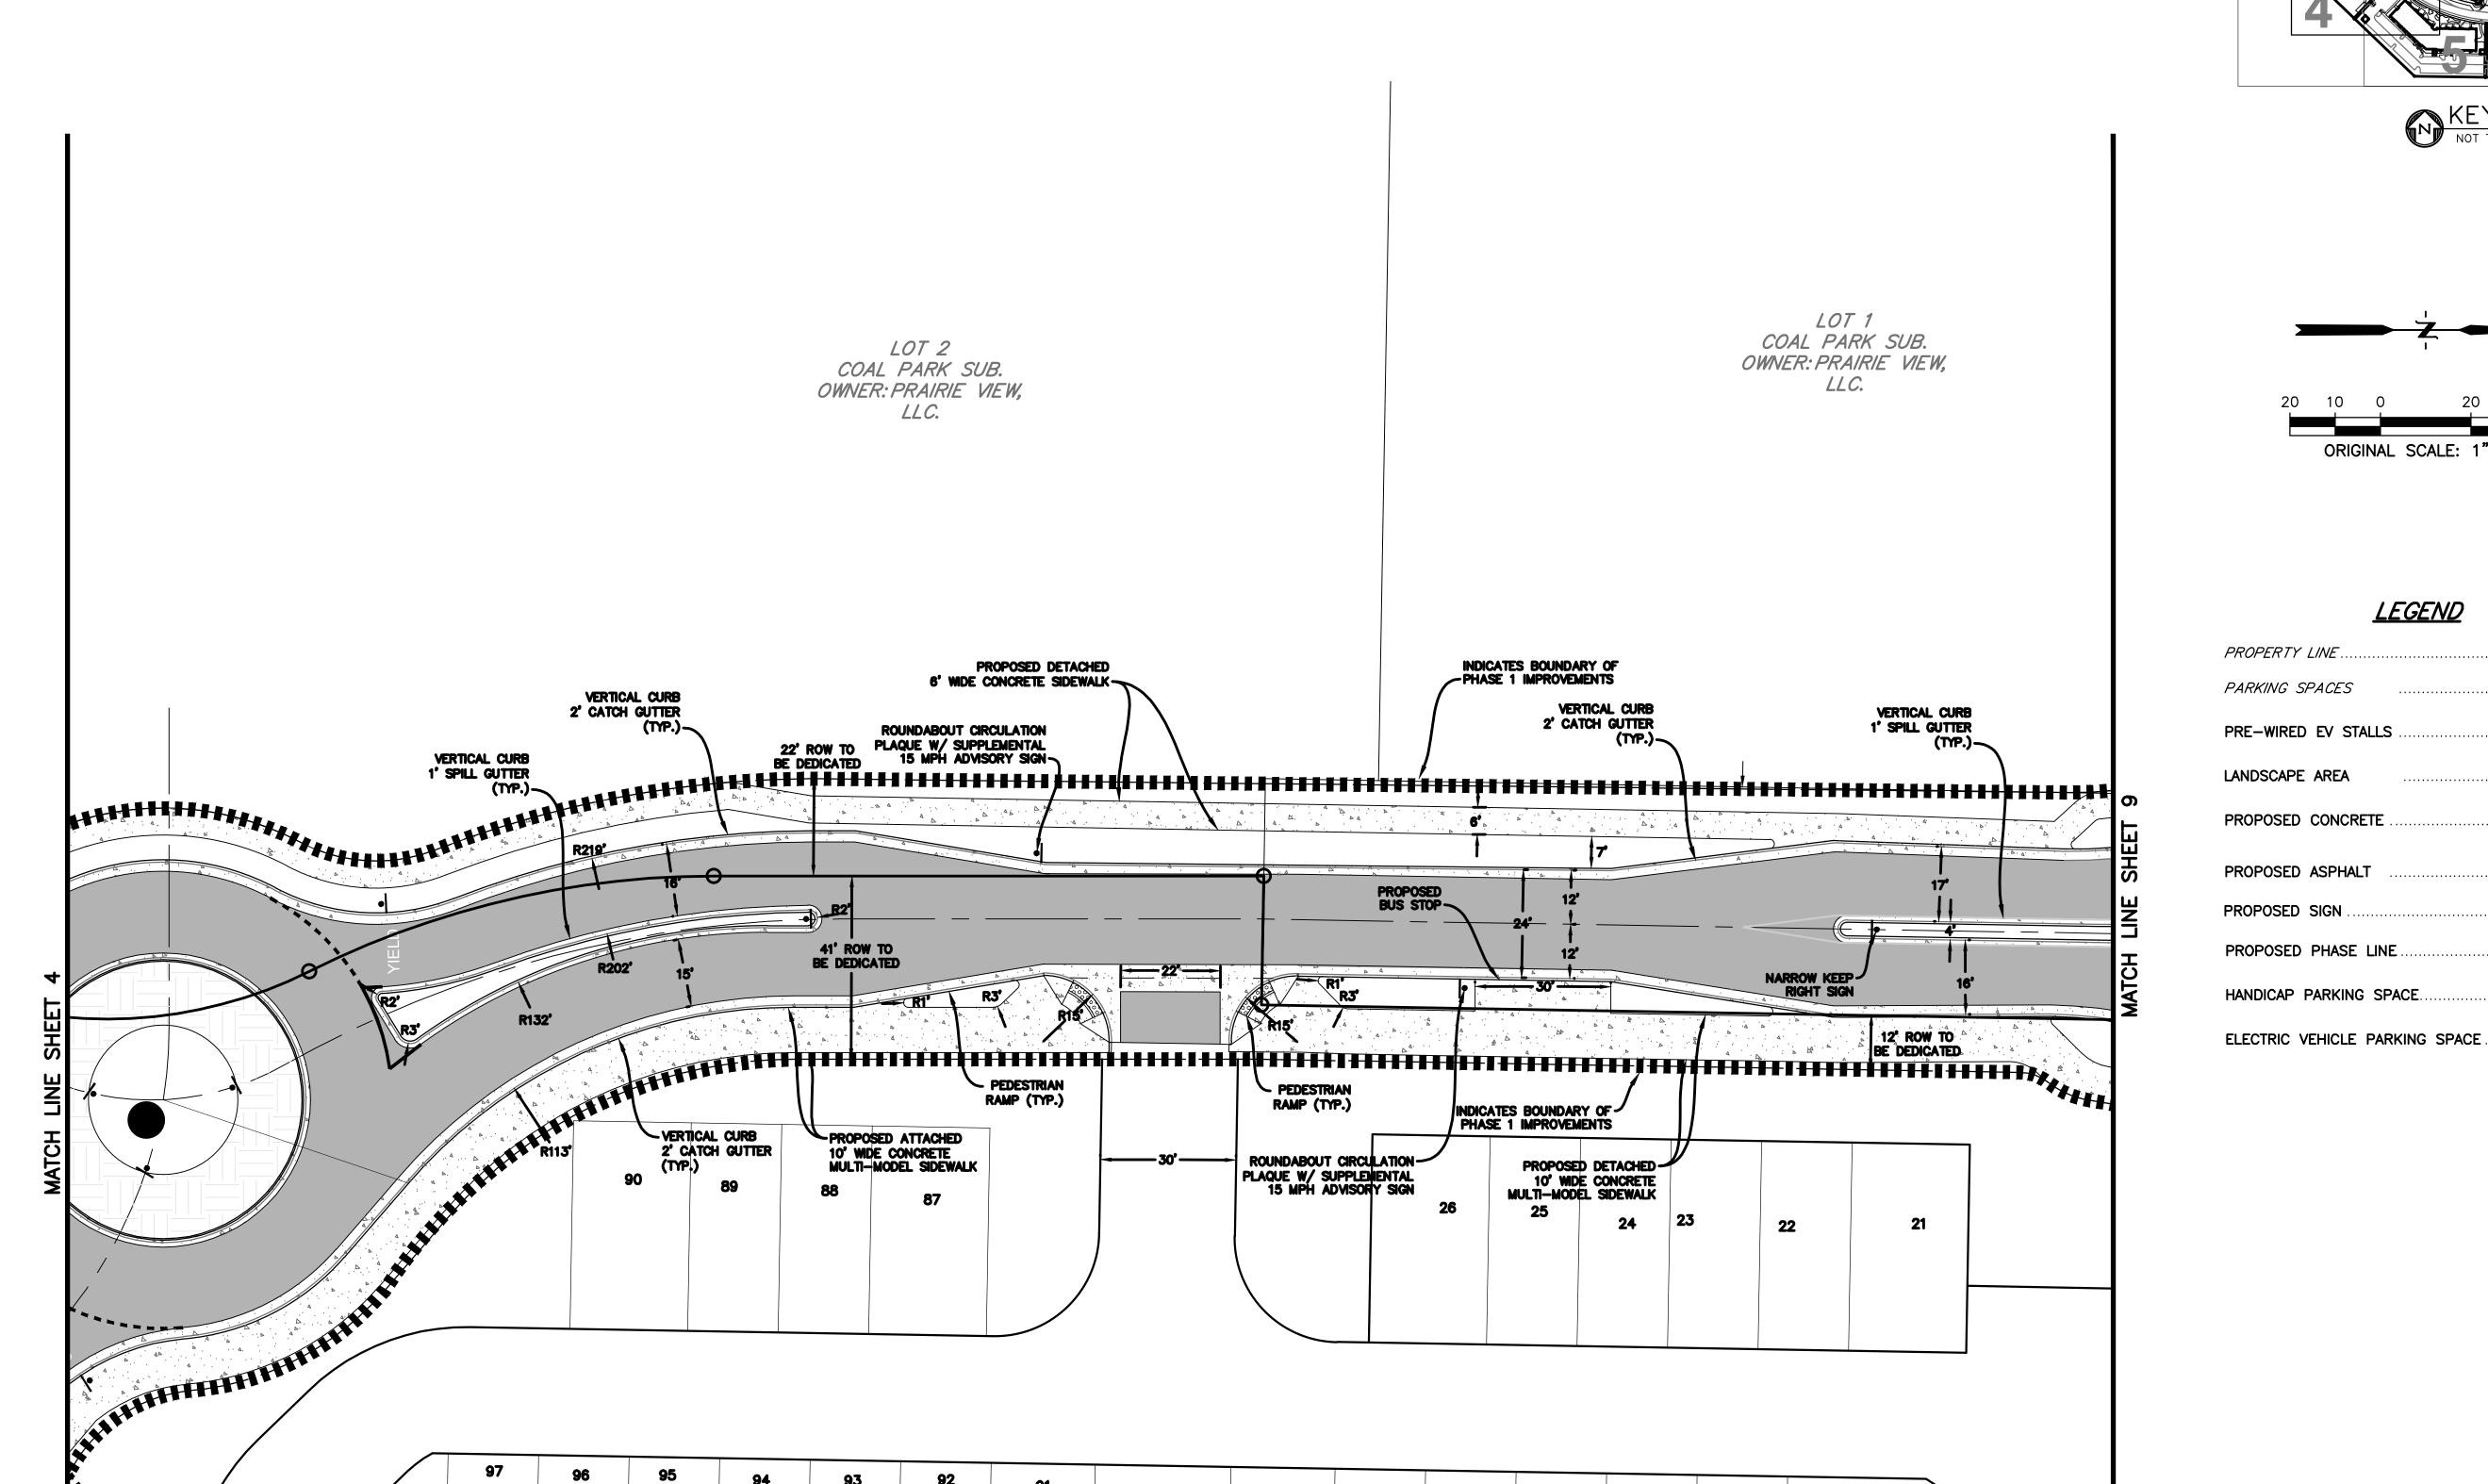

OUTLOT C

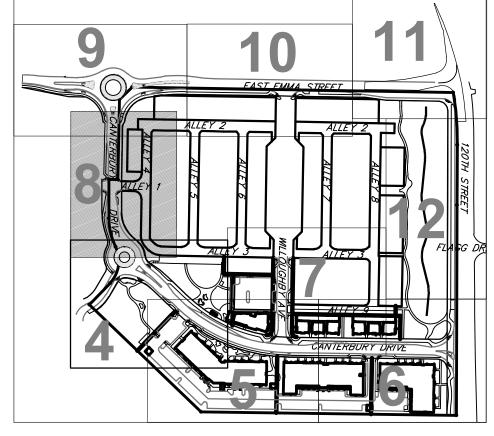



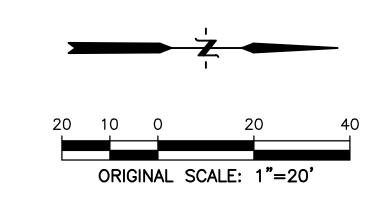

<u>LEGEND</u>

PROPERTY LINE
PARKING SPACES
PRE-WIRED EV STALLS
LANDSCAPE AREA LS
PROPOSED CONCRETE
PROPOSED ASPHALT
PROPOSED SIGN
PROPOSED PHASE LINE
HANDICAP PARKING SPACE


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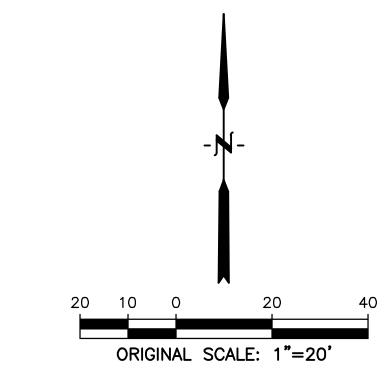
BOULDER COUNTY HOUSING AUTHORITY 3400 BROADWAY BOULDER, CO - 80304 303.441.3861 CONTACT: MOLLY CHIANG

DATE: 06.17.22 - SITE PLAN 01 09.15.22 - SITE PLAN 02

LOTS 161, 164, 165, 166 & 167, & OUTLOTS F, I, J, K, L & N OF THE WILLOUGHBY CORNER SUBDIVISION, CITY OF LAFAYETTE, COUNTY OF BOULDER, STATE OF COLORADO





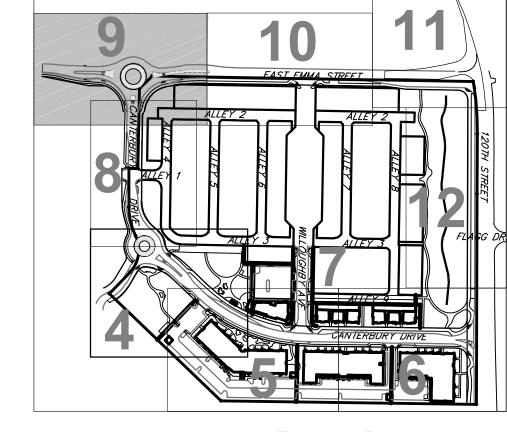

<u>LEGEND</u>

PARKING SPACES
PRE-WIRED EV STALLS
LANDSCAPE AREA LS
PROPOSED CONCRETE
PROPOSED ASPHALT
PROPOSED SIGN
PROPOSED PHASE LINE

BOULDER, CO - 80304 303.441.3861 CONTACT: MOLLY CHIANG

OWNER:

BOULDER COUNTY HOUSING AUTHORITY 3400 BROADWAY

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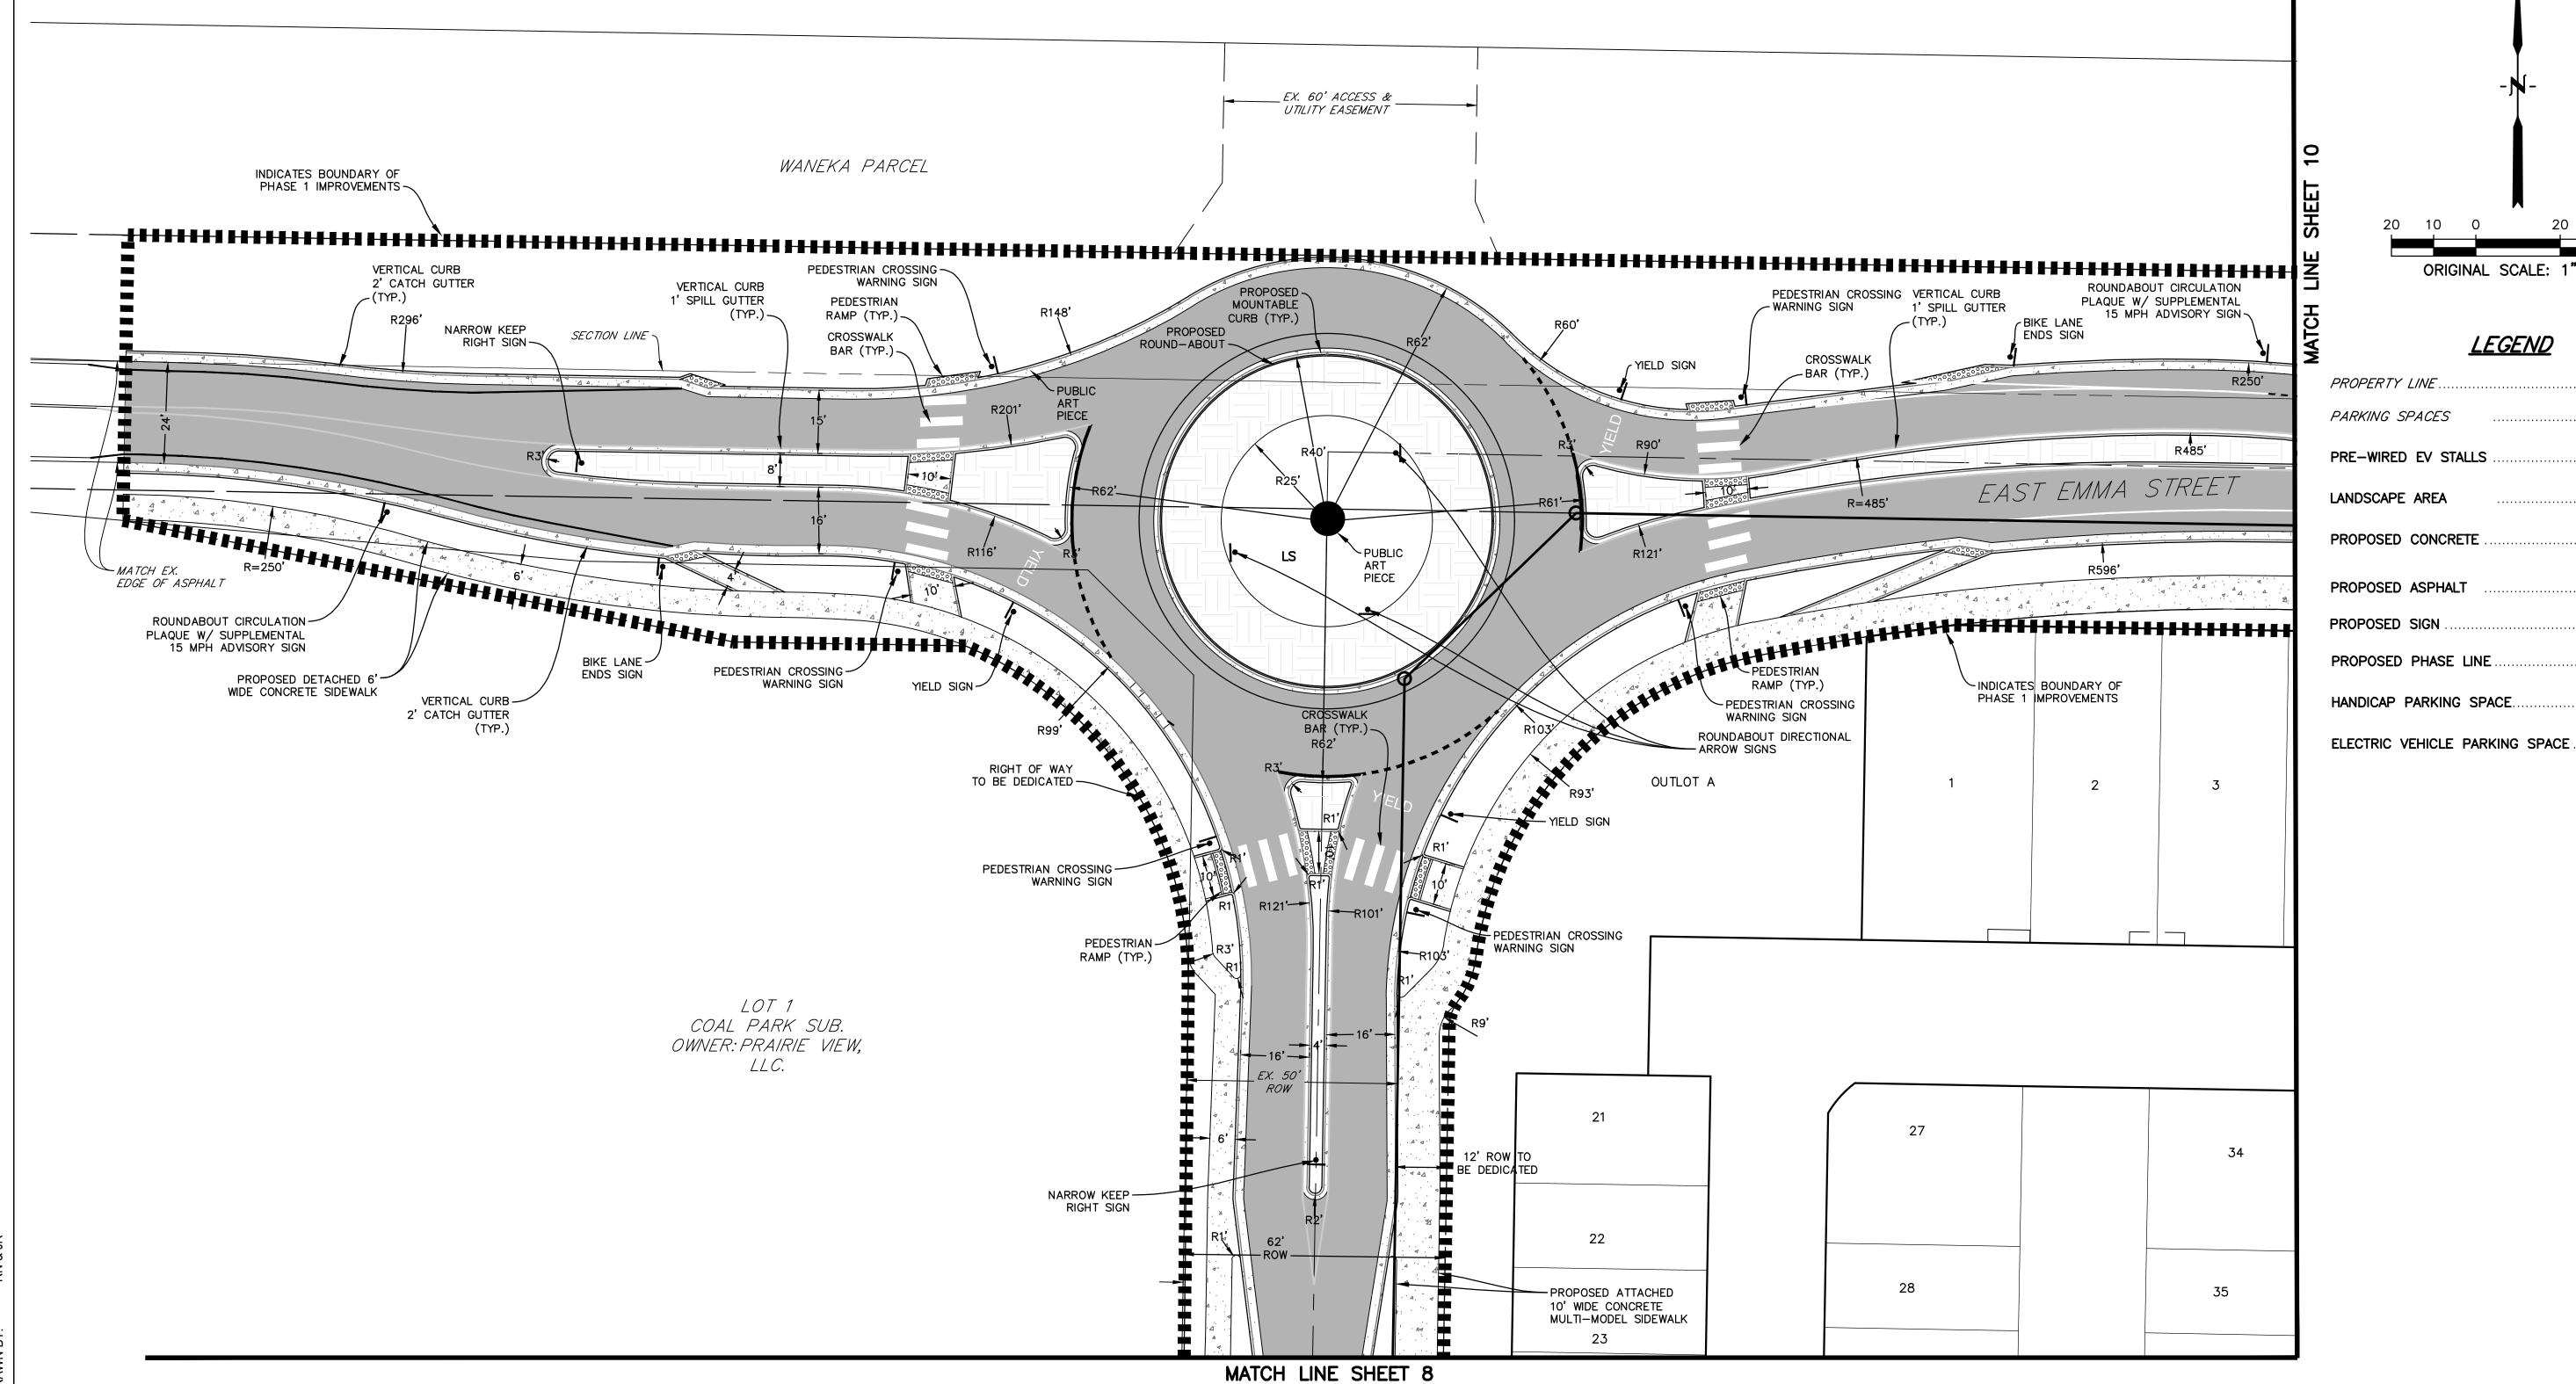
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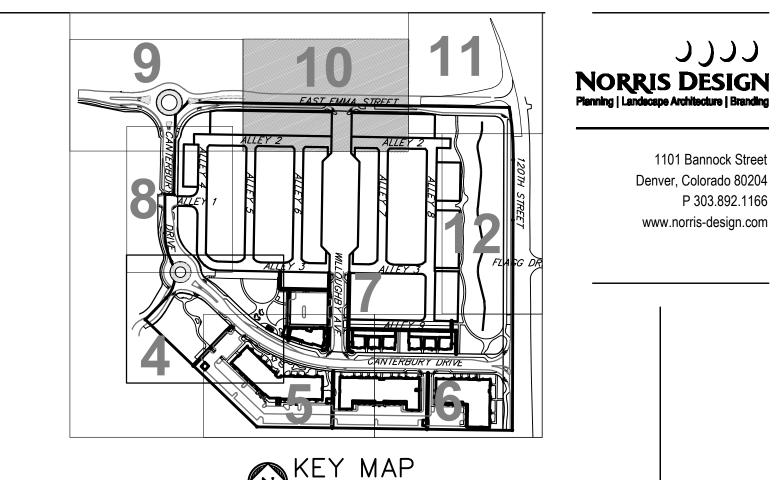
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ORIGINAL SCALE: 1"=20'

<u>LEGEND</u>

PROPERTY LINE	- —
PARKING SPACES	
PRE-WIRED EV STALLS	
LANDSCAPE AREALS	
PROPOSED CONCRETE	4
PROPOSED ASPHALT	

.............

PROPOSED SIGN.

PROPOSED PHASE LINE. HANDICAP PARKING SPACE.

ELECTRIC VEHICLE PARKING SPACE

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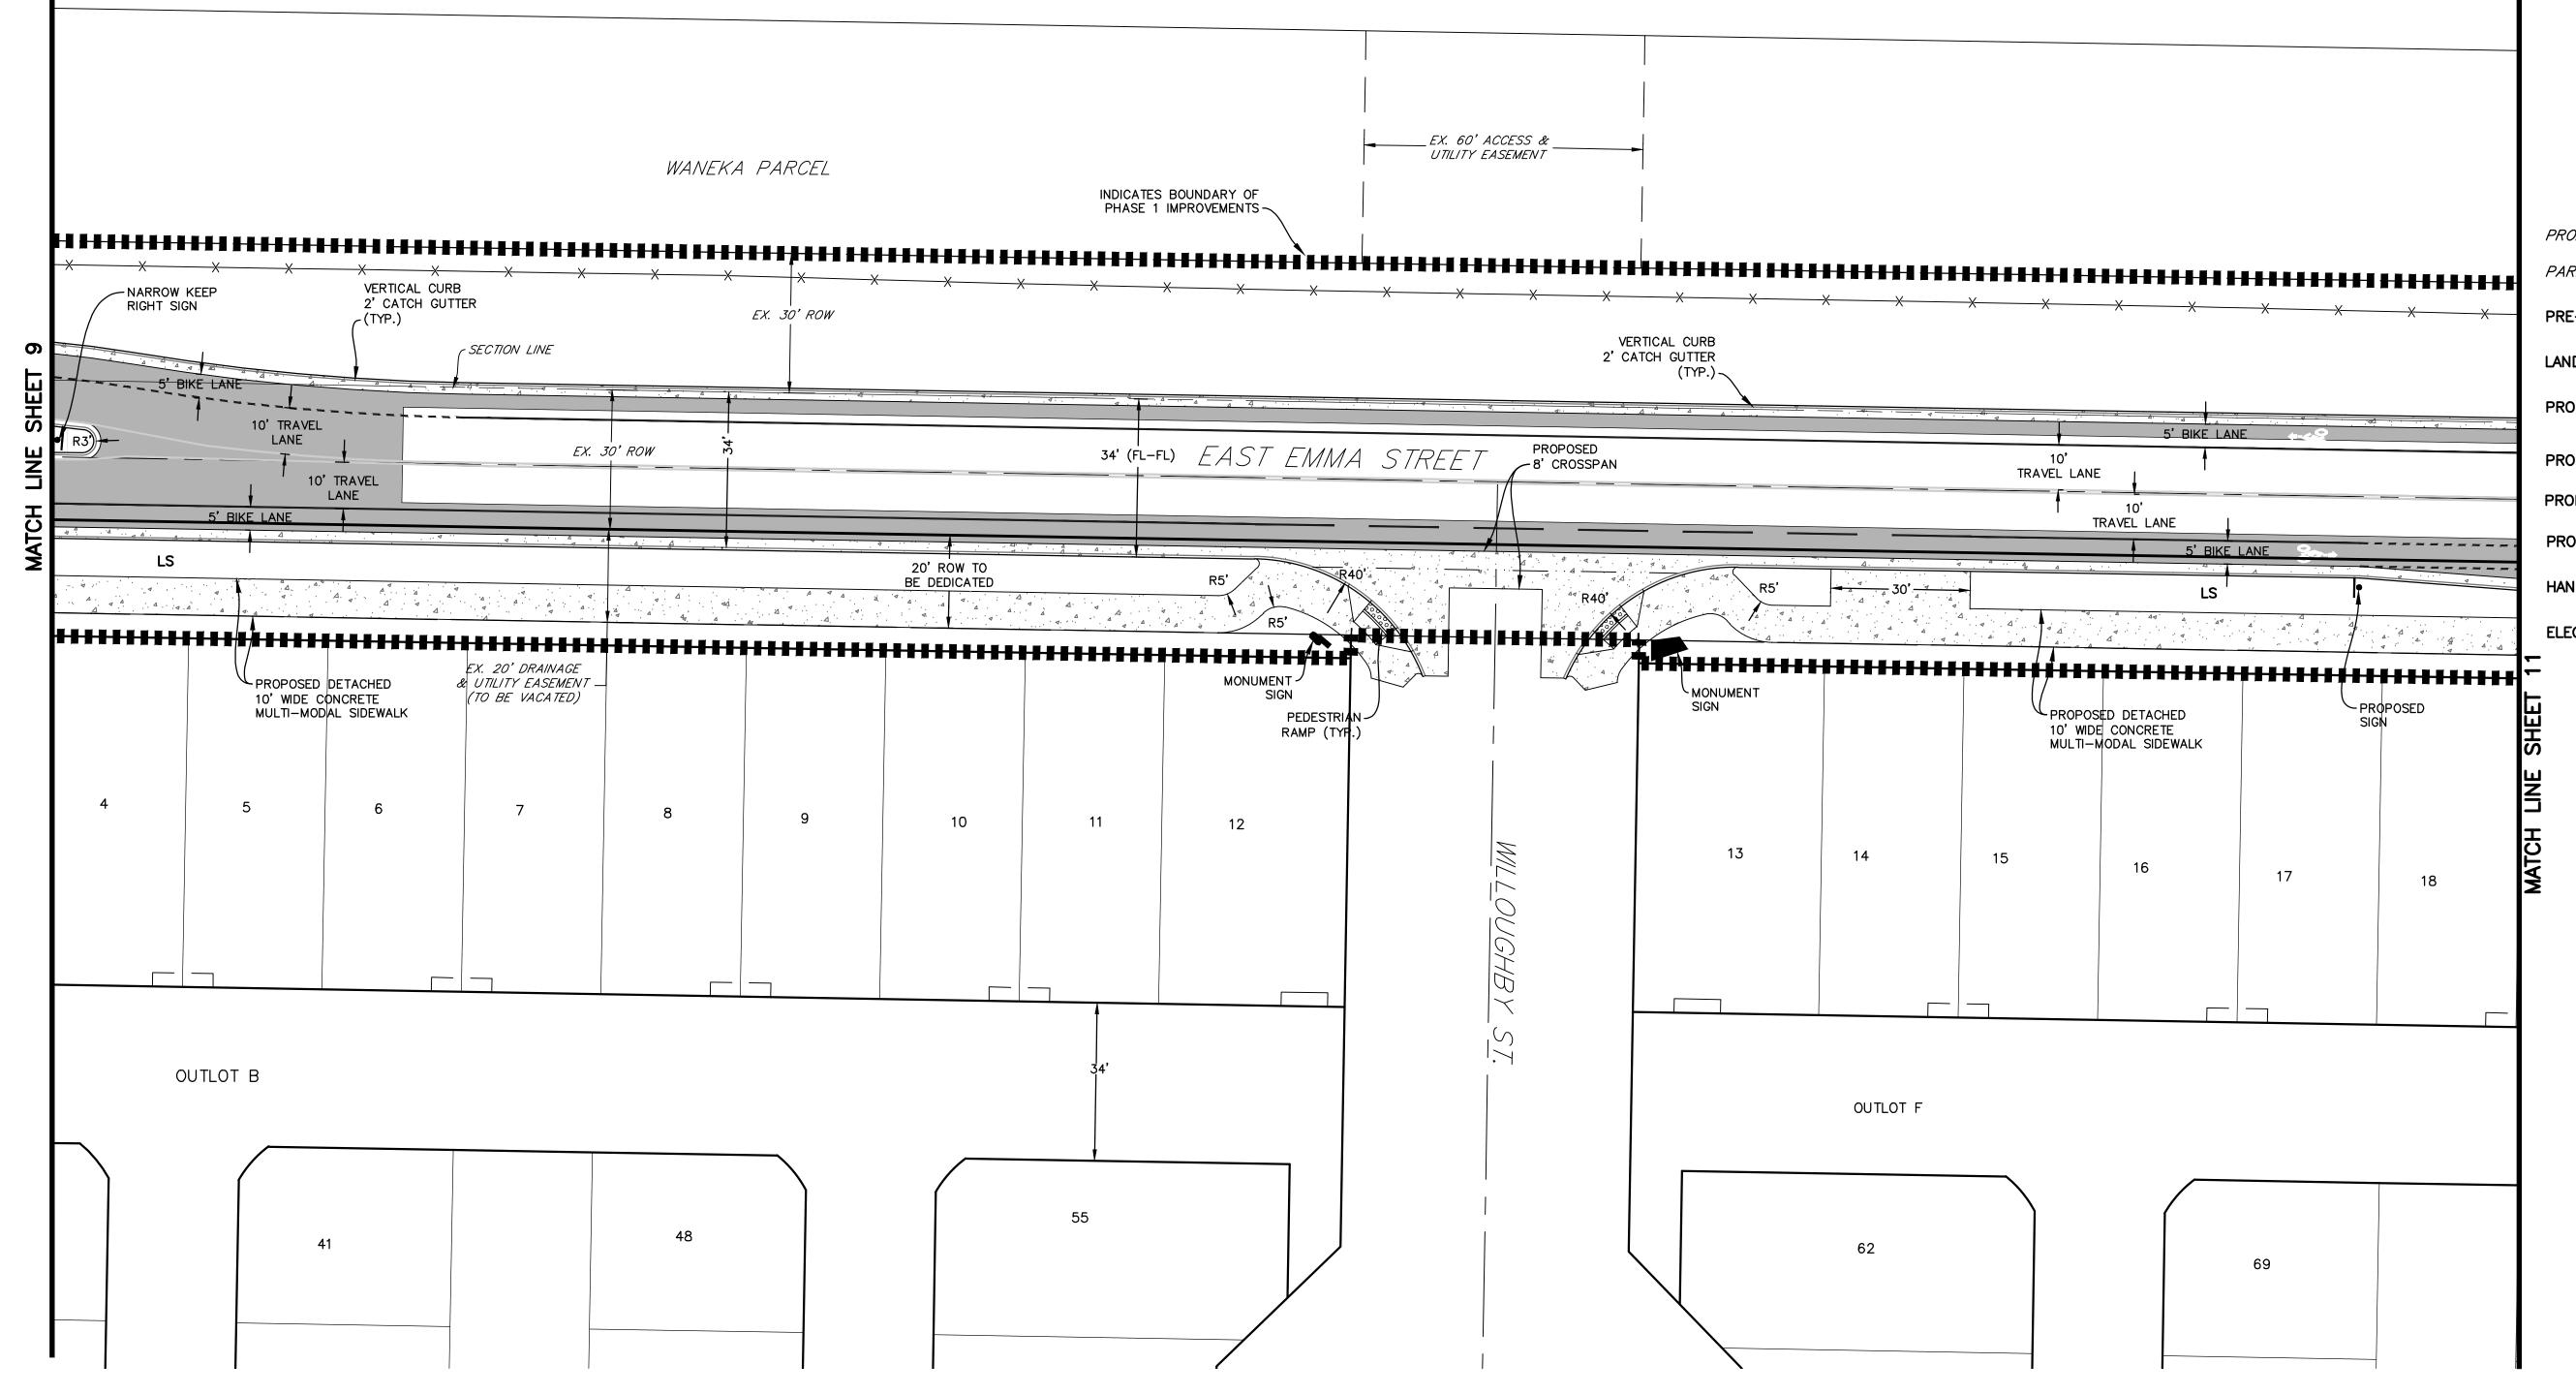
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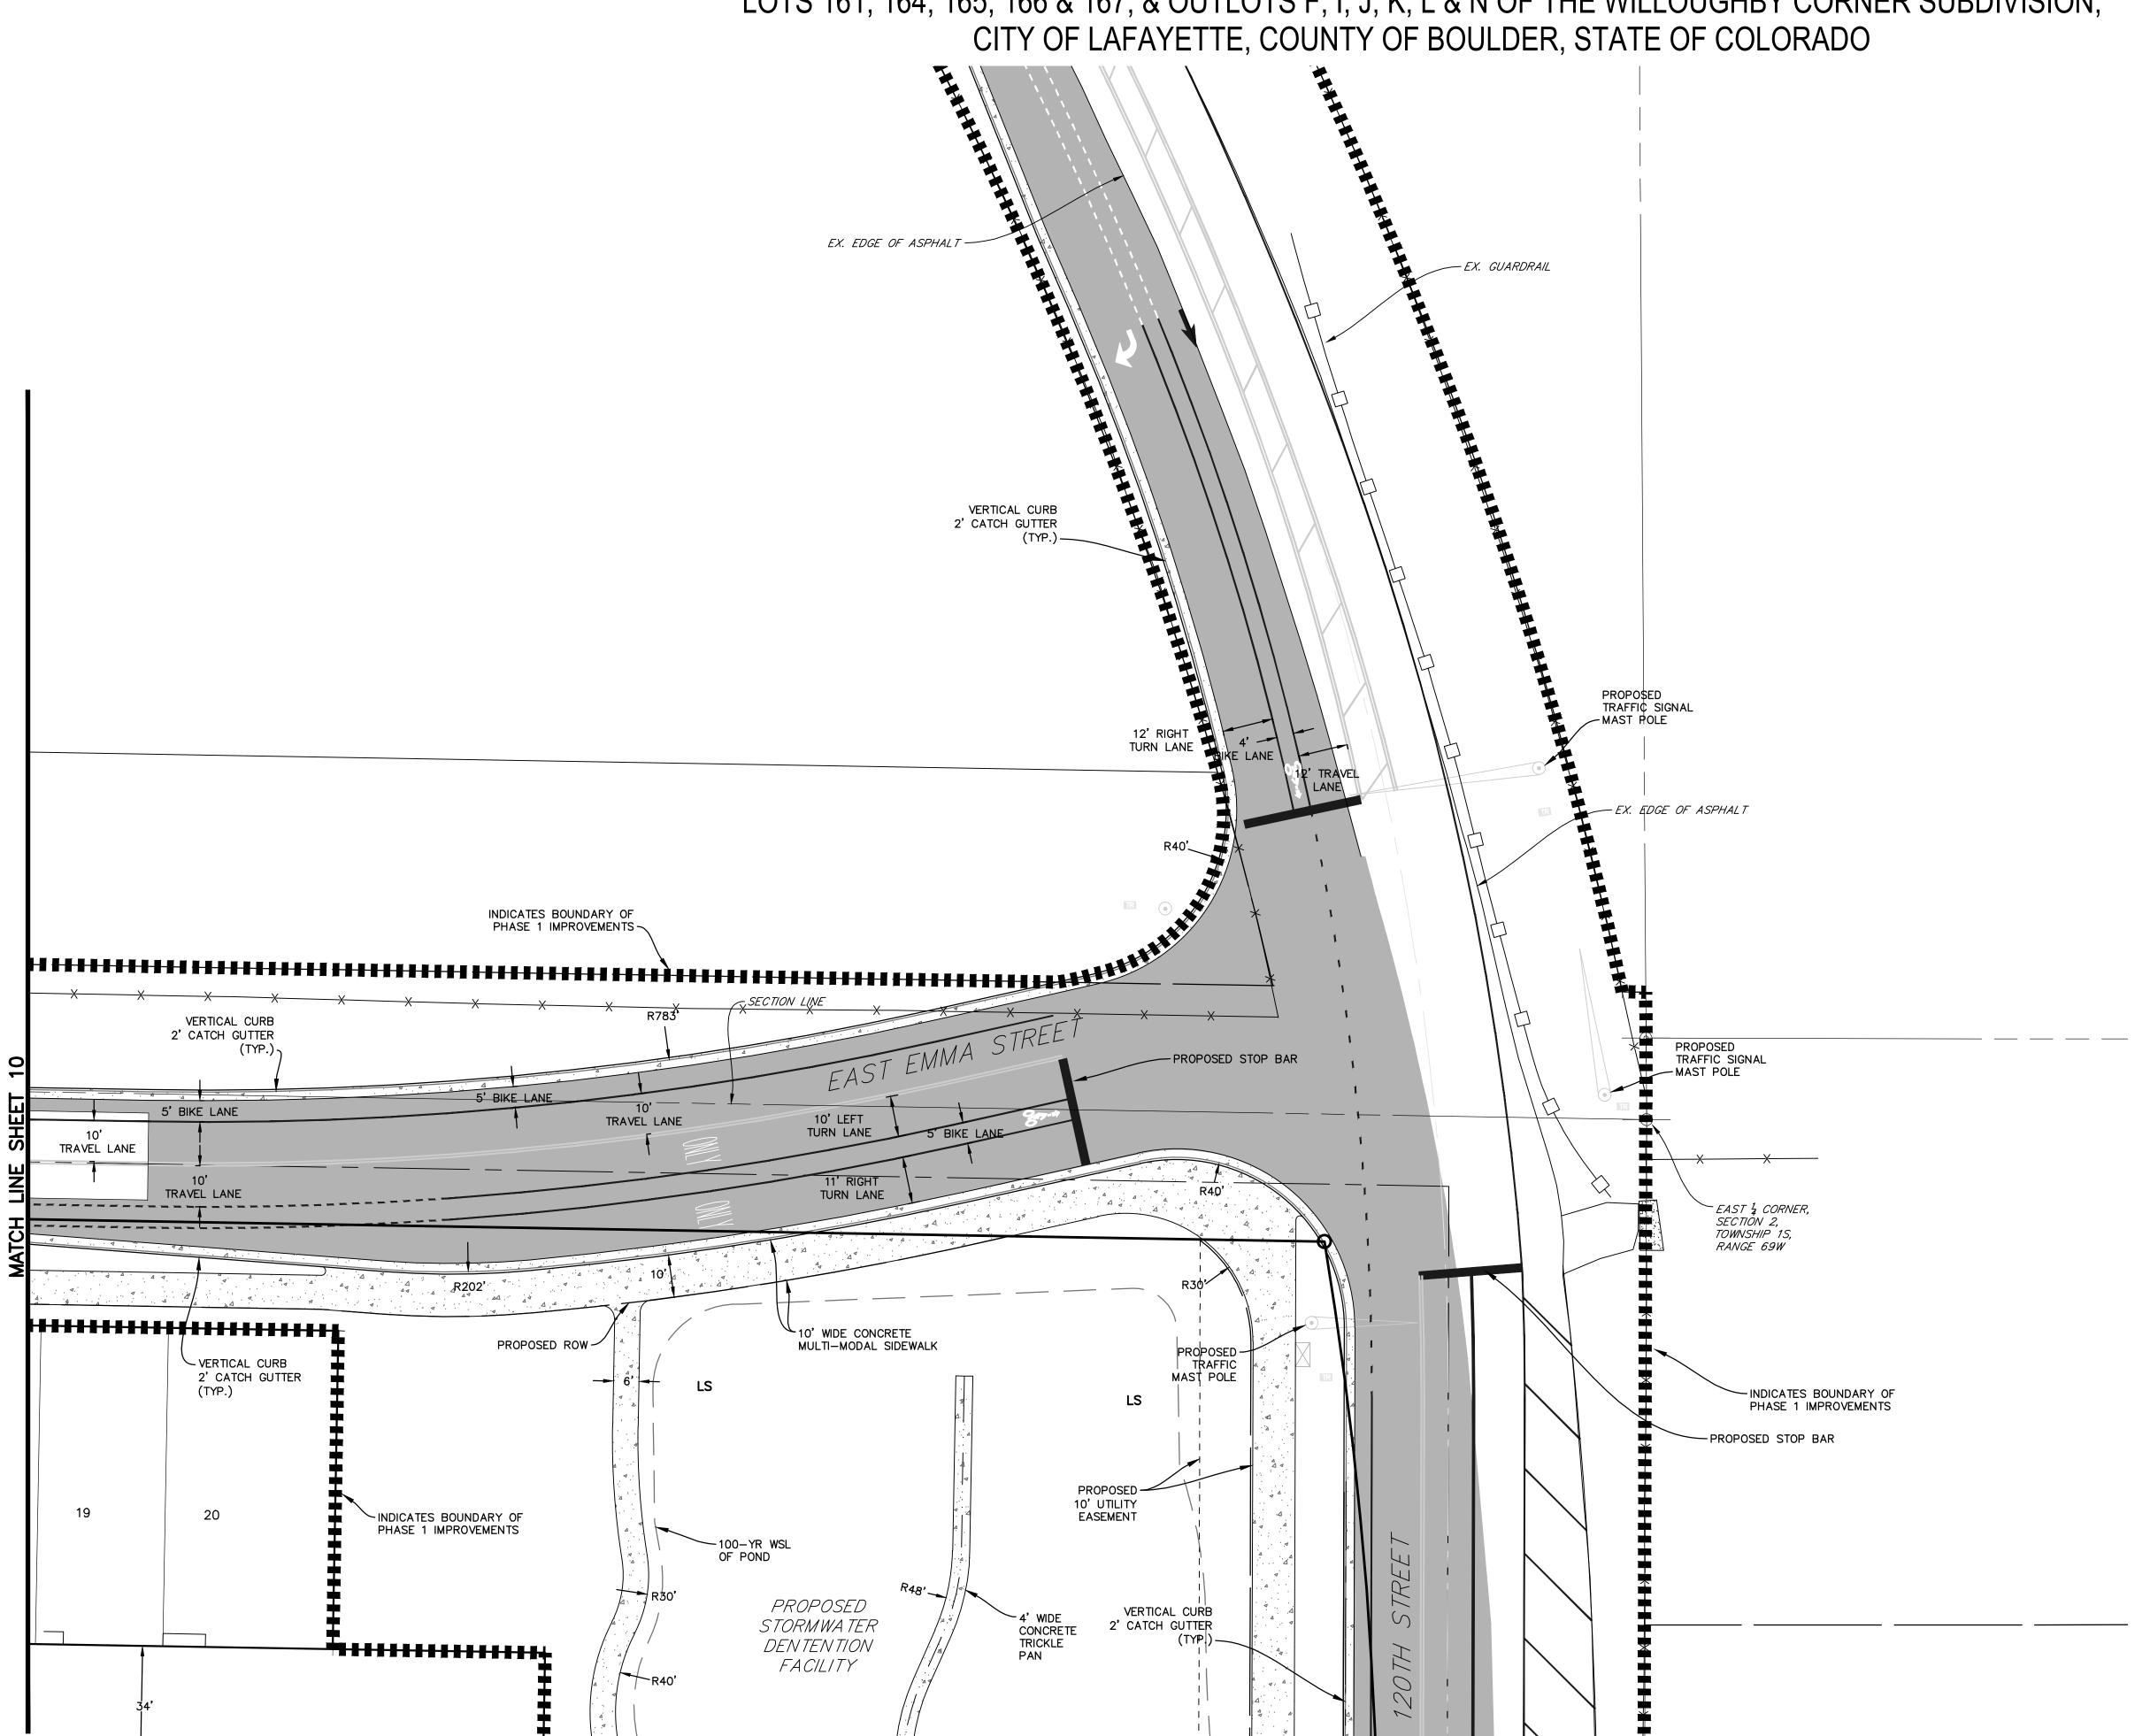
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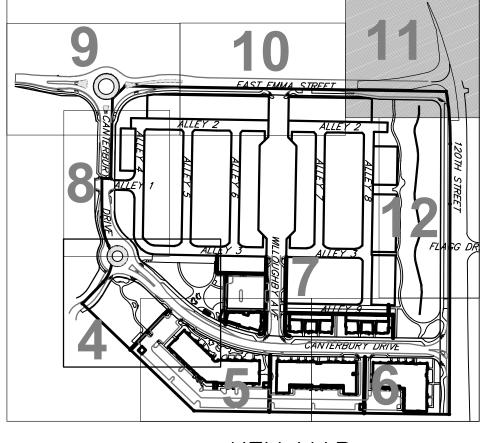
DATE: 06.17.22 - SITE PLAN 01 09.15.22 - SITE PLAN 02




LOTS 161, 164, 165, 166 & 167, & OUTLOTS F, I, J, K, L & N OF THE WILLOUGHBY CORNER SUBDIVISION,



MATCH LINE SHEET 12



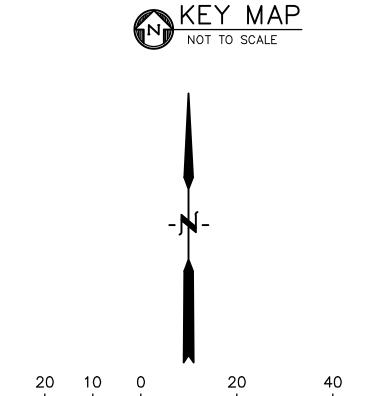

<u>LEGEND</u>

PROPERTY LINE
PARKING SPACES
PRE-WIRED EV STALLS
LANDSCAPE AREALS
PROPOSED CONCRETE
PROPOSED ASPHALT
PROPOSED SIGN
PROPOSED PHASE LINE

ELECTRIC VEHICLE PARKING SPACE

HANDICAP PARKING SPACE.

DATE: 06.17.22 - SITE PLAN 01

BOULDER COUNTY HOUSING AUTHORITY 3400 BROADWAY BOULDER, CO - 80304


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09.15.22 - SITE PLAN 02

7)))

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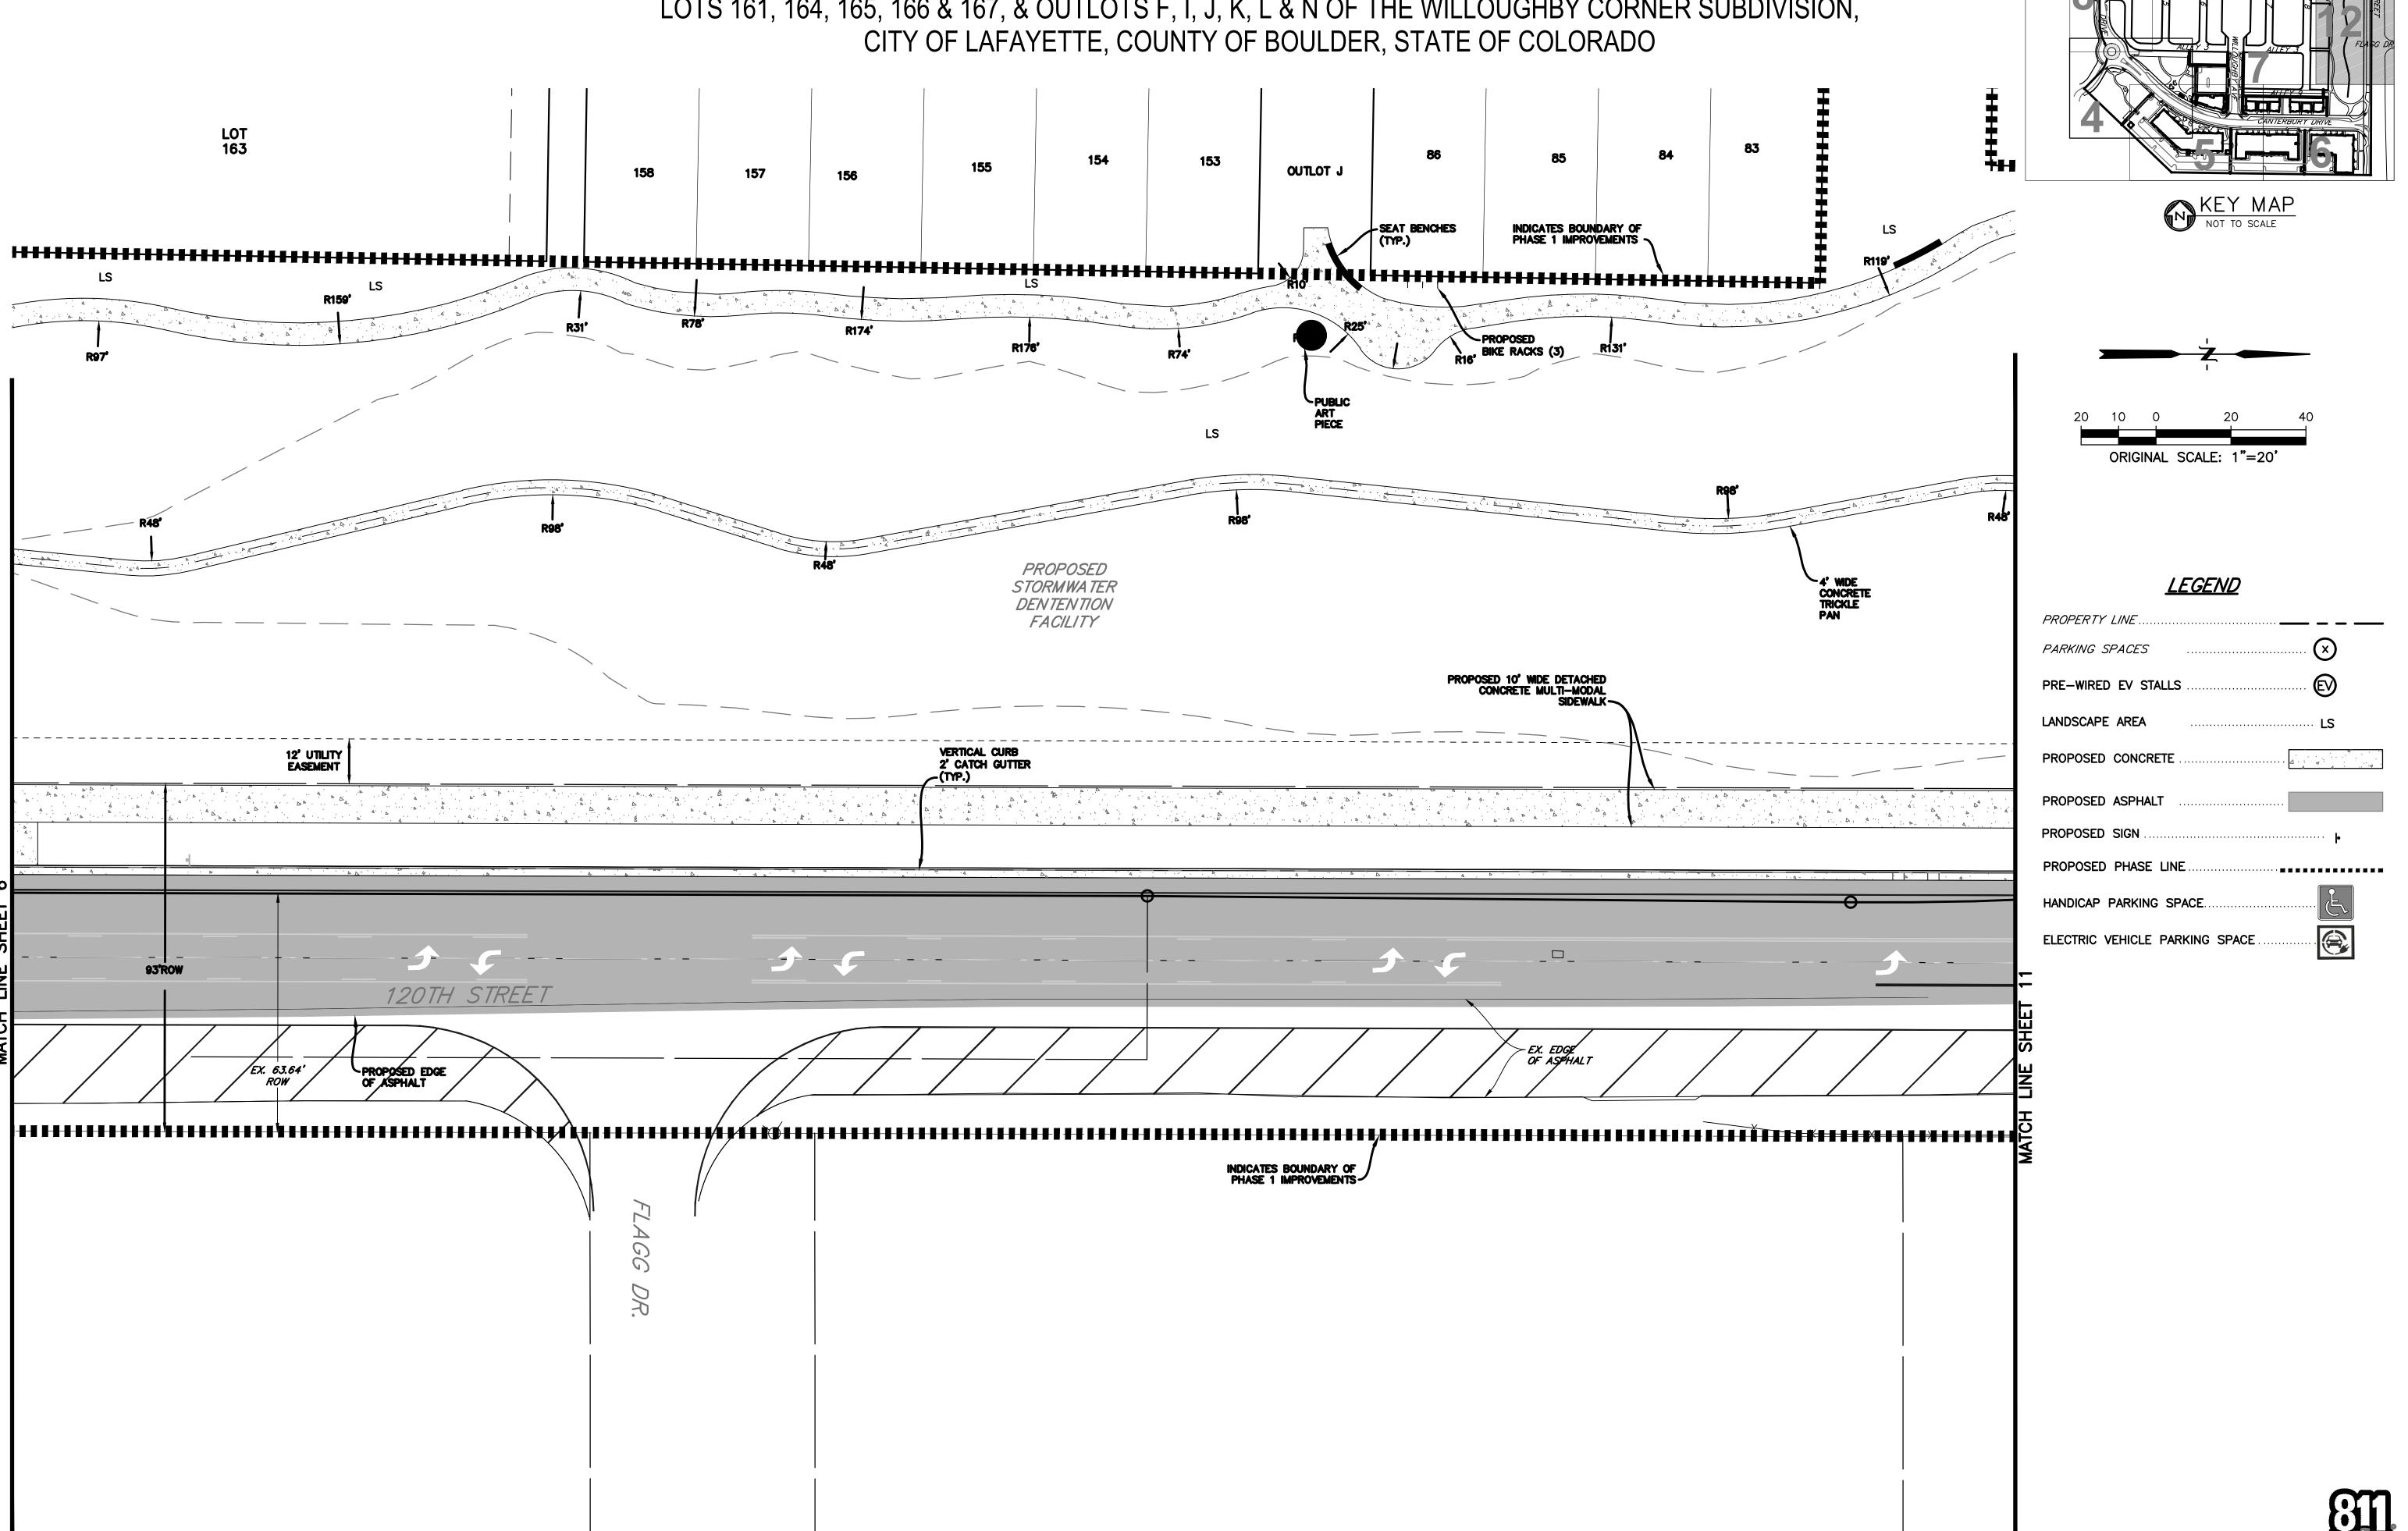


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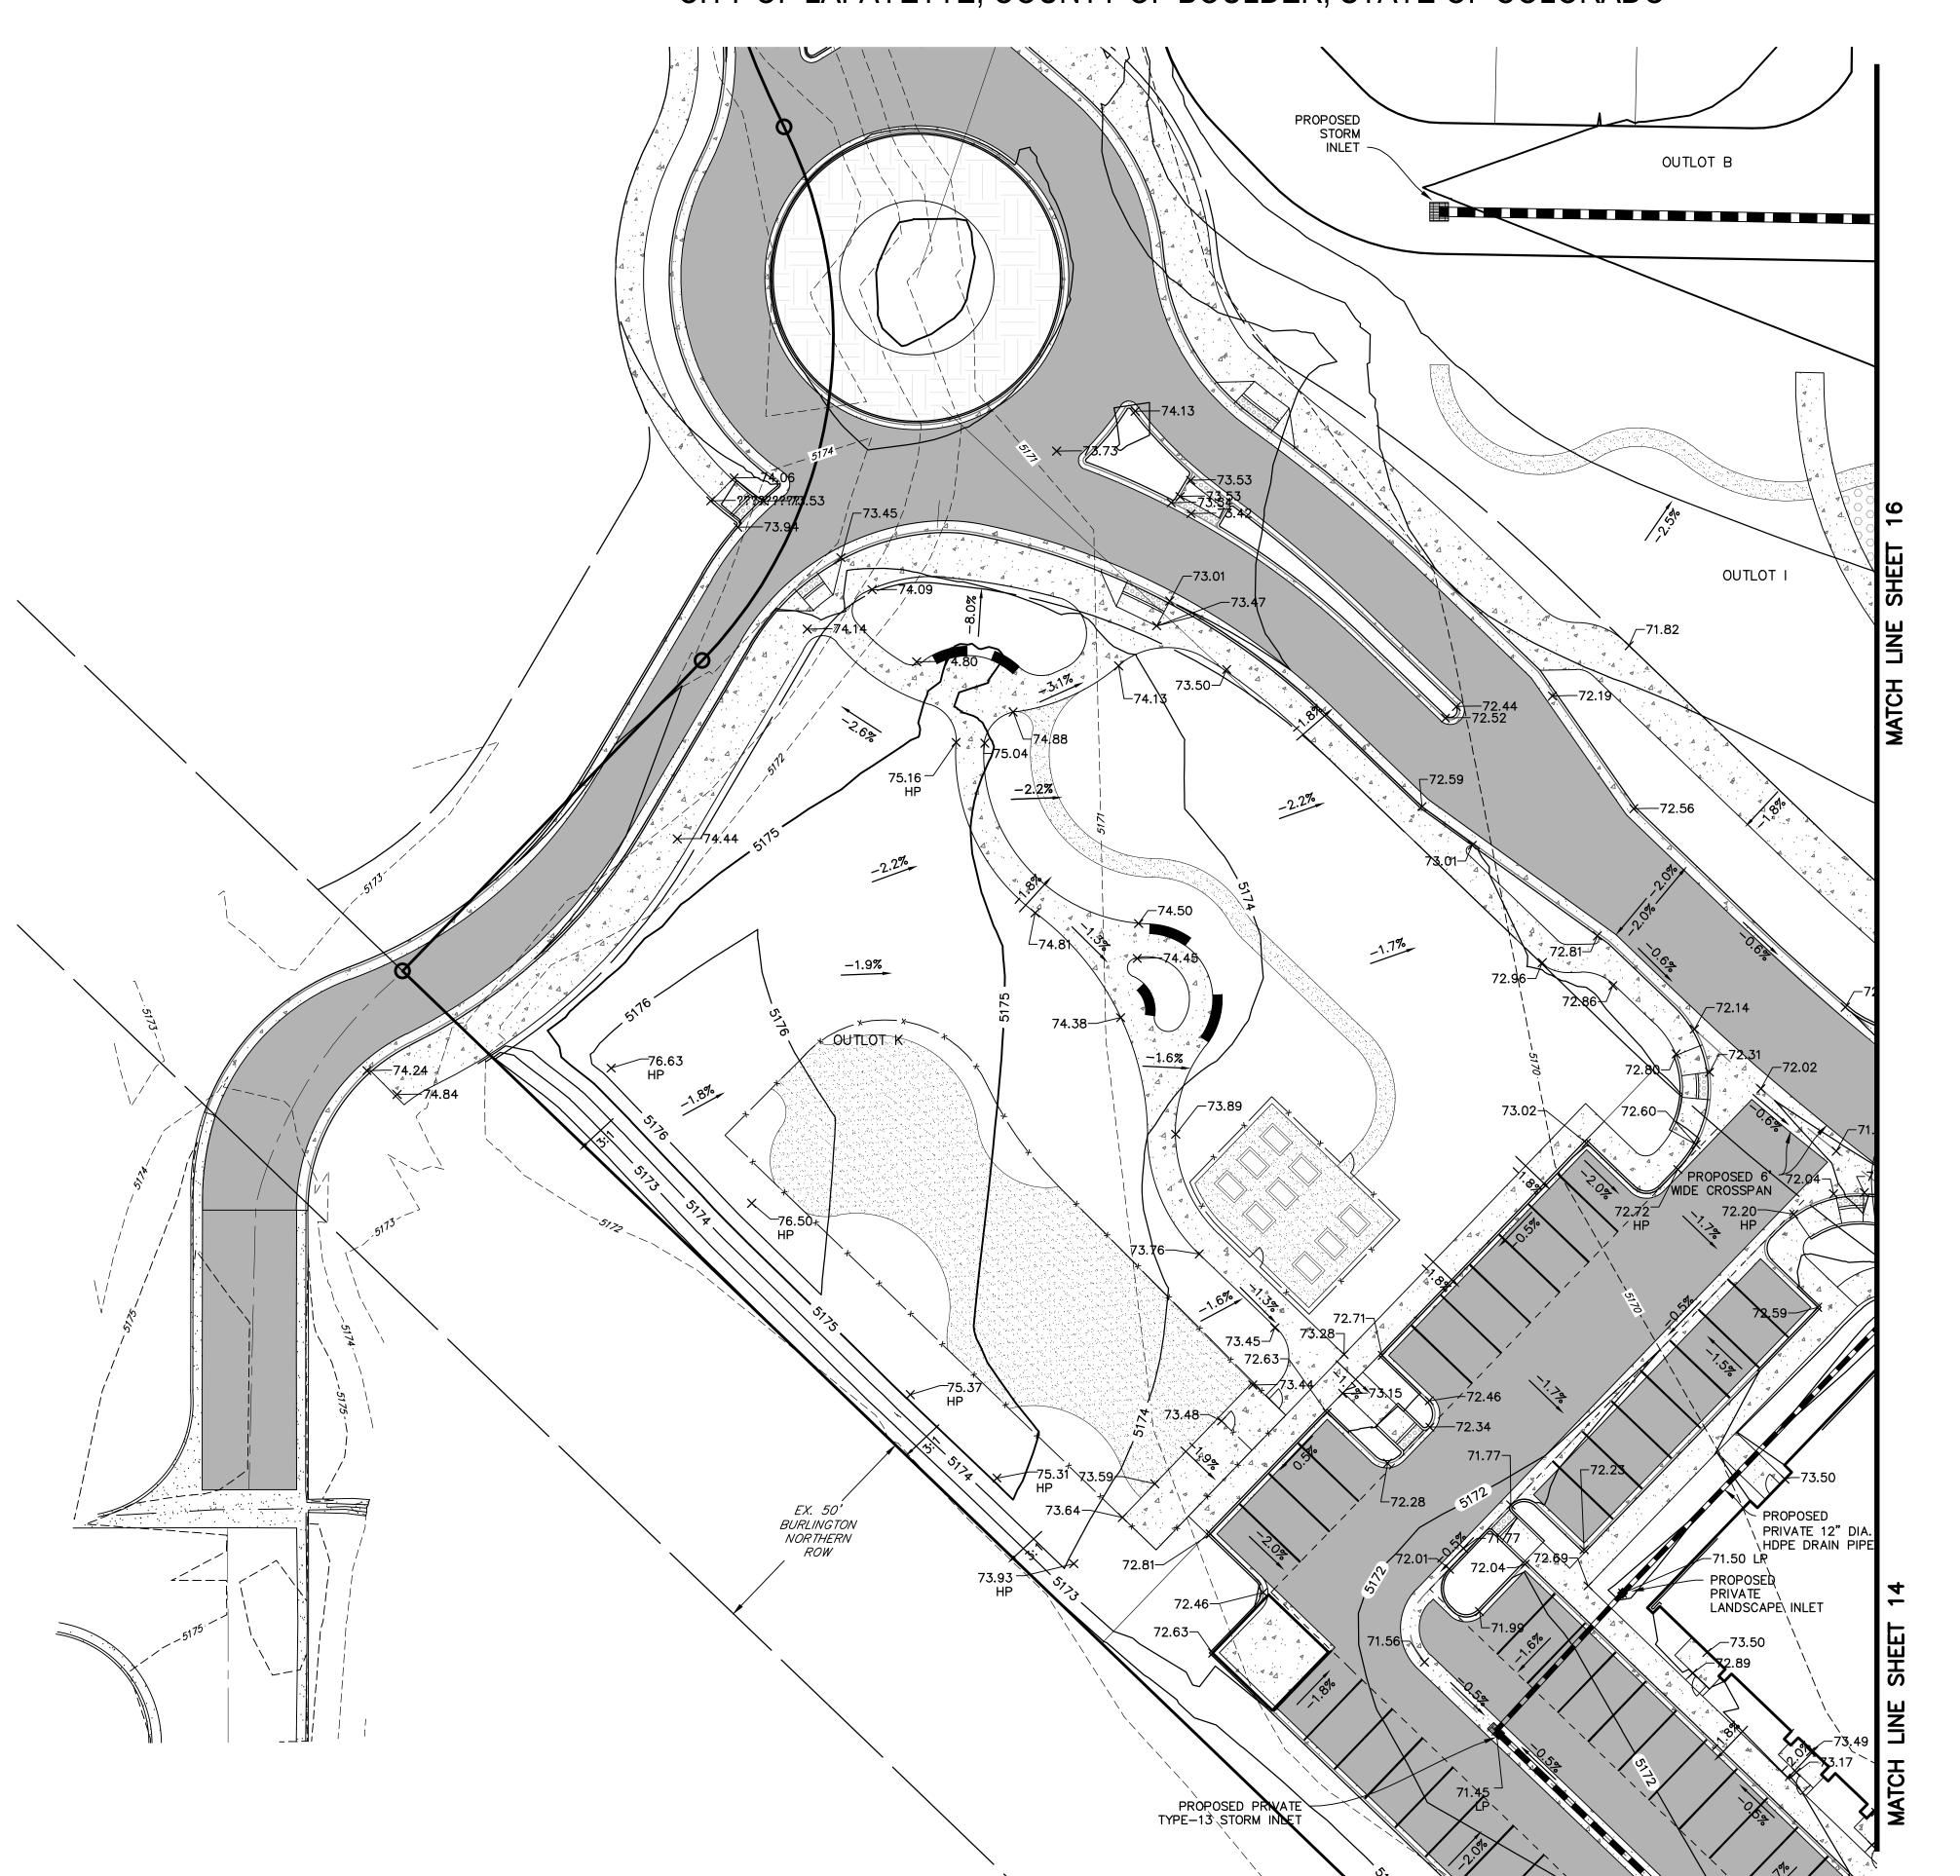
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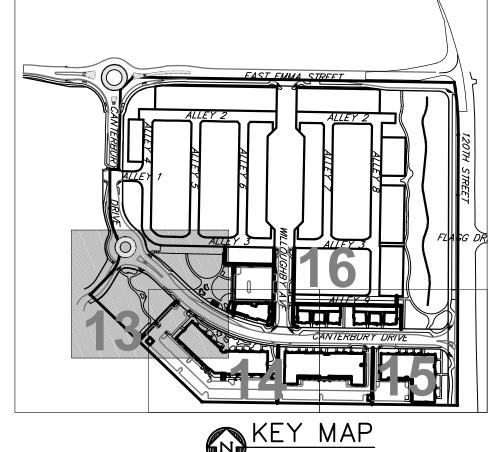
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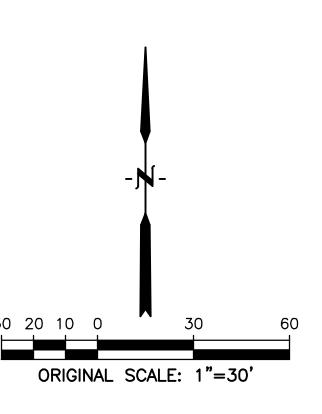
06.17.22 - SITE PLAN 01 09.15.22 - SITE PLAN 02

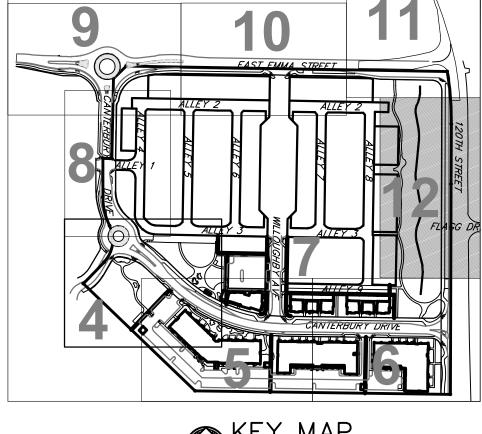

LOTS 161, 164, 165, 166 & 167, & OUTLOTS F, I, J, K, L & N OF THE WILLOUGHBY CORNER SUBDIVISION, CITY OF LAFAYETTE, COUNTY OF BOULDER, STATE OF COLORADO







<u>LEGEND</u>

PROPOSED ROW	1 65
PROPOSED LOT LINE EX. INTERMEDIATE CONTOUR5164 EX. INDEX CONTOUR5164 EX. STORM LINE516 PROPOSED INTERMEDIATE CONTOUR -516	1 65
EX. INTERMEDIATE CONTOUR5164 EX. INDEX CONTOUR5164 EX. STORM LINE516 PROPOSED INTERMEDIATE CONTOUR -516	1 65
EX. INDEX CONTOUR st EX. STORM LINE st PROPOSED INTERMEDIATE CONTOUR 516	55
PROPOSED INTERMEDIATE CONTOUR 516	
PROPOSED INTERMEDIATE CONTOUR 516	
• , •	
PROPOSED INDEX CONTOUR516	34
	35——
FLOWLINE OF DRAINAGE SWALE	
PROPOSED MANHOLE	
PROPOSED STORM INLET	
PROPOSED STORM SEWER	
AREA INUNDATED IN 100-YR STORM	
PROPOSED CONCRETE	³ A A 4
PROPOSED ASPHALT	
EX. CONCRETE	A'
GRADE BREAK G	В
HIGH POINT	Р
LOW POINT	ɔ
FLOWLINE FI	_
TOP OF CURB	3
FINISHED FLOOR FI	.
EX. SPOT ELEVATIONS	.5156.23±
	5156.23

NOTE:

1. ADD 5100 TO ALL SPOT ELEVATIONS

1. REFER TO WILLOUGHBY CORNER SUBDIVISION CONSTRUCTION PLANS FOR GRADING INFORMATION REGARDING STREETS, ROUNDABOUTS, STORM SEWER, AND THE STORMWATER DETENTION FACILITY.



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WILLOUGHBY CORNE SITE PLAN- PHASE 1

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CONTACT: MOLLY CHIANG

DATE: 06.17.22 - SITE PLAN 01 09.15.22 - SITE PLAN 02


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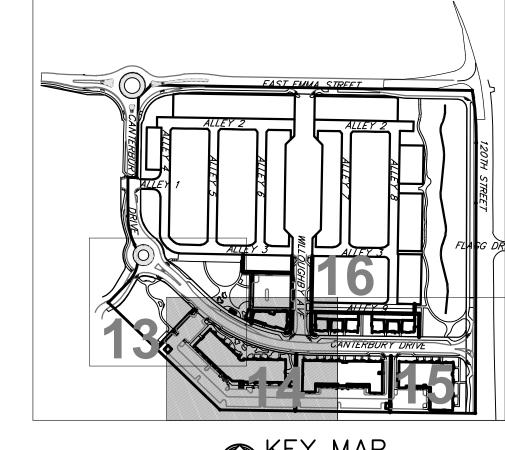
GRADING PLAN 1


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ECKED BY:

LOTS 161, 164, 165, 166 & 167, & OUTLOTS F, I, J, K, L & N OF THE WILLOUGHBY CORNER SUBDIVISION, CITY OF LAFAYETTE, COUNTY OF BOULDER, STATE OF COLORADO





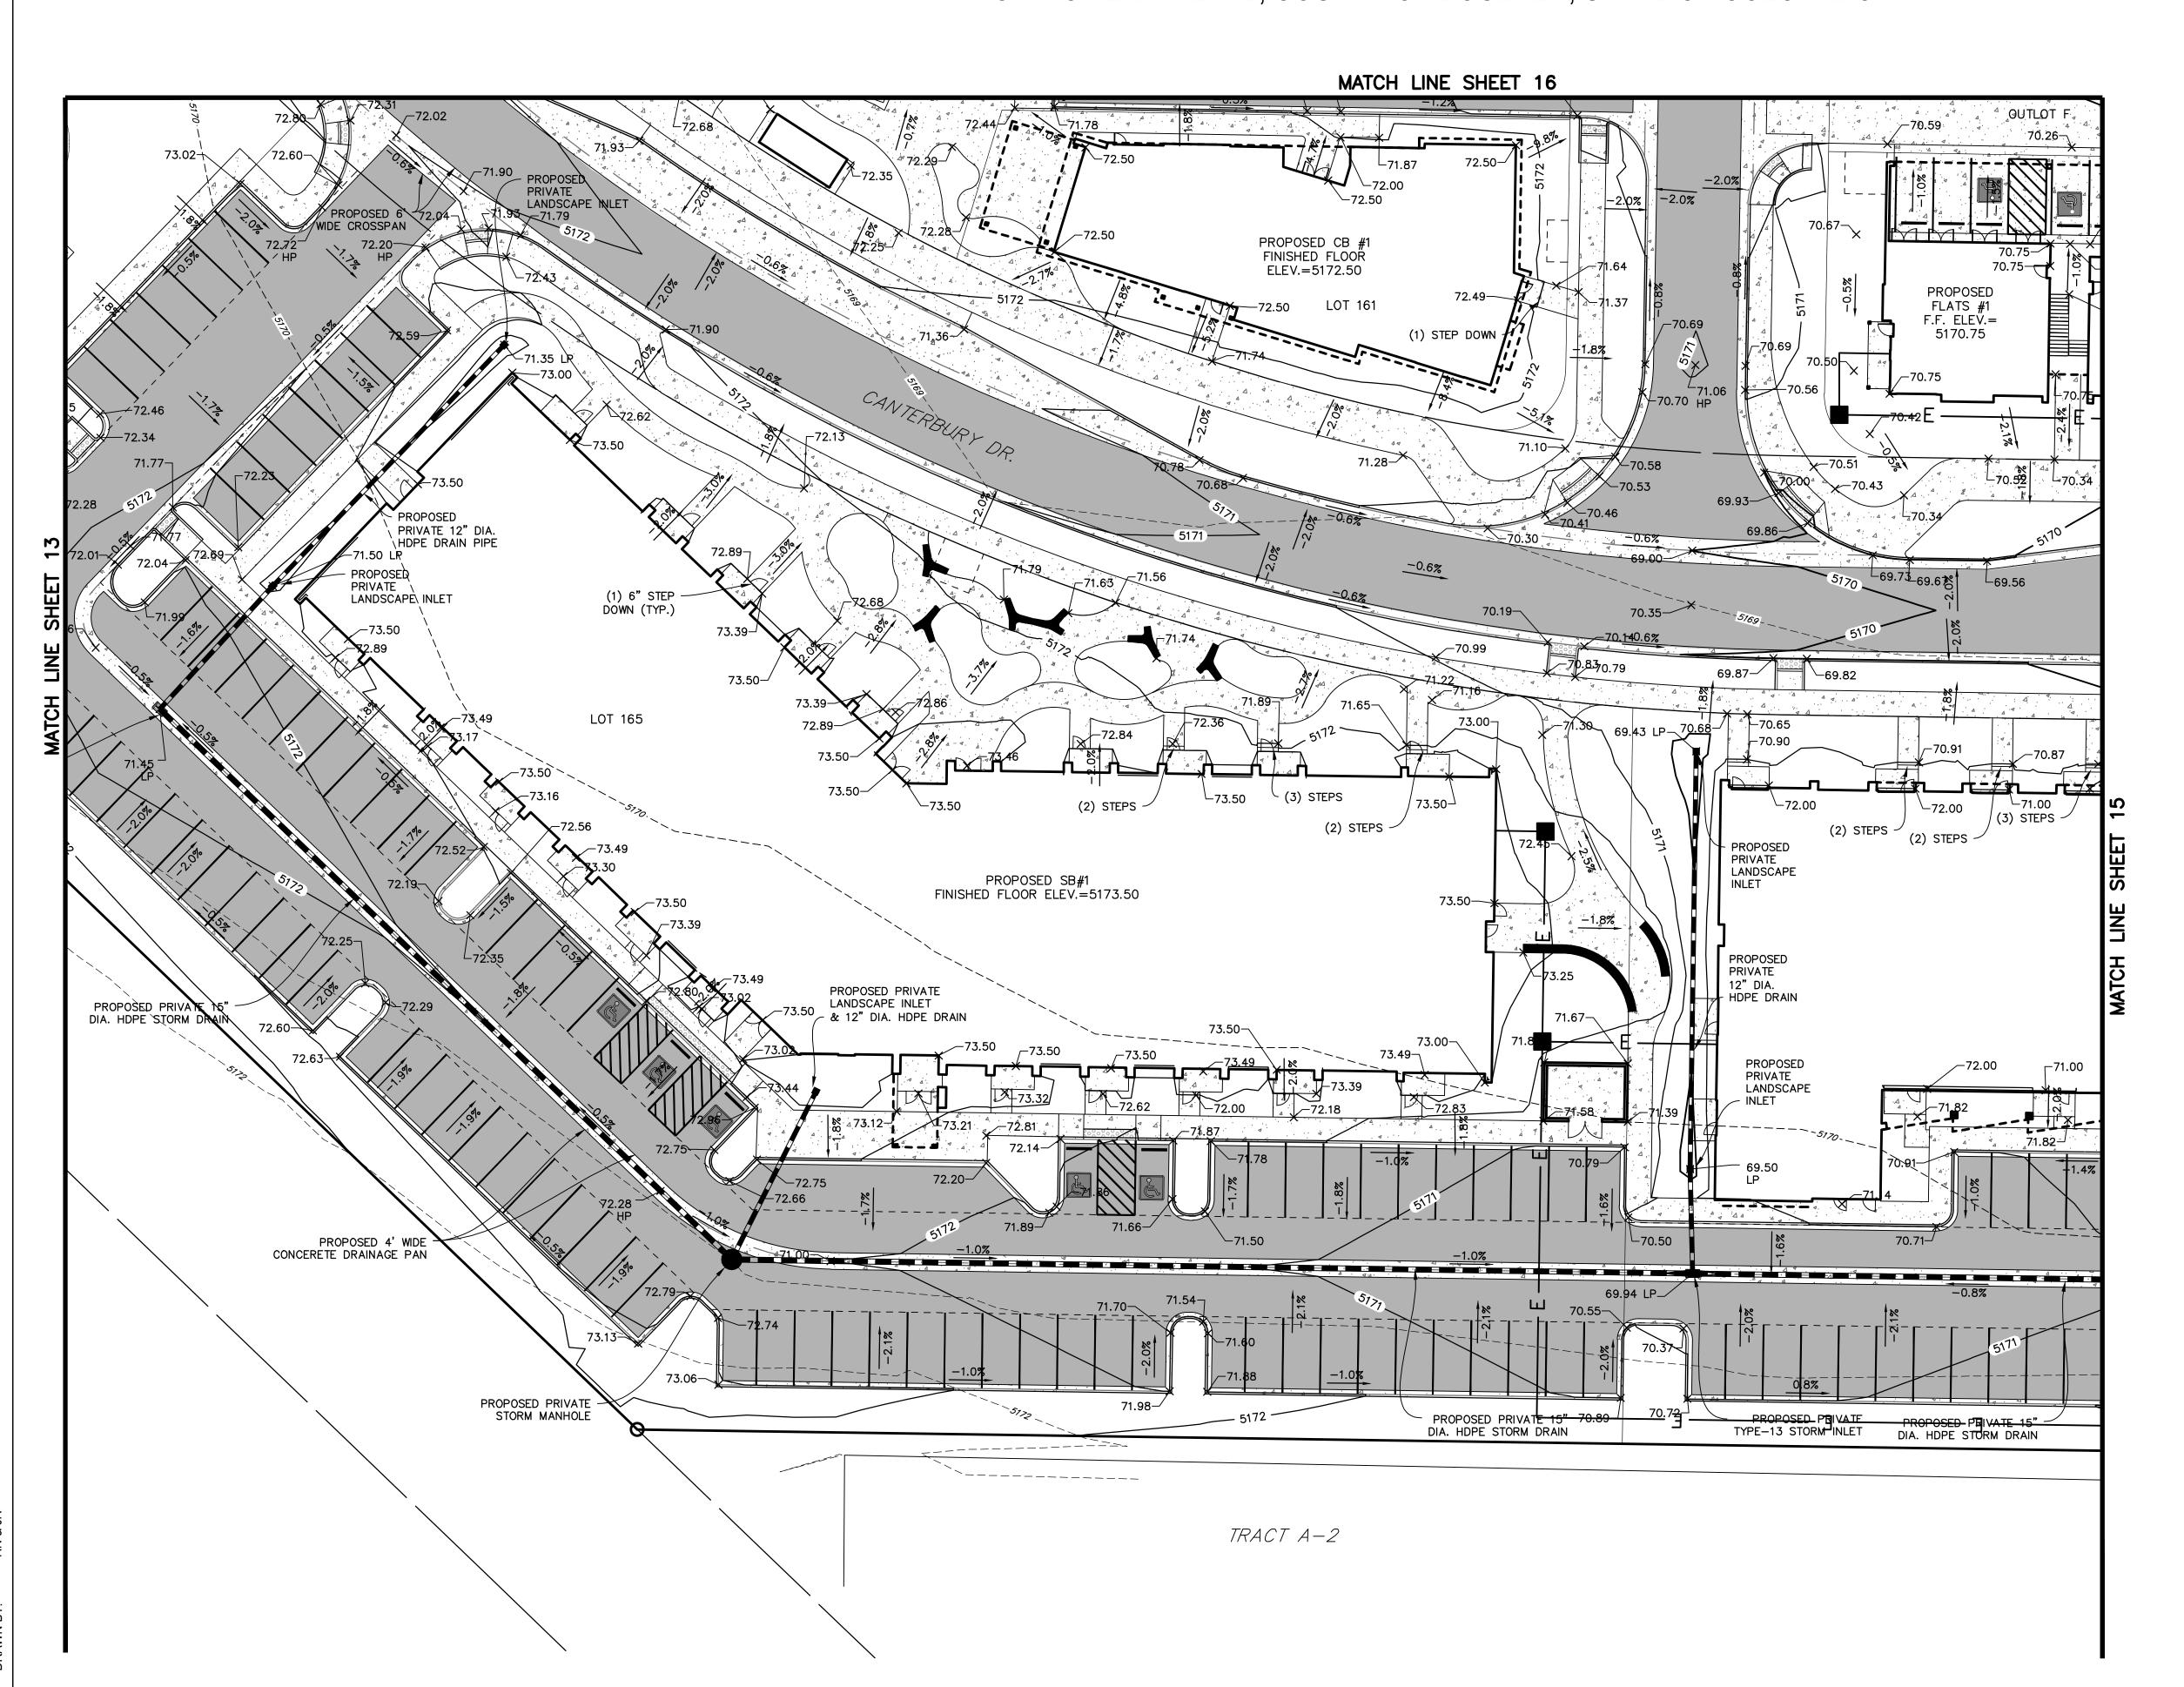
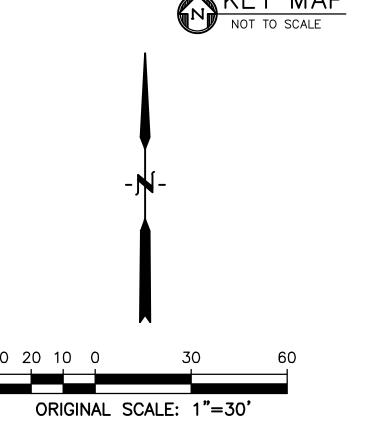
<u>LEGEND</u>

TNOTENTT	<i>`LINE</i>	······ — -	
	ROW		
PROPOSED	LOT LINE		
EX. INTERN	MEDIATE CONTOUR		164
EX. INDEX	CONTOUR		5165
EX. STORN	1 LINE		- ST ———
PROPOSED	INTERMEDIATE CONT	OUR 5	5164
PROPOSED	INDEX CONTOUR		5165
FLOWLINE	OF DRAINAGE SWALE		
PROPOSED	MANHOLE		•
PROPOSED	STORM INLET		
PROPOSED	STORM SEWER		
AREA INUN	DATED IN 100-YR S	STORM	
PROPOSED	CONCRETE		4. 4.
PROPOSED	ASPHALT		
EX. CONC	<i>RETE</i>	Δ	Δ ₄ Δ' ;
GRADE BR	EAK		GB
HIGH POIN	Τ		HP
LOW POINT	Г		LP
FLOWLINE .			FL
TOP OF C	URB		TC
FINISHED I	FLOOR		FF
EX. SPOT	ELE VA TIONS		× ^{5156.23}
PROPOSED	SPOT ELEVATION		× ^{5156.23}

1 4

1. ADD 5100 TO ALL SPOT ELEVATIONS

NOTE:

1. REFER TO WILLOUGHBY CORNER SUBDIVISION CONSTRUCTION PLANS FOR GRADING INFORMATION REGARDING STREETS, ROUNDABOUTS, STORM SEWER, AND THE STORMWATER DETENTION FACILITY.



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WILLOUGHBY CORNEF


OWNER:
BOULDER COUNTY HOUSING
AUTHORITY
3400 BROADWAY
BOULDER, CO - 80304
303.441.3861


CONTACT: MOLLY CHIANG

DATE: 06.17.22 - SITE PLAN 01 09.15.22 - SITE PLAN 02


SHEET TITLE: GRADING PLAN 2

LOTS 161, 164, 165, 166 & 167, & OUTLOTS F, I, J, K, L & N OF THE WILLOUGHBY CORNER SUBDIVISION, CITY OF LAFAYETTE, COUNTY OF BOULDER, STATE OF COLORADO

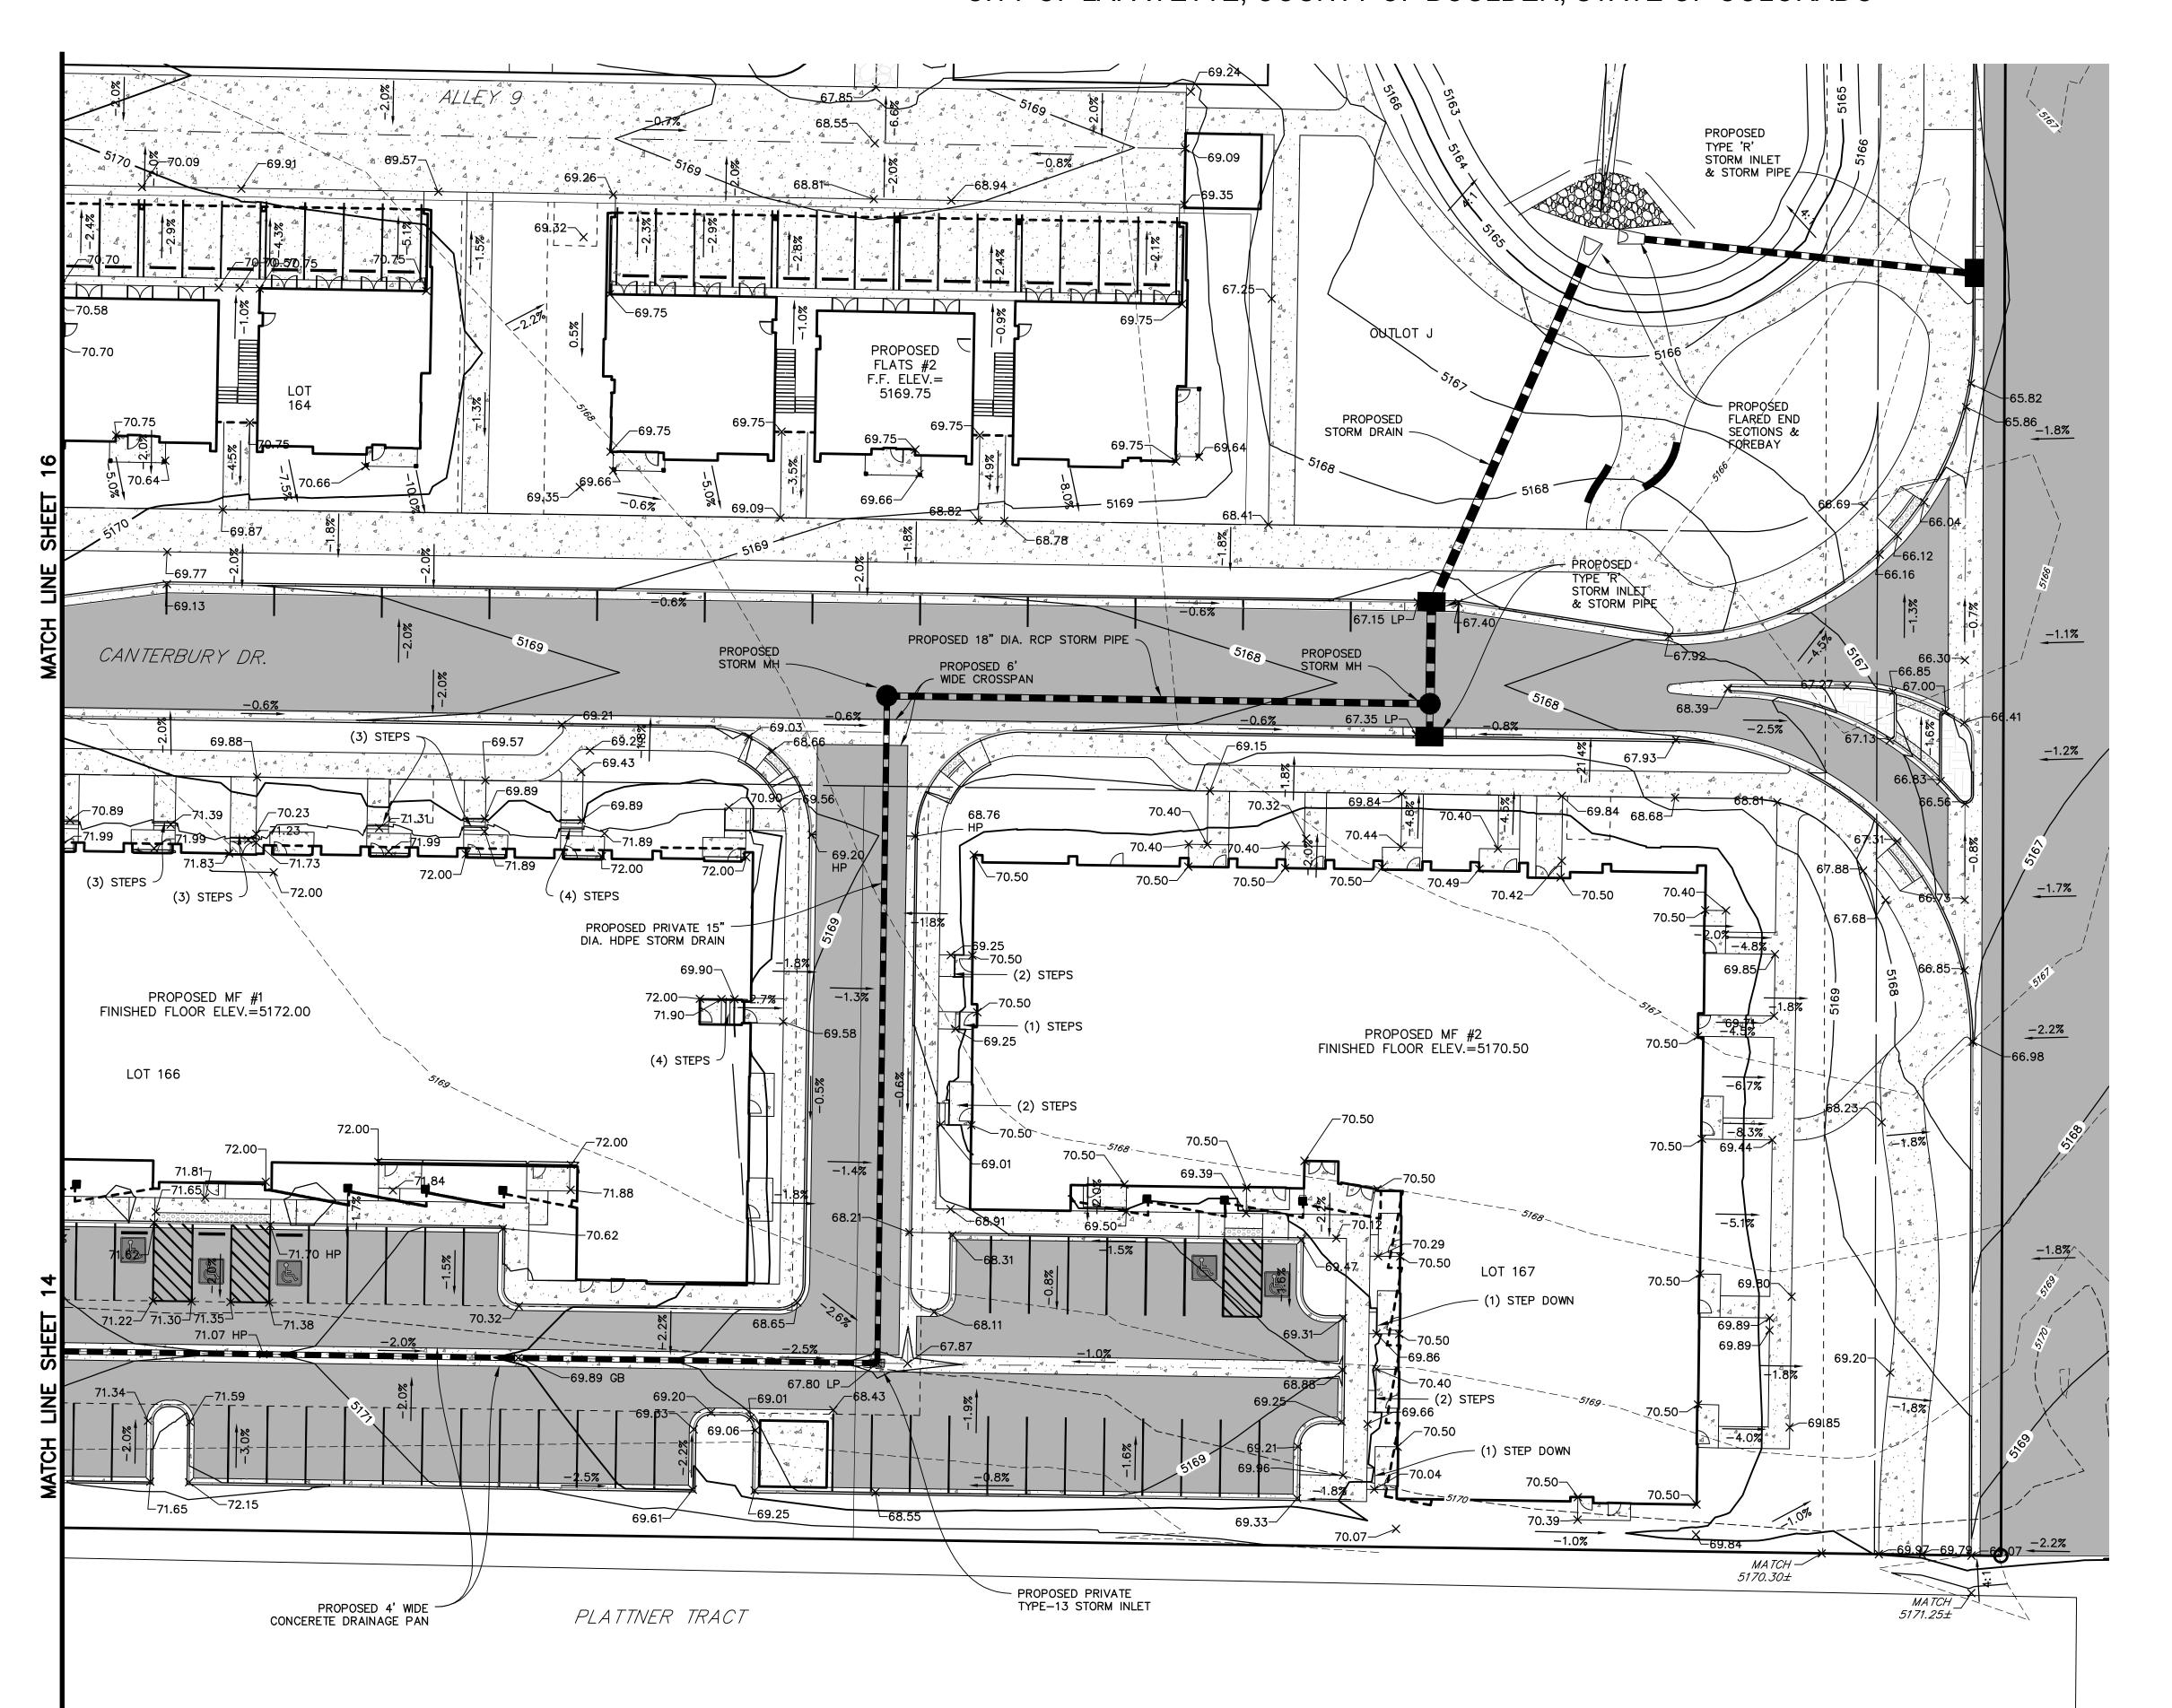

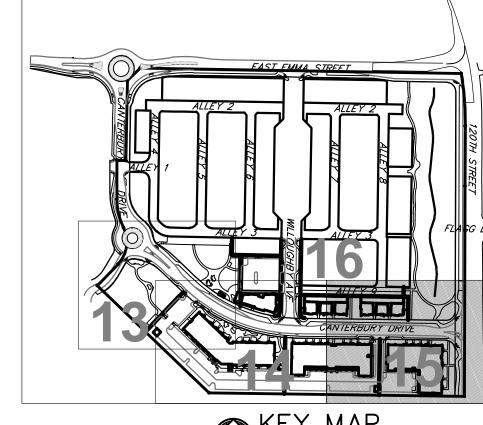



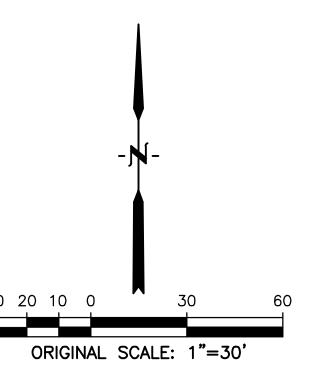

<u>LEGEND</u>

PROPERTY LINE	
PROPOSED ROW	
PROPOSED LOT LINE	
EX. INTERMEDIATE CONTOUR	-5164
EX. INDEX CONTOUR	5165
EX. STORM LINE	st
PROPOSED INTERMEDIATE CONTOUR	-5164
PROPOSED INDEX CONTOUR	-5165
FLOWLINE OF DRAINAGE SWALE	
PROPOSED MANHOLE	
PROPOSED STORM INLET	
PROPOSED STORM SEWER	
AREA INUNDATED IN 100-YR STORM	
PROPOSED CONCRETE	A 4 <u>A</u> . A.
PROPOSED ASPHALT	
EX. CONCRETE	Δ ₄ Δ
GRADE BREAK	GB
HIGH POINT	HP
LOW POINT	LP
FLOWLINE	FL
TOP OF CURB	TC
FINISHED FLOOR	FF
EX. SPOT ELEVATIONS	× ^{5156.2}
	× 5156.2

1. ADD 5100 TO ALL SPOT ELEVATIONS

NOTE:

1. REFER TO WILLOUGHBY CORNER SUBDIVISION CONSTRUCTION PLANS FOR **GRADING INFORMATION REGARDING** STREETS, ROUNDABOUTS, STORM SEWER, AND THE STORMWATER **DETENTION FACILITY.**




BOULDER COUNTY HOUSING AUTHORITY 3400 BROADWAY BOULDER, CO - 80304 303.441.3861 CONTACT: MOLLY CHIANG


DATE: 06.17.22 - SITE PLAN 01 09.15.22 - SITE PLAN 02

SHEET TITLE: **GRADING**


PLAN 2

LOTS 161, 164, 165, 166 & 167, & OUTLOTS F, I, J, K, L & N OF THE WILLOUGHBY CORNER SUBDIVISION, CITY OF LAFAYETTE, COUNTY OF BOULDER, STATE OF COLORADO

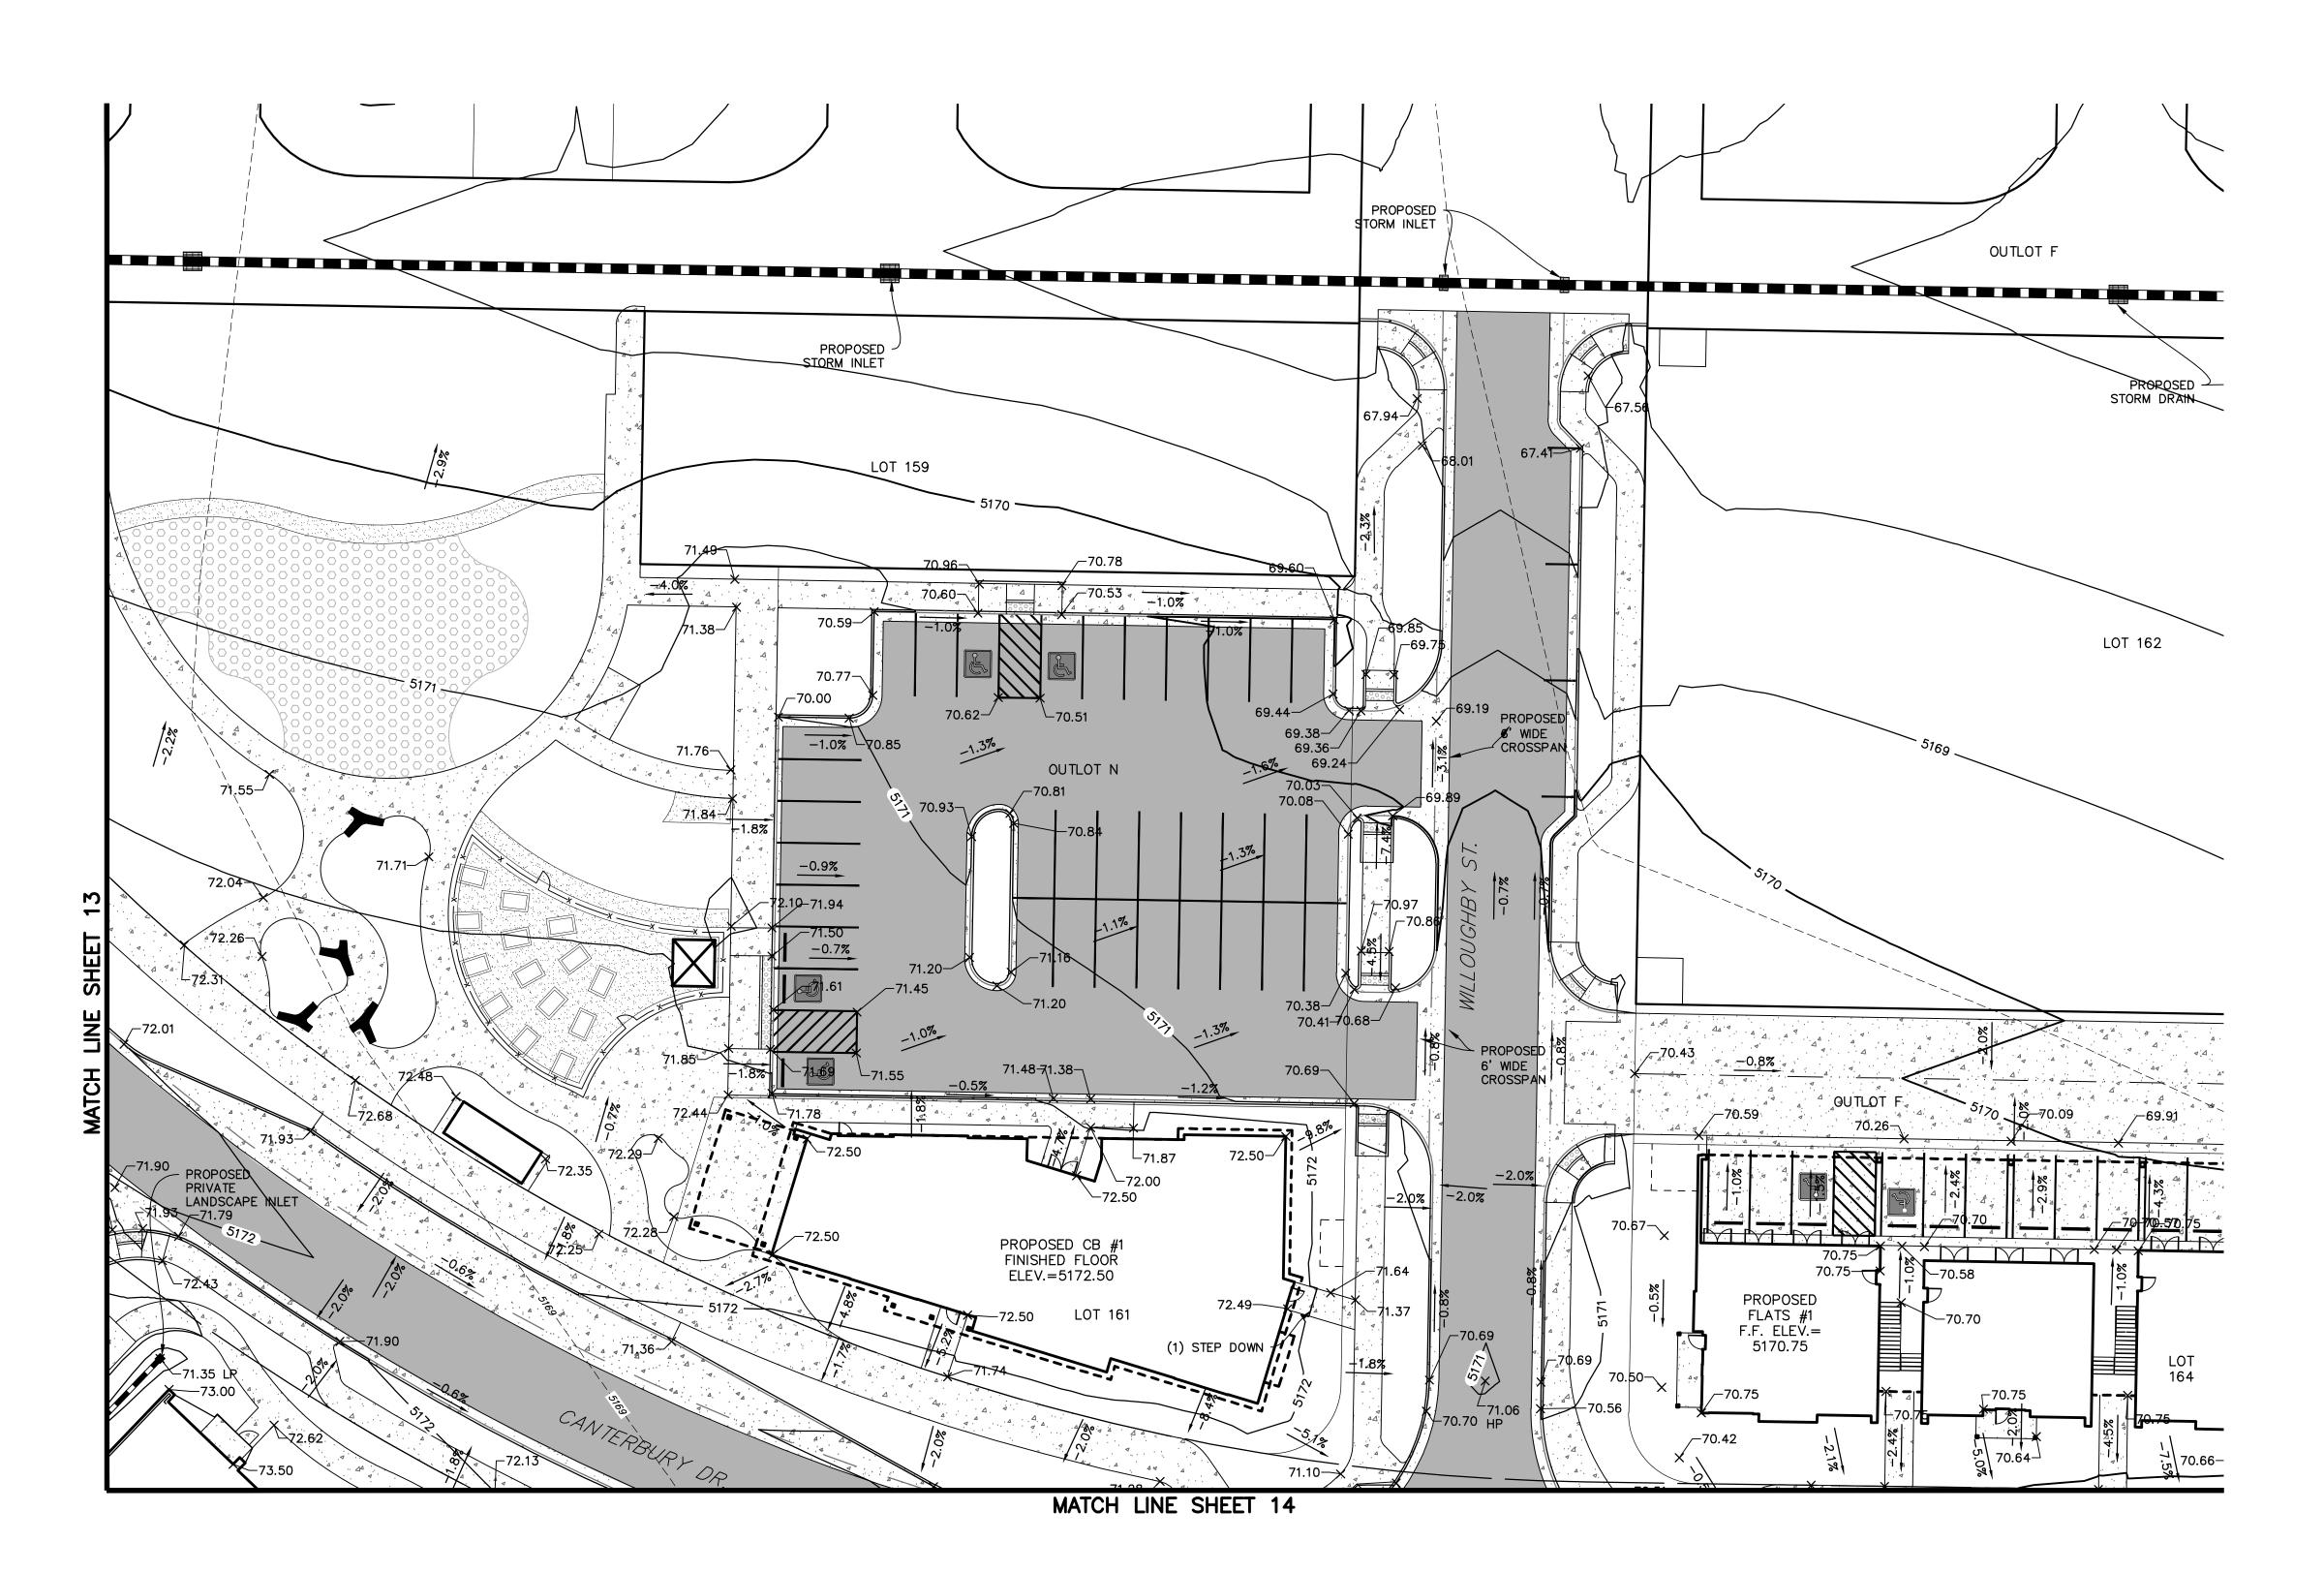

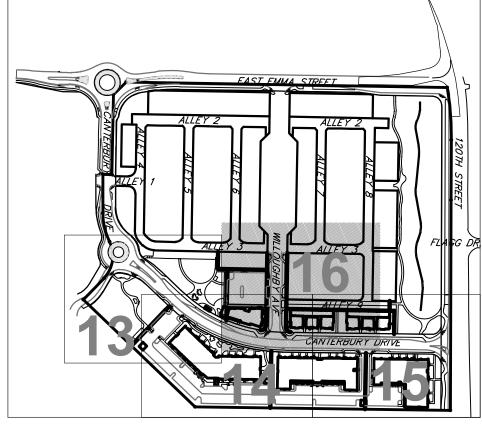



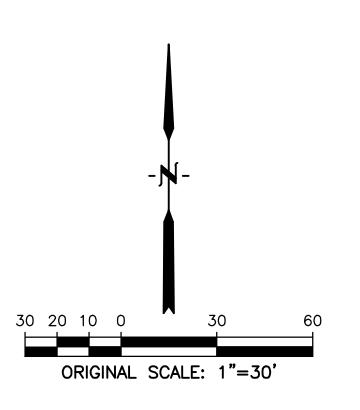

<u>LEGEND</u>


PROPOSED SPOT ELEVATION	
EX. SPOT ELEVATIONS	
TOP OF CURBFINISHED FLOOR	
FLOWLINE	
LOW POINT	
HIGH POINT	
GRADE BREAK	GB
EX. CONCRETE	Δ ₄
PROPOSED ASPHALT	
PROPOSED CONCRETE	
AREA INUNDATED IN 100-YR STORM	
PROPOSED STORM SEWER	
PROPOSED STORM INLET	
PROPOSED MANHOLE	
FLOWLINE OF DRAINAGE SWALE	
PROPOSED INDEX CONTOUR	
PROPOSED INTERMEDIATE CONTOUR	
EX. STORM LINE	ST _
EX. INDEX CONTOUR	<u>5165</u>
EX. INTERMEDIATE CONTOUR	5164-
PROPOSED LOT LINE	
PROPOSED ROW	

NOTE:

1. ADD 5100 TO ALL SPOT ELEVATIONS

NOTE:

1. REFER TO WILLOUGHBY CORNER SUBDIVISION CONSTRUCTION PLANS FOR GRADING INFORMATION REGARDING STREETS, ROUNDABOUTS, STORM SEWER, AND THE STORMWATER DETENTION FACILITY.

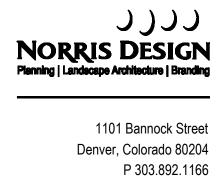

WILLOUGHBY CORNER


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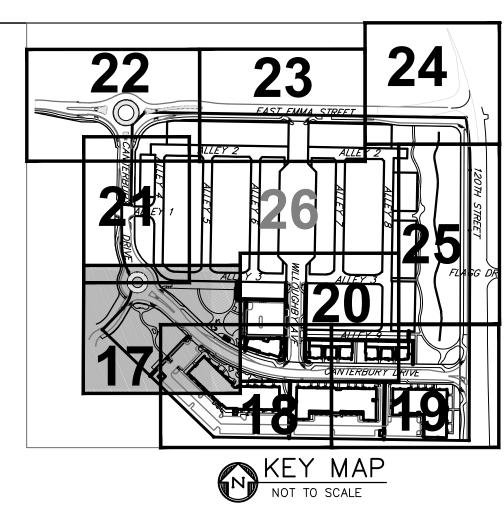
DATE: 06.17.22 - SITE PLAN 01 09.15.22 - SITE PLAN 02

SHEET TITLE: GRADING PLAN 2

M

LOTS 161, 164, 165, 166 & 167, & OUTLOTS F, I, J, K, L & N OF THE WILLOUGHBY CORNER SUBDIVISION, CITY OF LAFAYETTE, COUNTY OF BOULDER, STATE OF COLORADO



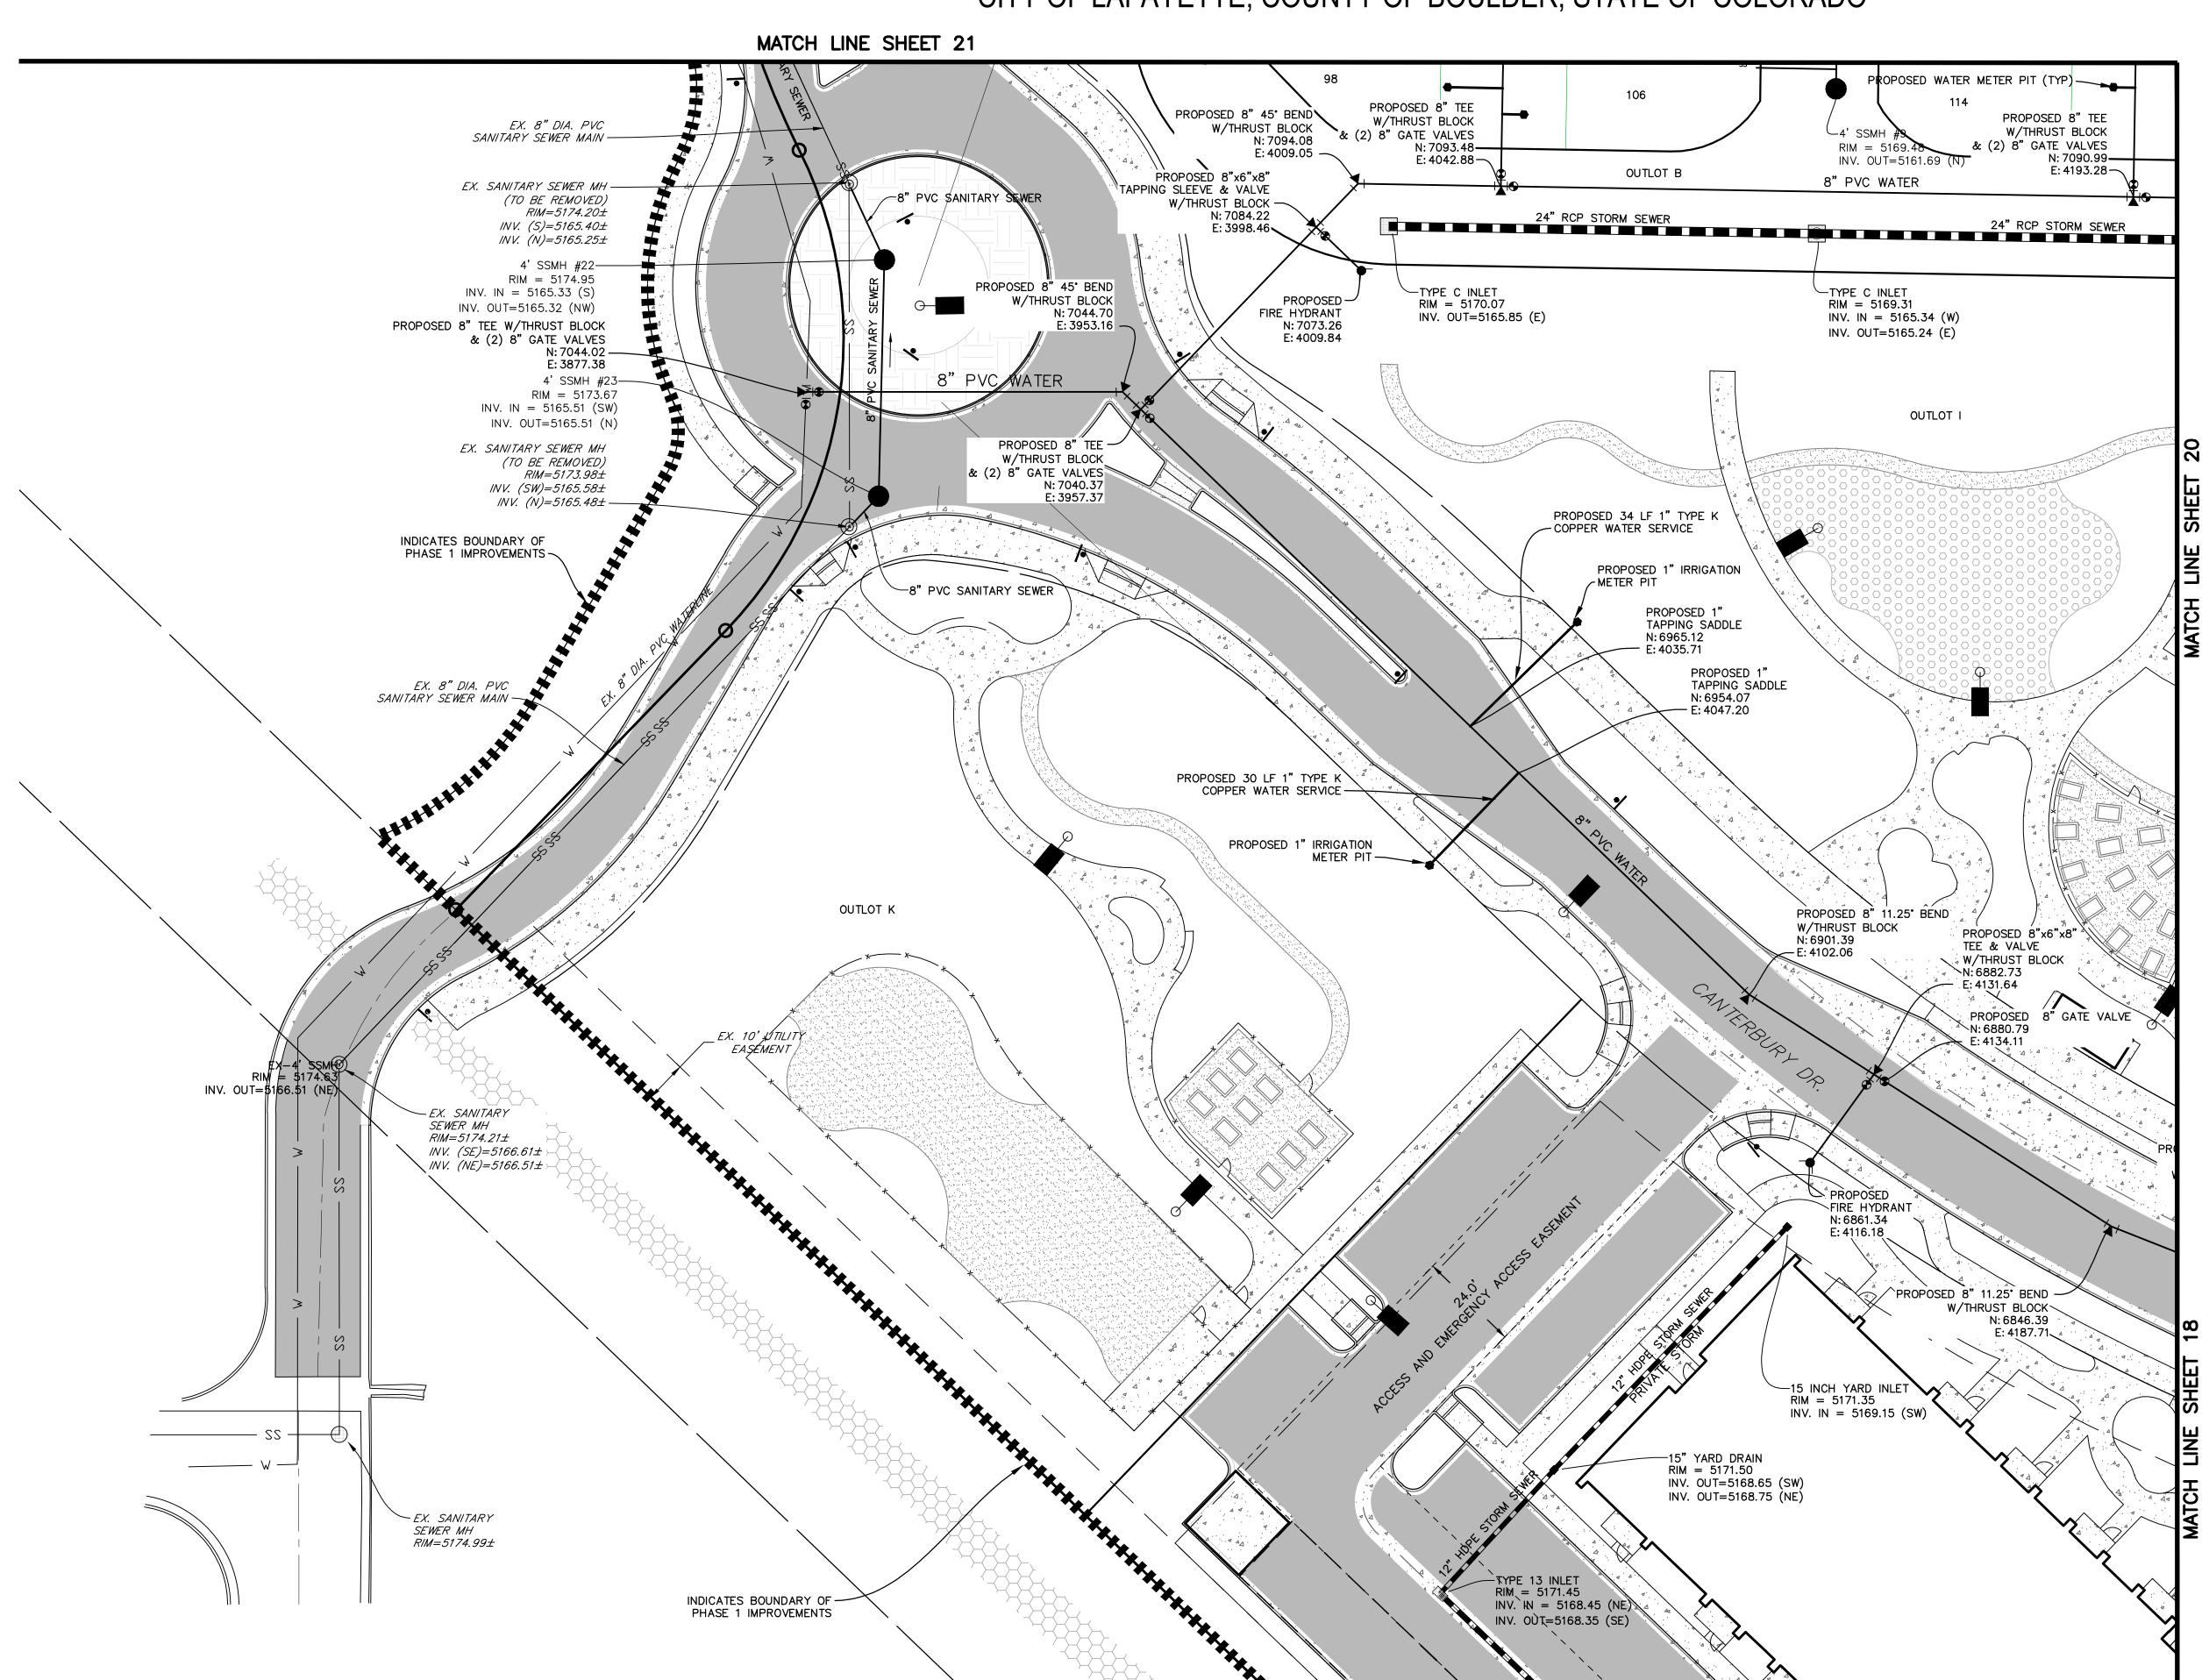

<u>LEGEND</u>

PROPERTY LINE
PROPOSED LOT LINE
EX. SANITARY SEWERssss
EX. WATER LINE w w
EX. STORM LINE st st
EX. GAS LINE g g
EX. BURIED ELECTRIC LINE E
EX. OVERHEAD ELECTRIC LINE ==
EX. CABLE TV ctv
EX. FIRE HYDRANT &
EX. WATER VALVE &
EX. WATER METER
EX. MANHOLE
EX. LIGHT POLE
EX. UTILITY POLE
PROPOSED LIGHT POLE ⊖
PROPOSED STORM SEWER
PROPOSED SANITARY SEWER
PROPOSED WATER LINE
PROPOSED FIRE HYDRANT
PROPOSED WATER VALVE
PROPOSED METER
PROPOSED METER
•
PROPOSED MANHOLE
PROPOSED MANHOLE

<u>NOT</u>

1. ALL STORM, SEWER AND WATER MAINS SHALL BE INSTALLED WITH PHASE 1. REFER TO WILLOUGHBY CORNER SUBDIVISION CONSTRUCTION PLANS FOR PLAN & PROFILES, HORIZONTAL LAYOUT, AND CONSTRUCTION LEVEL DETAILS.

ORIGINAL SCALE: 1"=20'

2. BACKFLOW PREVENTION IS REQUIRED FOR ALL IRRIGATION TAPS.



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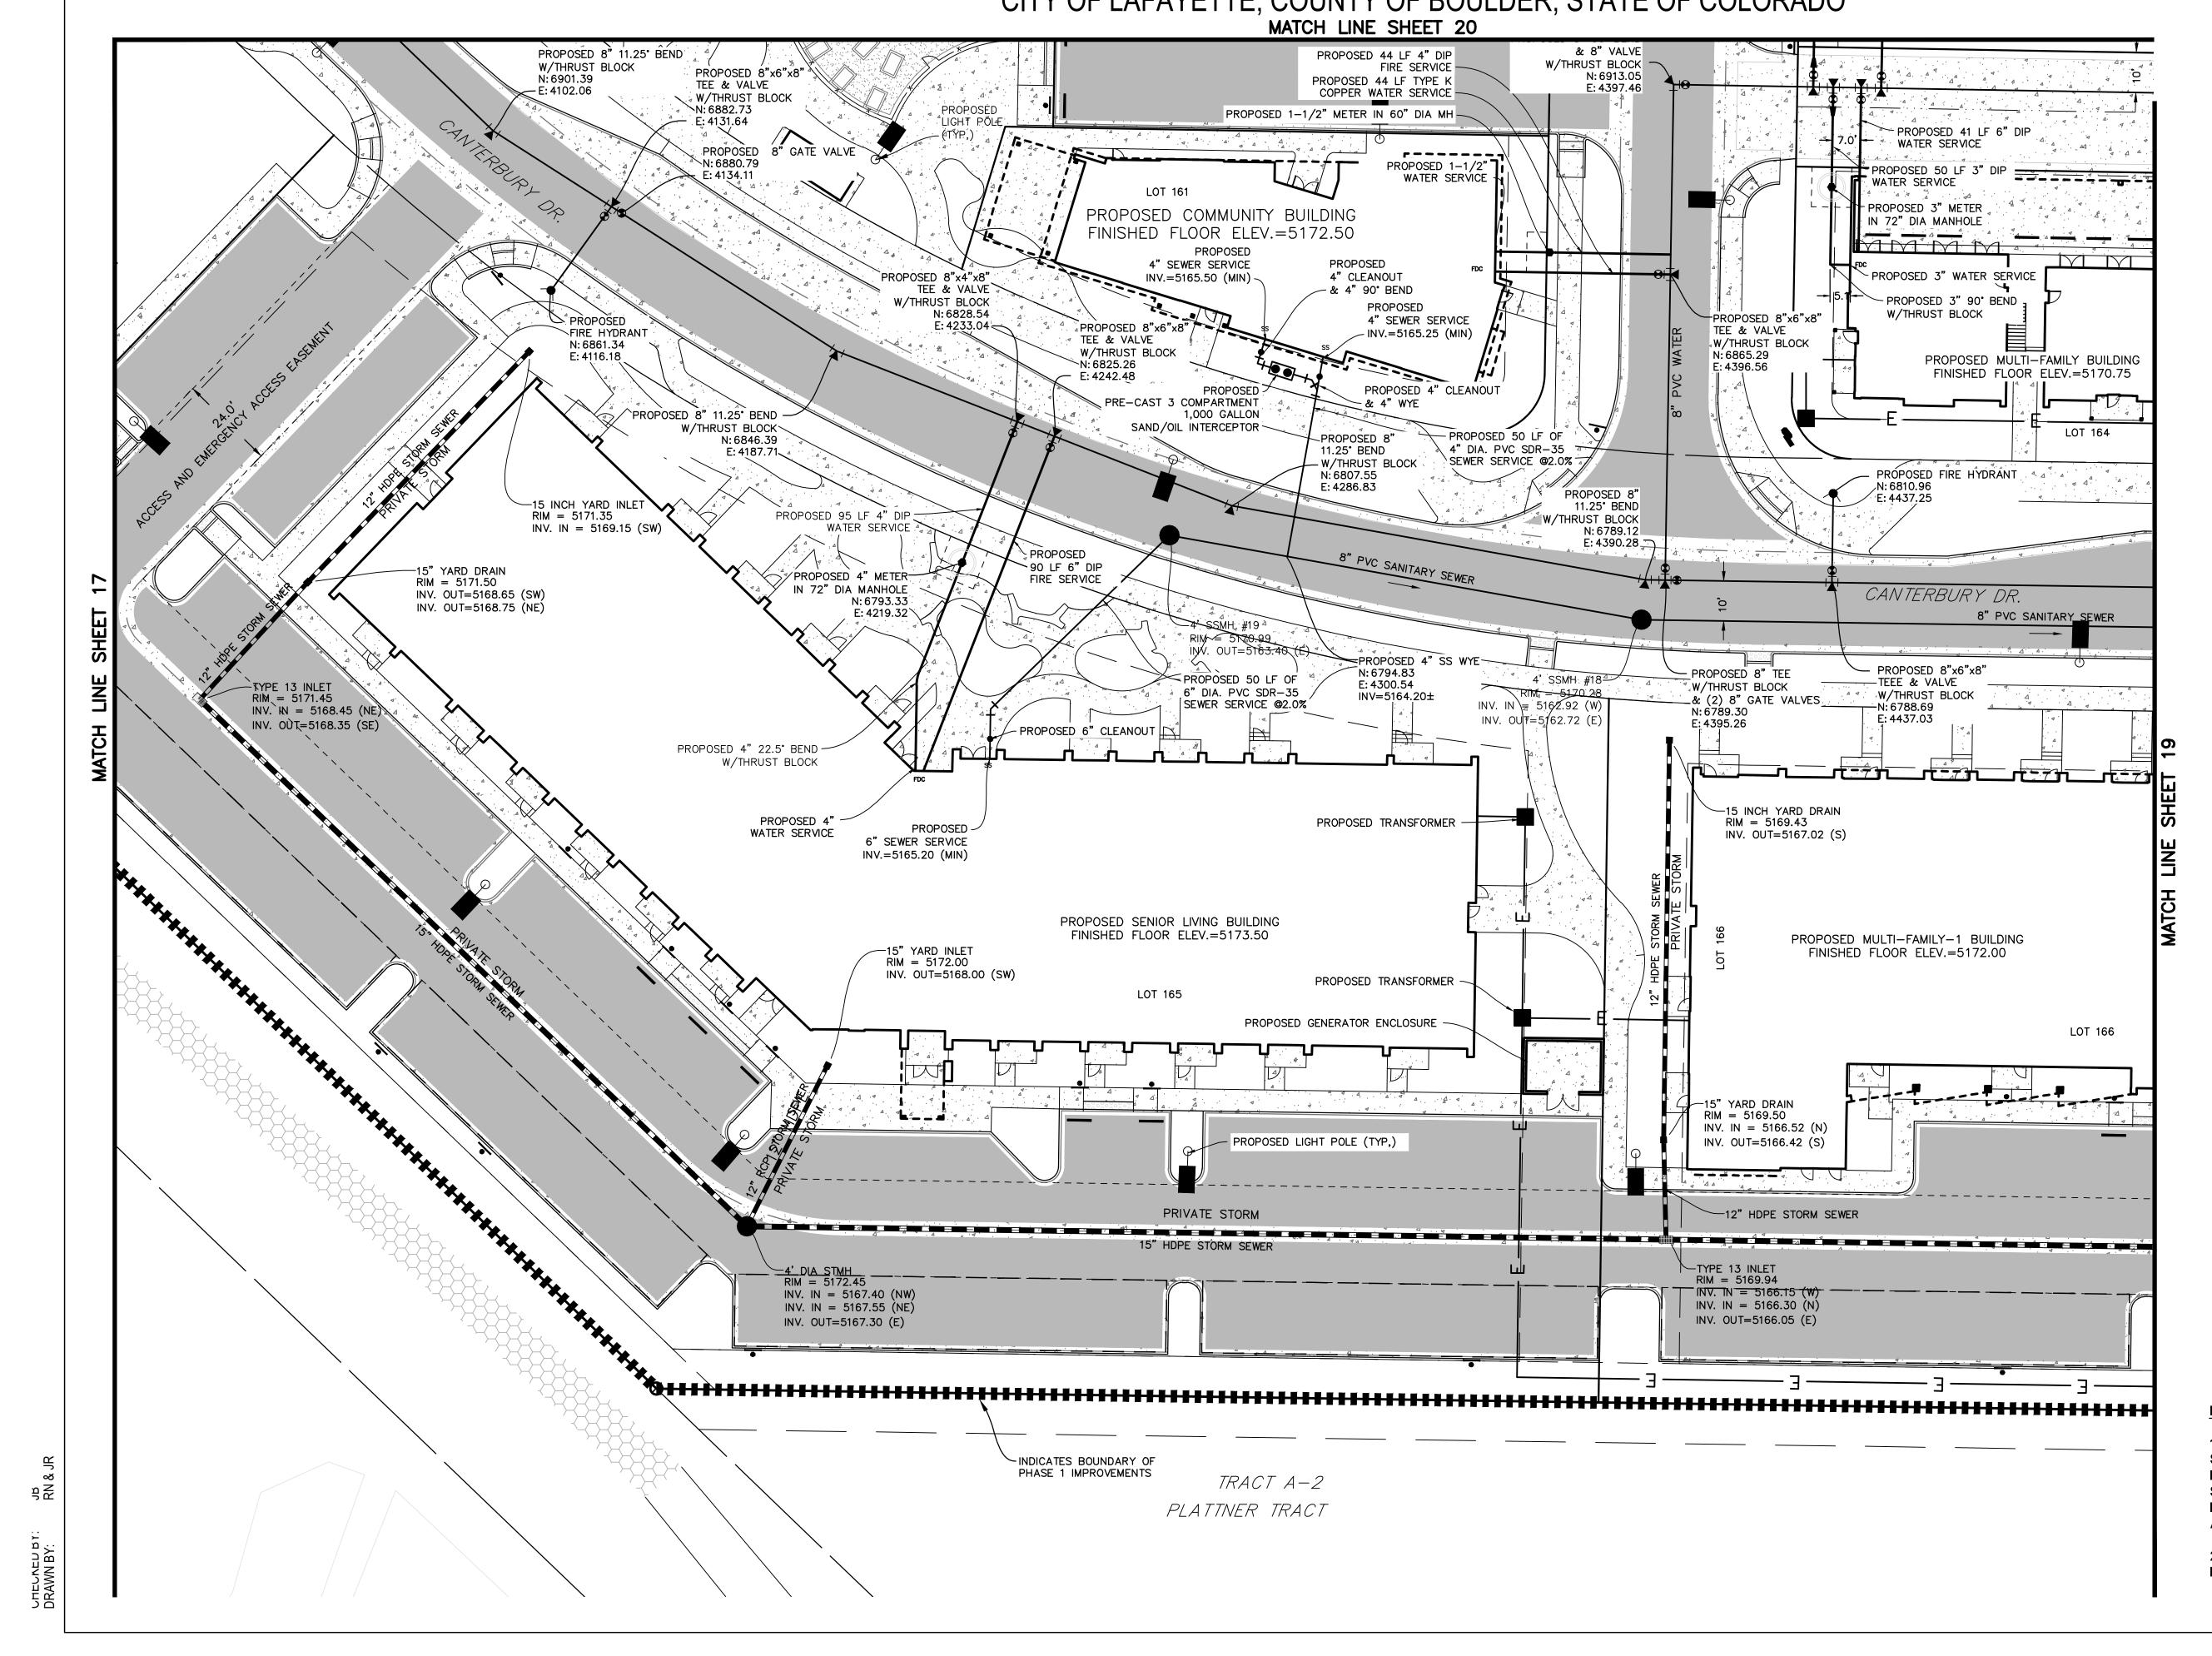
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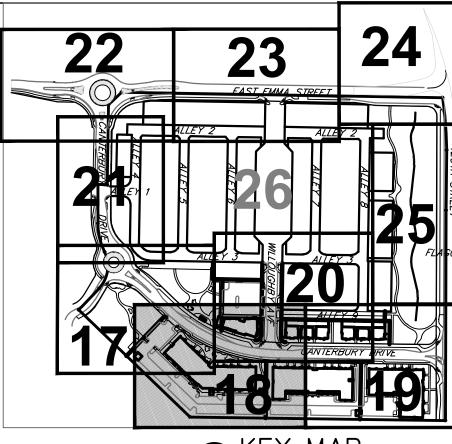
06.17.22 - SITE PLAN 01 09.15.22 - SITE PLAN 02

SHEET TITLE:

PLAN

LOTS 161, 164, 165, 166 & 167, & OUTLOTS F, I, J, K, L & N OF THE WILLOUGHBY CORNER SUBDIVISION, CITY OF LAFAYETTE, COUNTY OF BOULDER, STATE OF COLORADO






<u>LEGEND</u>

PROPERTY LINE.

PROPOSED LOT LINE
EX. SANITARY SEWER ss ——— ss ———
EX. WATER LINE w w
EX. STORM LINE st — st — st — st — st — st — st
<i>EX. GAS LINE</i> _G
EX. BURIED ELECTRIC LINE E
EX. OVERHEAD ELECTRIC LINE ==
<i>EX. CABLE TV</i> ctv
EX. FIRE HYDRANT
EX. WATER VALVE⊗
EX. WATER METER
EX. MANHOLE
EX. LIGHT POLE
EX. UTILITY POLE
PROPOSED LIGHT POLE
PROPOSED STORM SEWER
PROPOSED SANITARY SEWER
PROPOSED WATER LINE
PROPOSED FIRE HYDRANT
PROPOSED WATER VALVE
PROPOSED METER
PROPOSED MANHOLE
PROPOSED STORM INLET
PROPOSED CONCRETE
DPODOSED ASPHALT

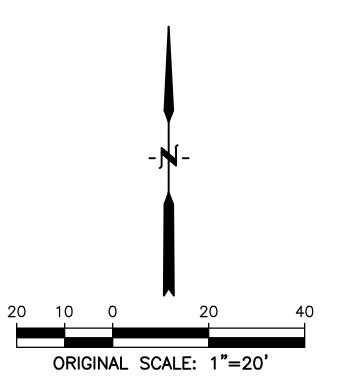

NOTE:

1. ALL STORM, SEWER AND WATER MAINS SHALL BE INSTALLED WITH PHASE 1. REFER TO WILLOUGHBY CORNER SUBDIVISION CONSTRUCTION PLANS FOR PLAN & PROFILES, HORIZONTAL LAYOUT, AND CONSTRUCTION LEVEL DETAILS.

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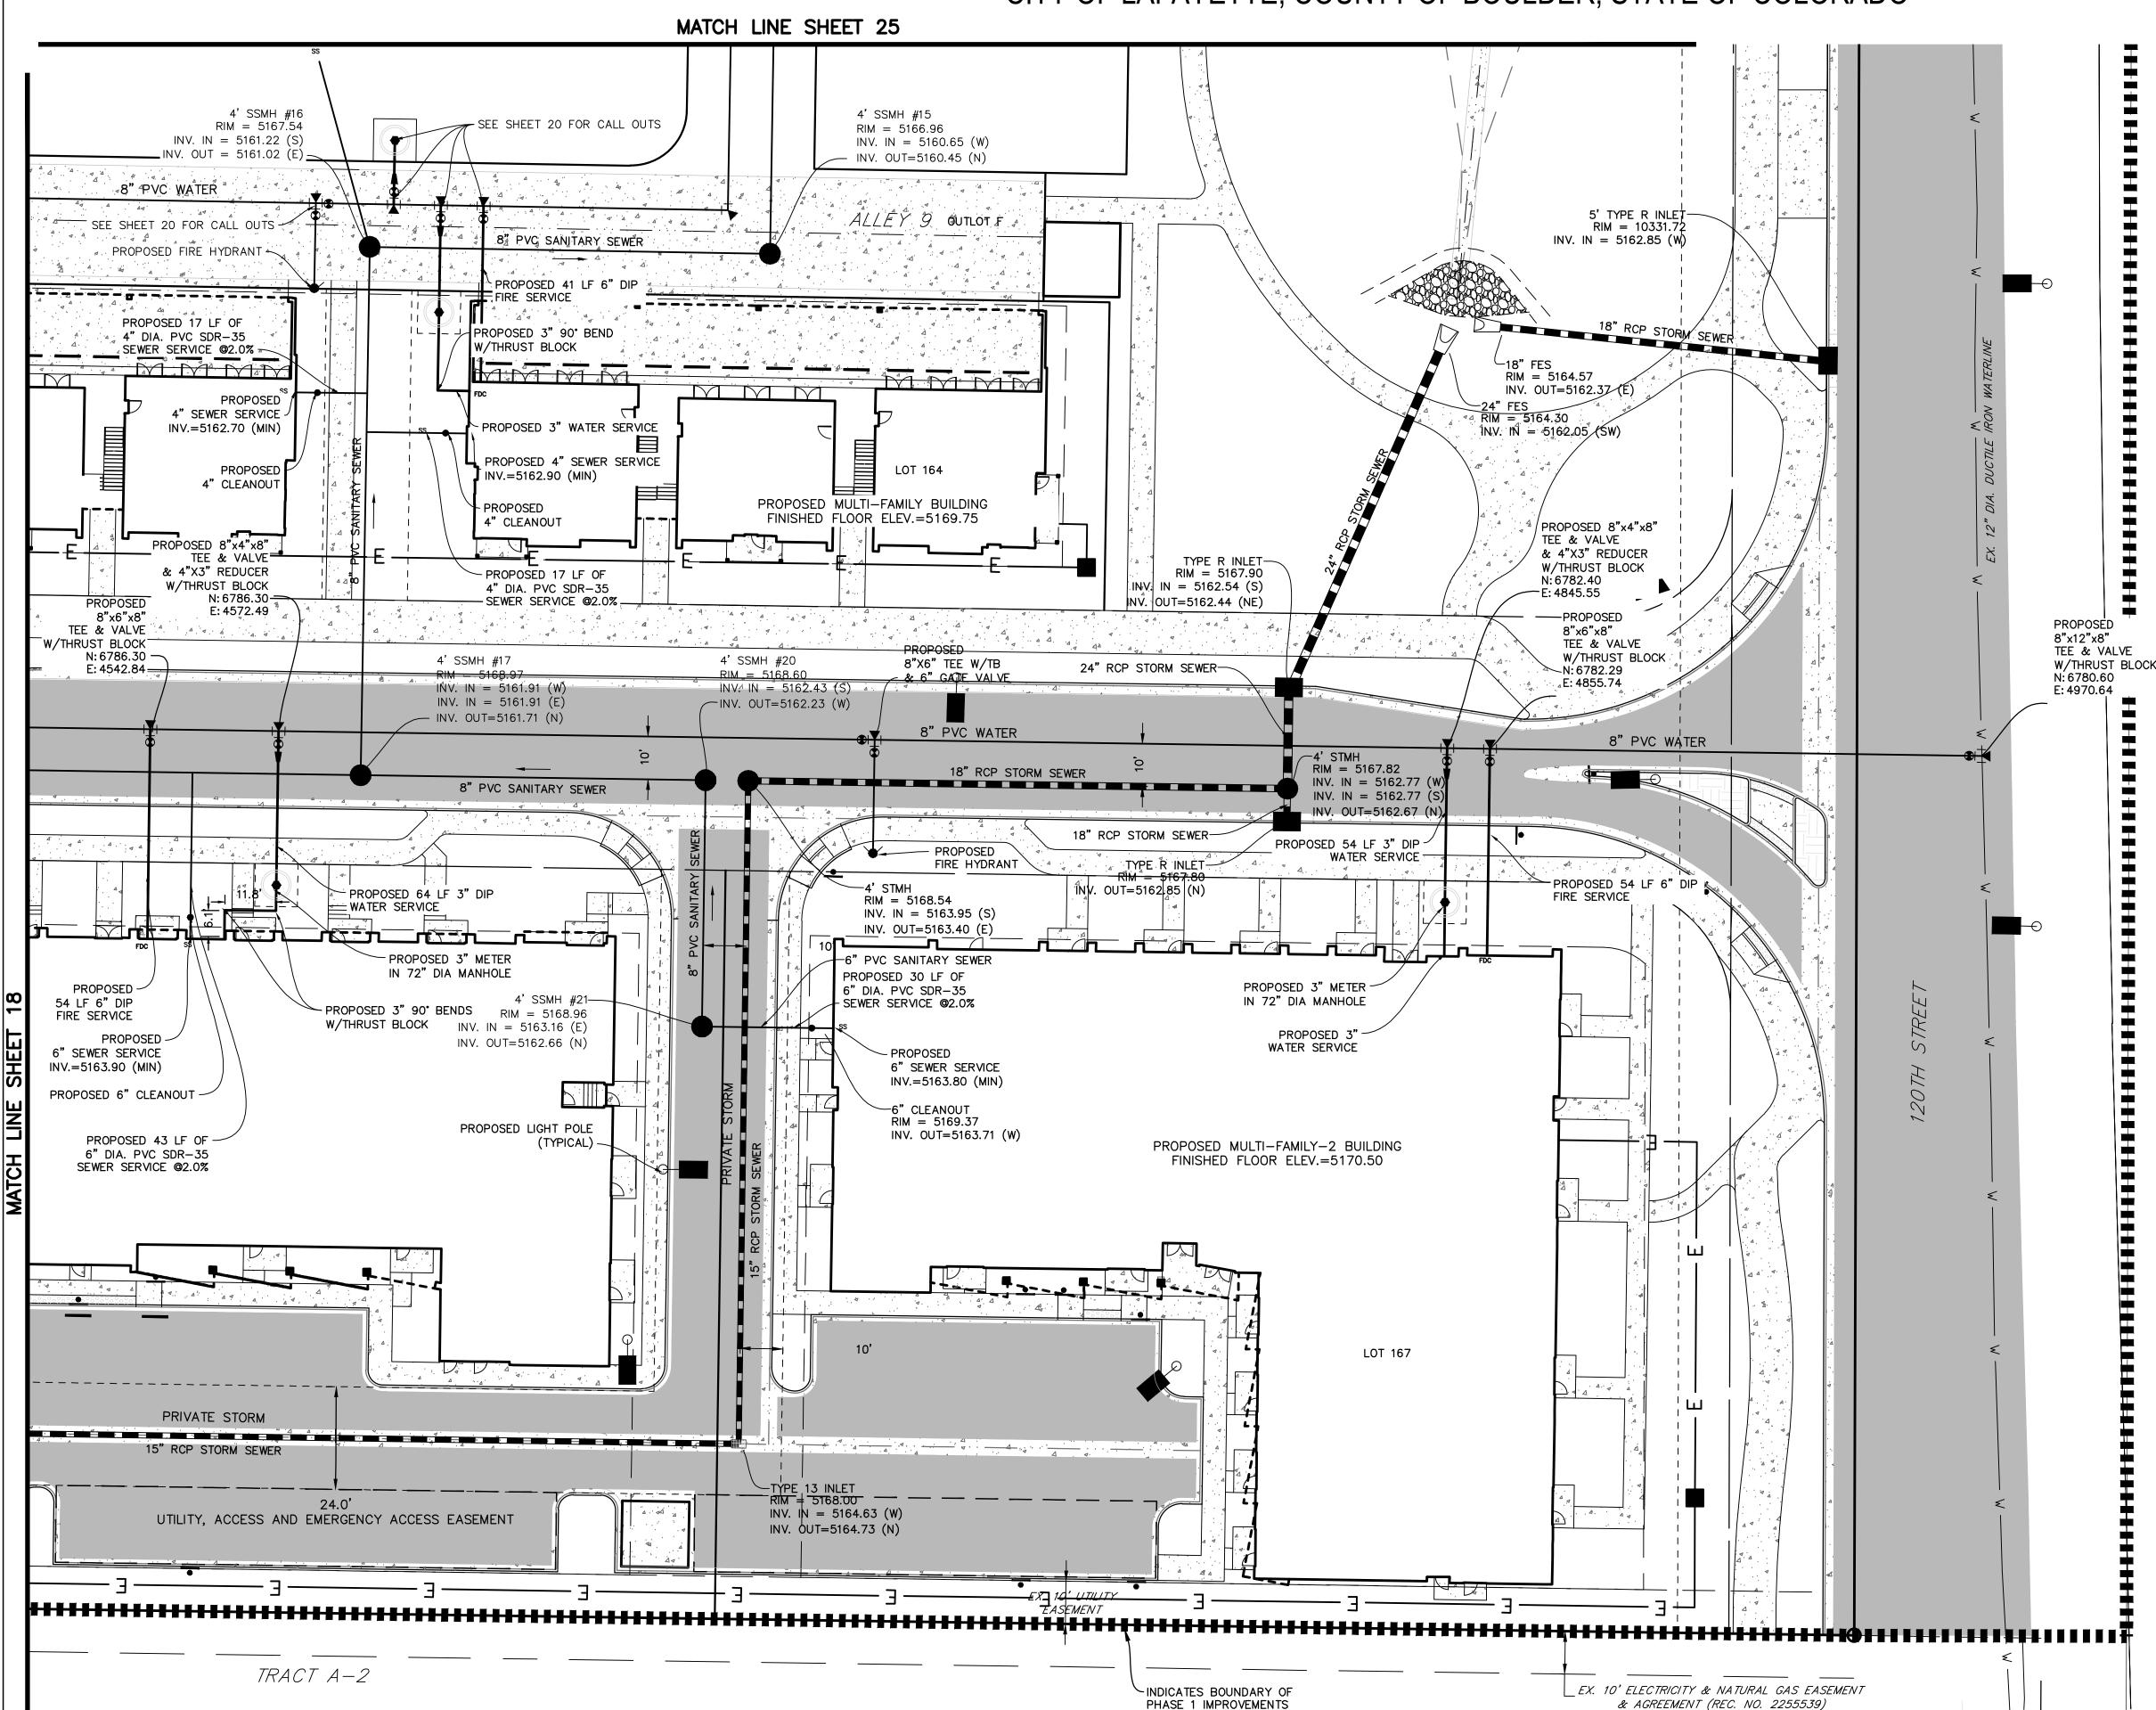
CONTACT: MOLLY CHIANG


DATE: 06.17.22 - SITE PLAN 01 09.15.22 - SITE PLAN 02

SHEET TITLE:

UTILITY PLAN

LOTS 161, 164, 165, 166 & 167, & OUTLOTS F, I, J, K, L & N OF THE WILLOUGHBY CORNER SUBDIVISION, CITY OF LAFAYETTE, COUNTY OF BOULDER, STATE OF COLORADO




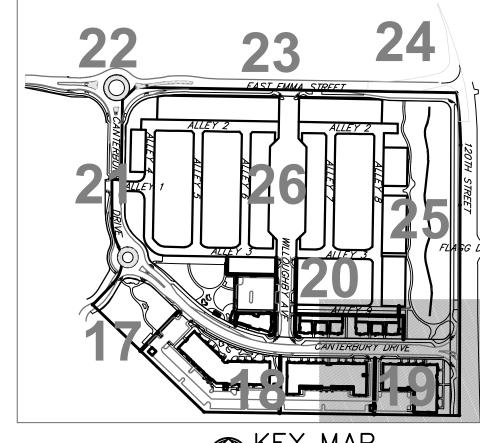

NOT TO SCALE

<u>LEGEND</u>

PROPERTY LINE
PROPOSED LOT LINE
EX. SANITARY SEWERssss
EX. WATER LINE w w
EX. STORM LINE stst
EX. GAS LINE
EX. BURIED ELECTRIC LINE E
EX. OVERHEAD ELECTRIC LINE ============================
EX. CABLE TV ctv
EX. FIRE HYDRANT
EX. WATER VALVE
EX. WATER METER
EX. MANHOLE
EX. LIGHT POLE
EX. UTILITY POLE
PROPOSED LIGHT POLE
PROPOSED STORM SEWER
PROPOSED SANITARY SEWER
PROPOSED WATER LINE
PROPOSED FIRE HYDRANT
PROPOSED WATER VALVE ⊕
PROPOSED METER
PROPOSED MANHOLE
PROPOSED STORM INLET
PROPOSED CONCRETE
PROPOSED ASPHALT

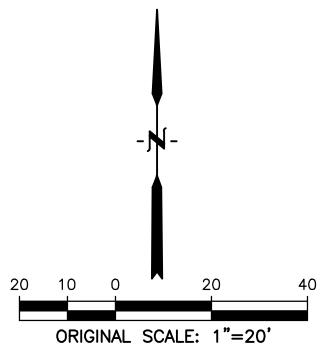

NOTE:

1. ALL STORM, SEWER AND WATER MAINS SHALL BE INSTALLED WITH PHASE 1. REFER TO WILLOUGHBY CORNER SUBDIVISION CONSTRUCTION PLANS FOR PLAN & PROFILES, HORIZONTAL LAYOUT, AND CONSTRUCTION LEVEL DETAILS.

2. BACKFLOW PREVENTION IS REQUIRED FOR ALL IRRIGATION TAPS.



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WILLOUGHBY CC SITE PLAN- PHASE 1


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CONTACT: MOLLY CHIANG

DATE: 06.17.22 - SITE PLAN 01 09.15.22 - SITE PLAN 02

SHEET TITLE:
UTILITY

UTILITY PLAN

LOTS 161, 164, 165, 166 & 167, & OUTLOTS F, I, J, K, L & N OF THE WILLOUGHBY CORNER SUBDIVISION, CITY OF LAFAYETTE, COUNTY OF BOULDER, STATE OF COLORADO

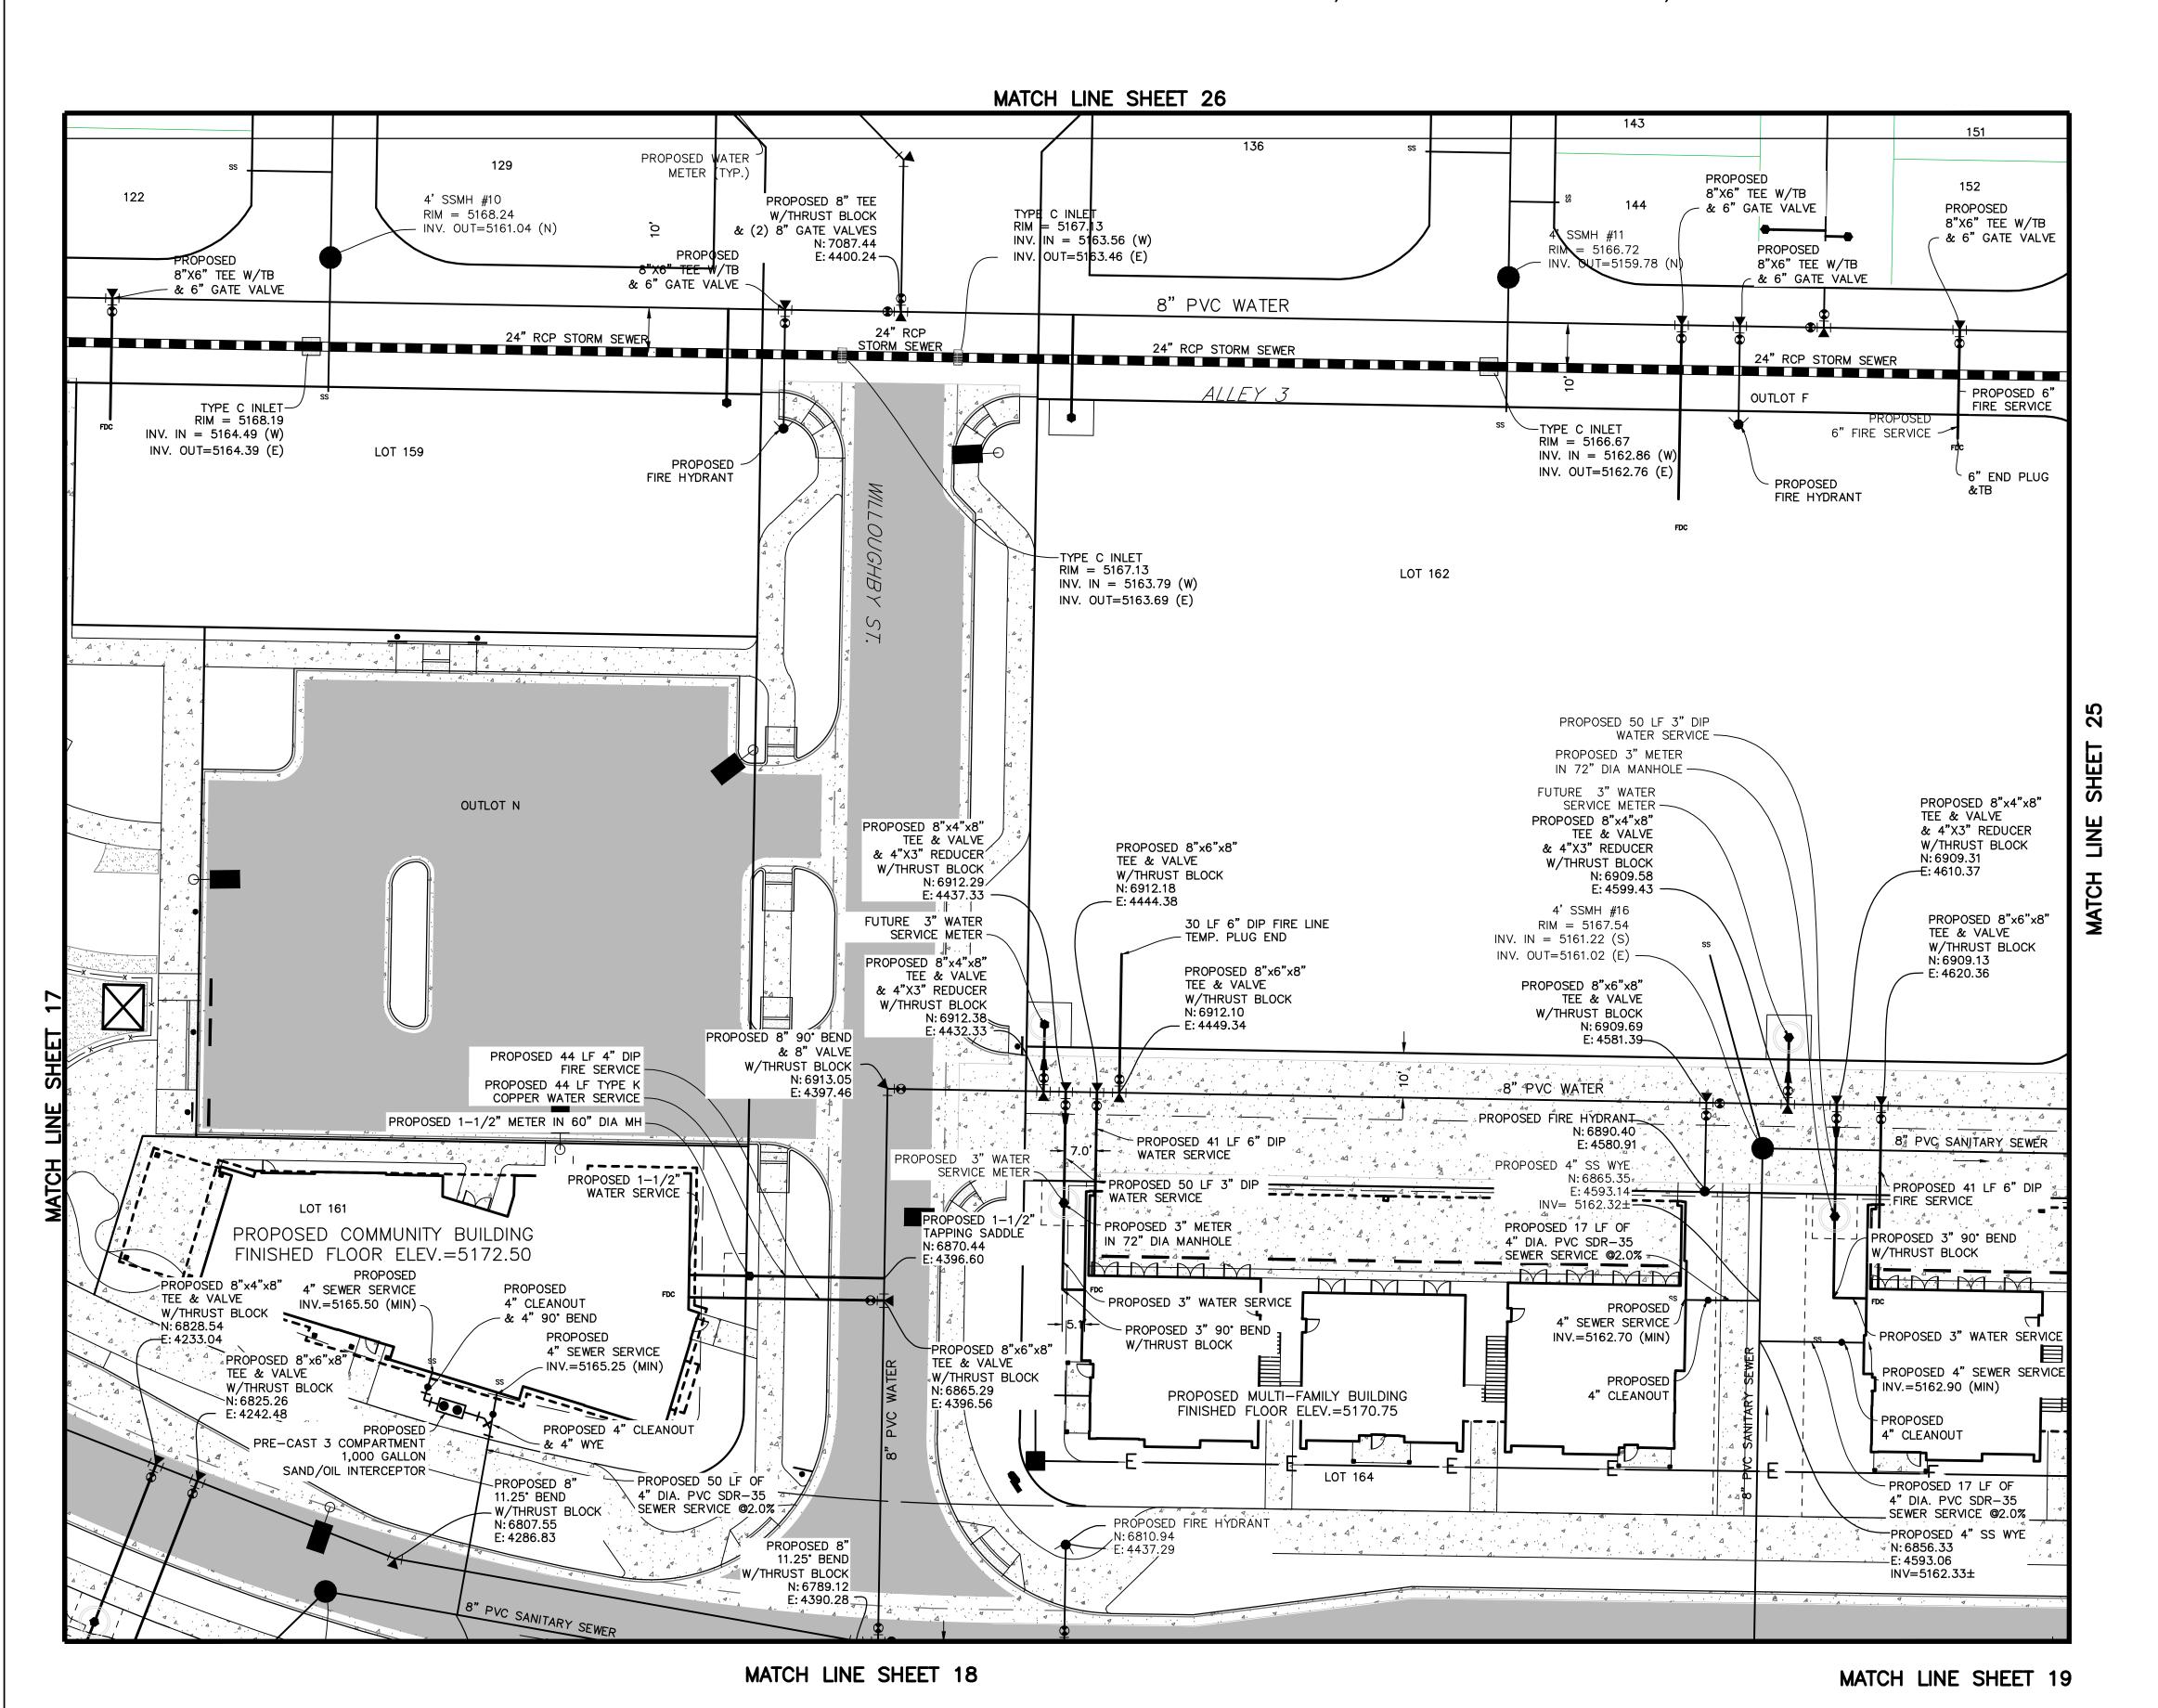




<u>LEGEND</u>

PROPERTY LINE

PROPOSED LOT LINE PROPOSED ROW
EX. SANITARY SEWERssss
EX. WATER LINE w w
EX. STORM LINEstst
EX. GAS LINE
EX. BURIED ELECTRIC LINE E
EX. OVERHEAD ELECTRIC LINE ==
EX. CABLE TV ctv
EX. FIRE HYDRANT &
EX. WATER VALVE
EX. WATER METER
EX. MANHOLE
EX. LIGHT POLE
EX. UTILITY POLE
PROPOSED LIGHT POLE
PROPOSED STORM SEWER
PROPOSED SANITARY SEWER
PROPOSED WATER LINE
PROPOSED FIRE HYDRANT
PROPOSED WATER VALVE
PROPOSED METER
PROPOSED MANHOLE
PROPOSED STORM INLET
PROPOSED CONCRETE

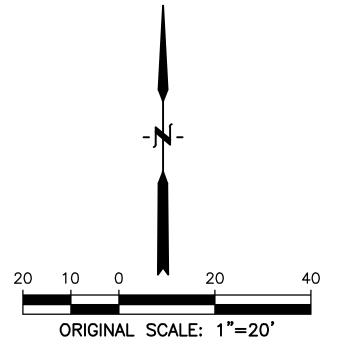

NOTE:

1. ALL STORM, SEWER AND WATER MAINS SHALL BE INSTALLED WITH PHASE 1. REFER TO WILLOUGHBY CORNER SUBDIVISION CONSTRUCTION PLANS FOR PLAN & PROFILES, HORIZONTAL LAYOUT, AND CONSTRUCTION LEVEL DETAILS.

PROPOSED ASPHALT

2. BACKFLOW PREVENTION IS REQUIRED FOR ALL IRRIGATION TAPS.



SHEET TITLE:

UTILITY

PLAN

BOULDER COUNTY HOUSING

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DATE:

06.17.22 - SITE PLAN 01

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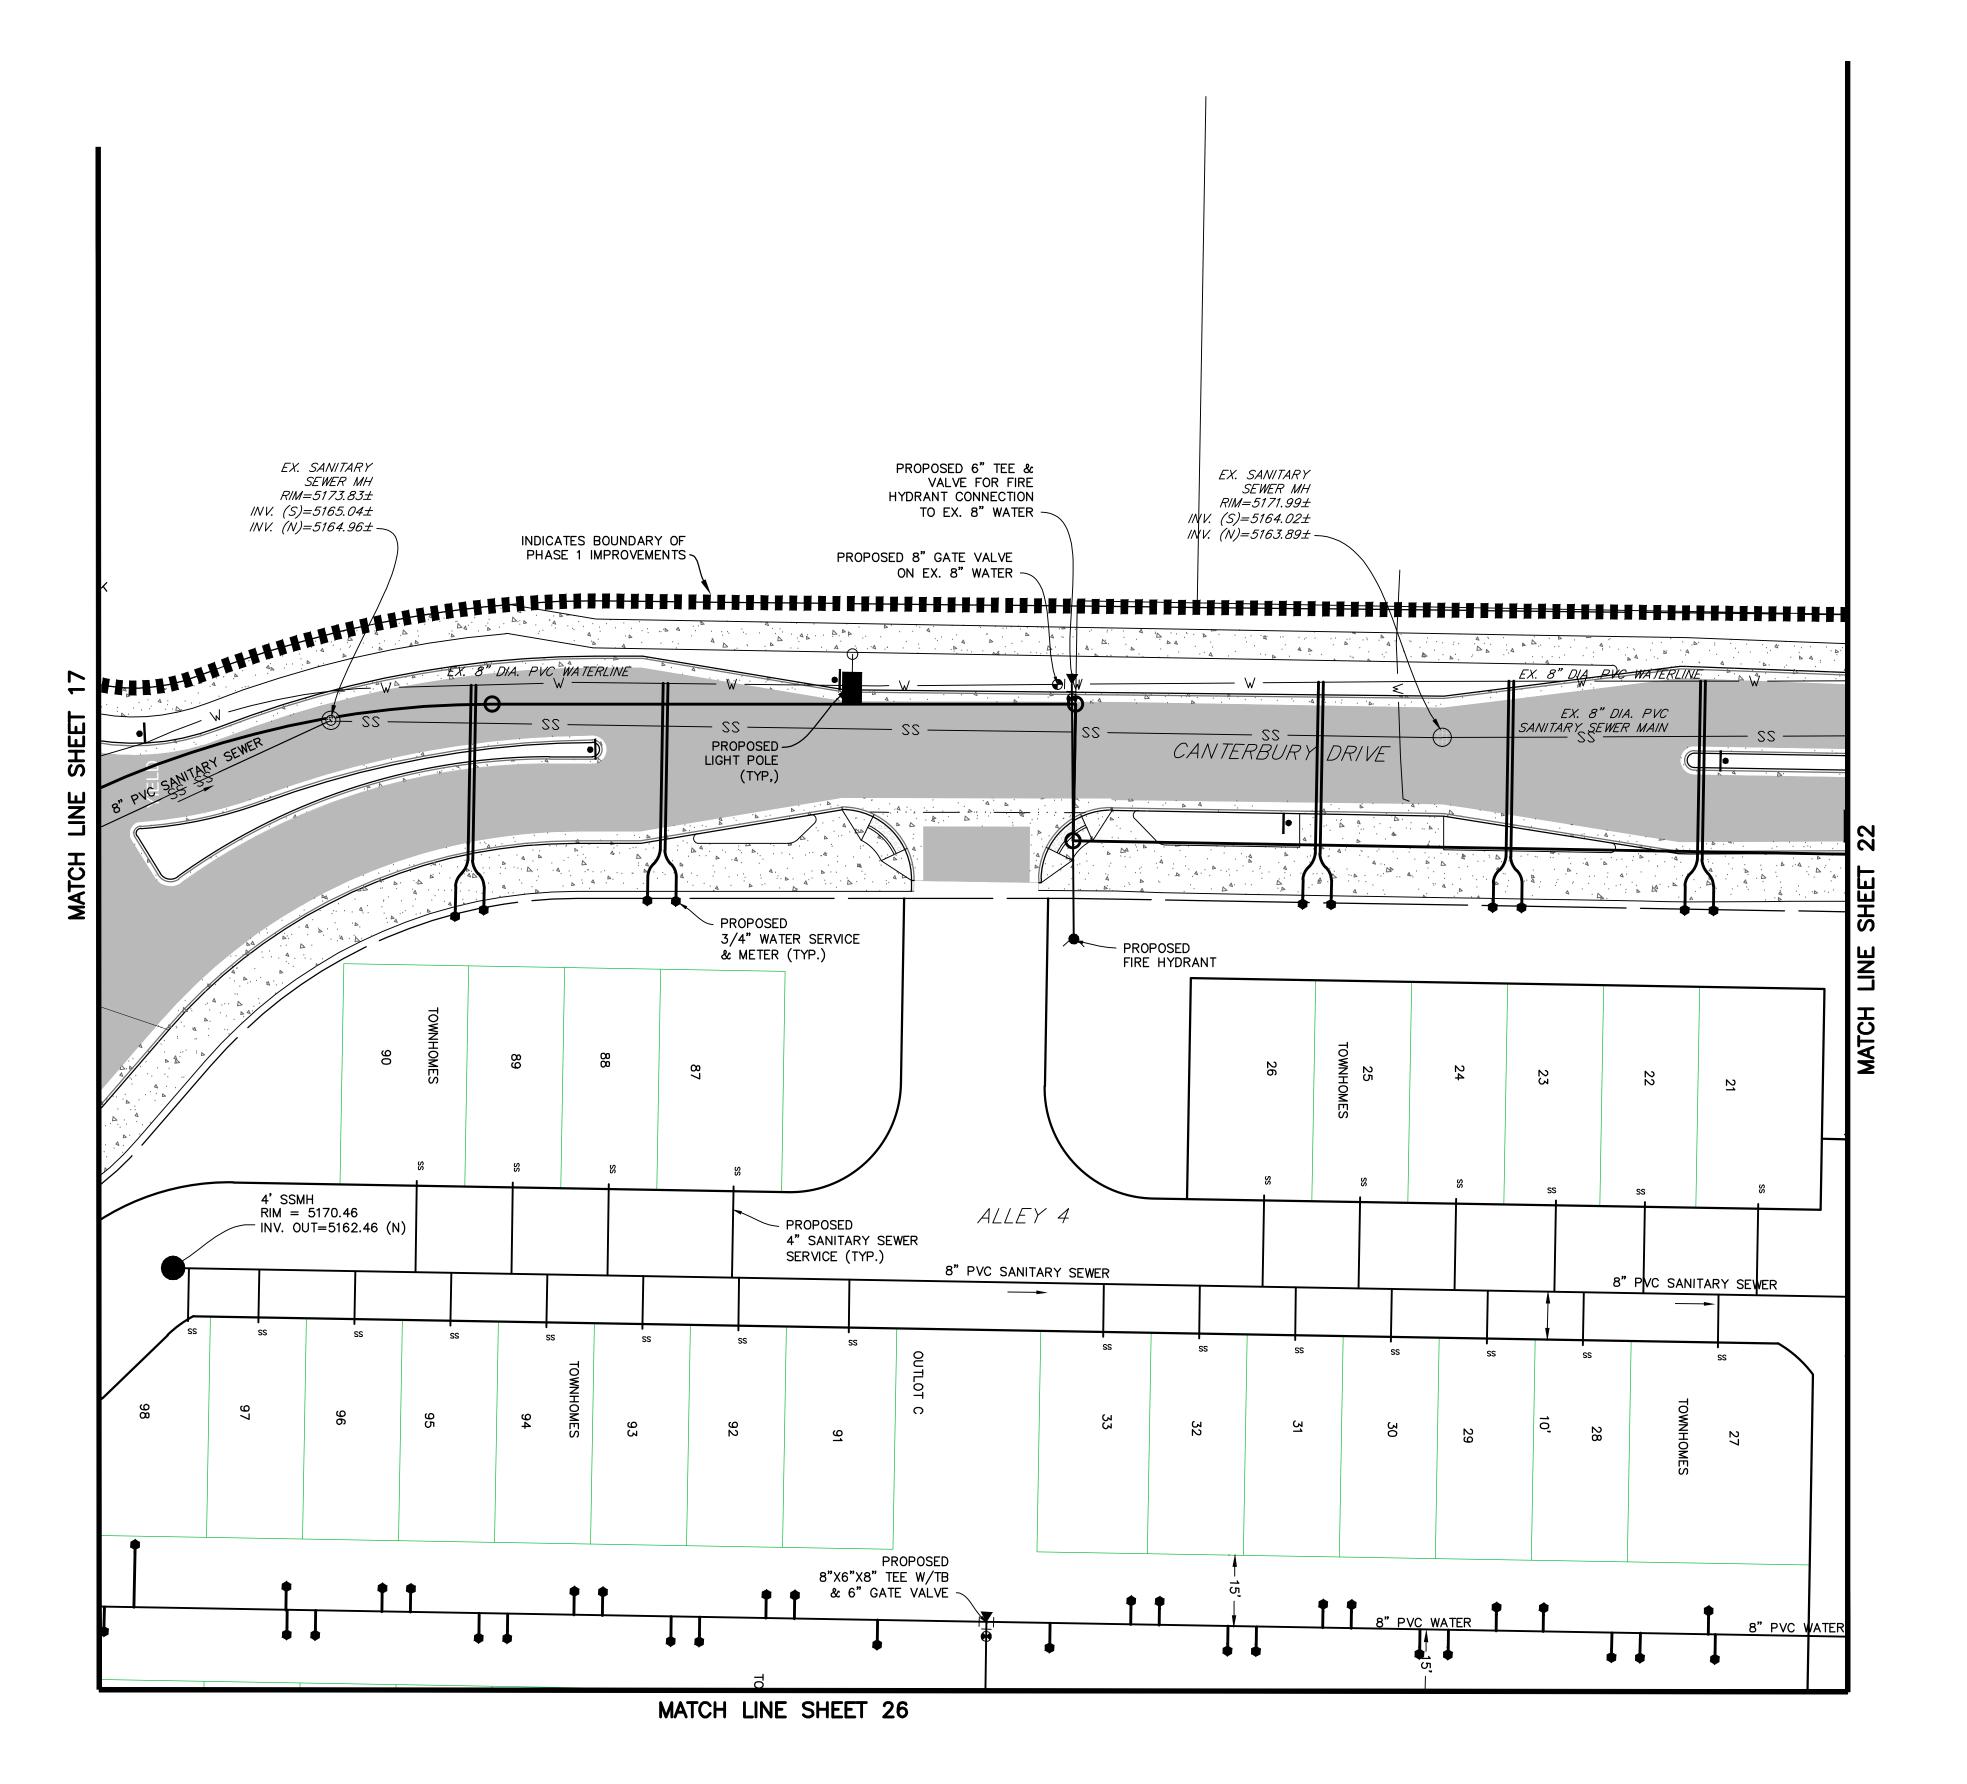
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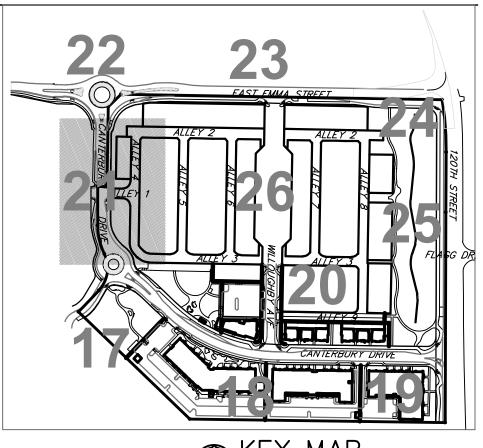
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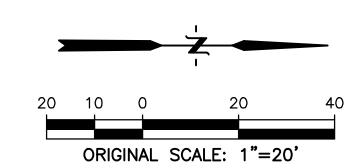




KEY MAP NOT TO SCALE

<u>LEGEND</u>

PROPERTY LINE
PROPOSED LOT LINE
EX. SANITARY SEWER ss
EX. WATER LINE w w
EX. STORM LINE st st
EX. GAS LINE g g
EX. BURIED ELECTRIC LINE E
EX. OVERHEAD ELECTRIC LINE ============================
EX. CABLE TV ctv
EX. FIRE HYDRANT &
EX. WATER VALVE
EX. WATER METER
EX. MANHOLE
EX. LIGHT POLE
EX. UTILITY POLE
PROPOSED LIGHT POLE
PROPOSED STORM SEWER
PROPOSED SANITARY SEWER
PROPOSED WATER LINE
PROPOSED FIRE HYDRANT
PROPOSED WATER VALVE
PROPOSED METER
PROPOSED MANHOLE
PROPOSED STORM INLET
PROPOSED CONCRETE
PROPOSED ASPHALT



NOTE:

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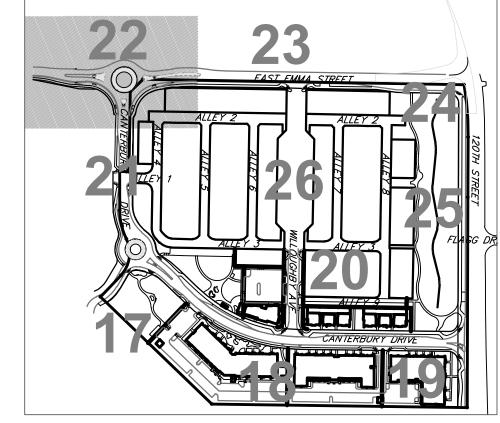
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CONTACT: MOLLY CHIANG

DATE: 06.17.22 - SITE PLAN 01 09.15.22 - SITE PLAN 02

SHEET TITLE:
UTILITY

UTILITY PLAN

LOTS 161, 164, 165, 166 & 167, & OUTLOTS F, I, J, K, L & N OF THE WILLOUGHBY CORNER SUBDIVISION, CITY OF LAFAYETTE, COUNTY OF BOULDER, STATE OF COLORADO





<u>LEGEND</u>

PROPERTY LINE
PROPOSED LOT LINE PROPOSED ROW
EX. SANITARY SEWERssss
EX. WATER LINE w w
EX. STORM LINEstst
EX. GAS LINE
EX. BURIED ELECTRIC LINE E
EX. OVERHEAD ELECTRIC LINE ============================
EX. CABLE TV ctv
EX. FIRE HYDRANT
EX. WATER VALVE
EX. WATER METER
EX. MANHOLE
EX. LIGHT POLE
EX. UTILITY POLE
PROPOSED LIGHT POLE 9-
PROPOSED STORM SEWER
PROPOSED SANITARY SEWER
PROPOSED WATER LINE
PROPOSED FIRE HYDRANT
PROPOSED WATER VALVE
PROPOSED METER
PROPOSED MANHOLE
PROPOSED STORM INLET
PROPOSED CONCRETE
PROPOSED ASPHALT

NOTE:

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DATE: 06.17.22 - SITE PLAN 01 09.15.22 - SITE PLAN 02

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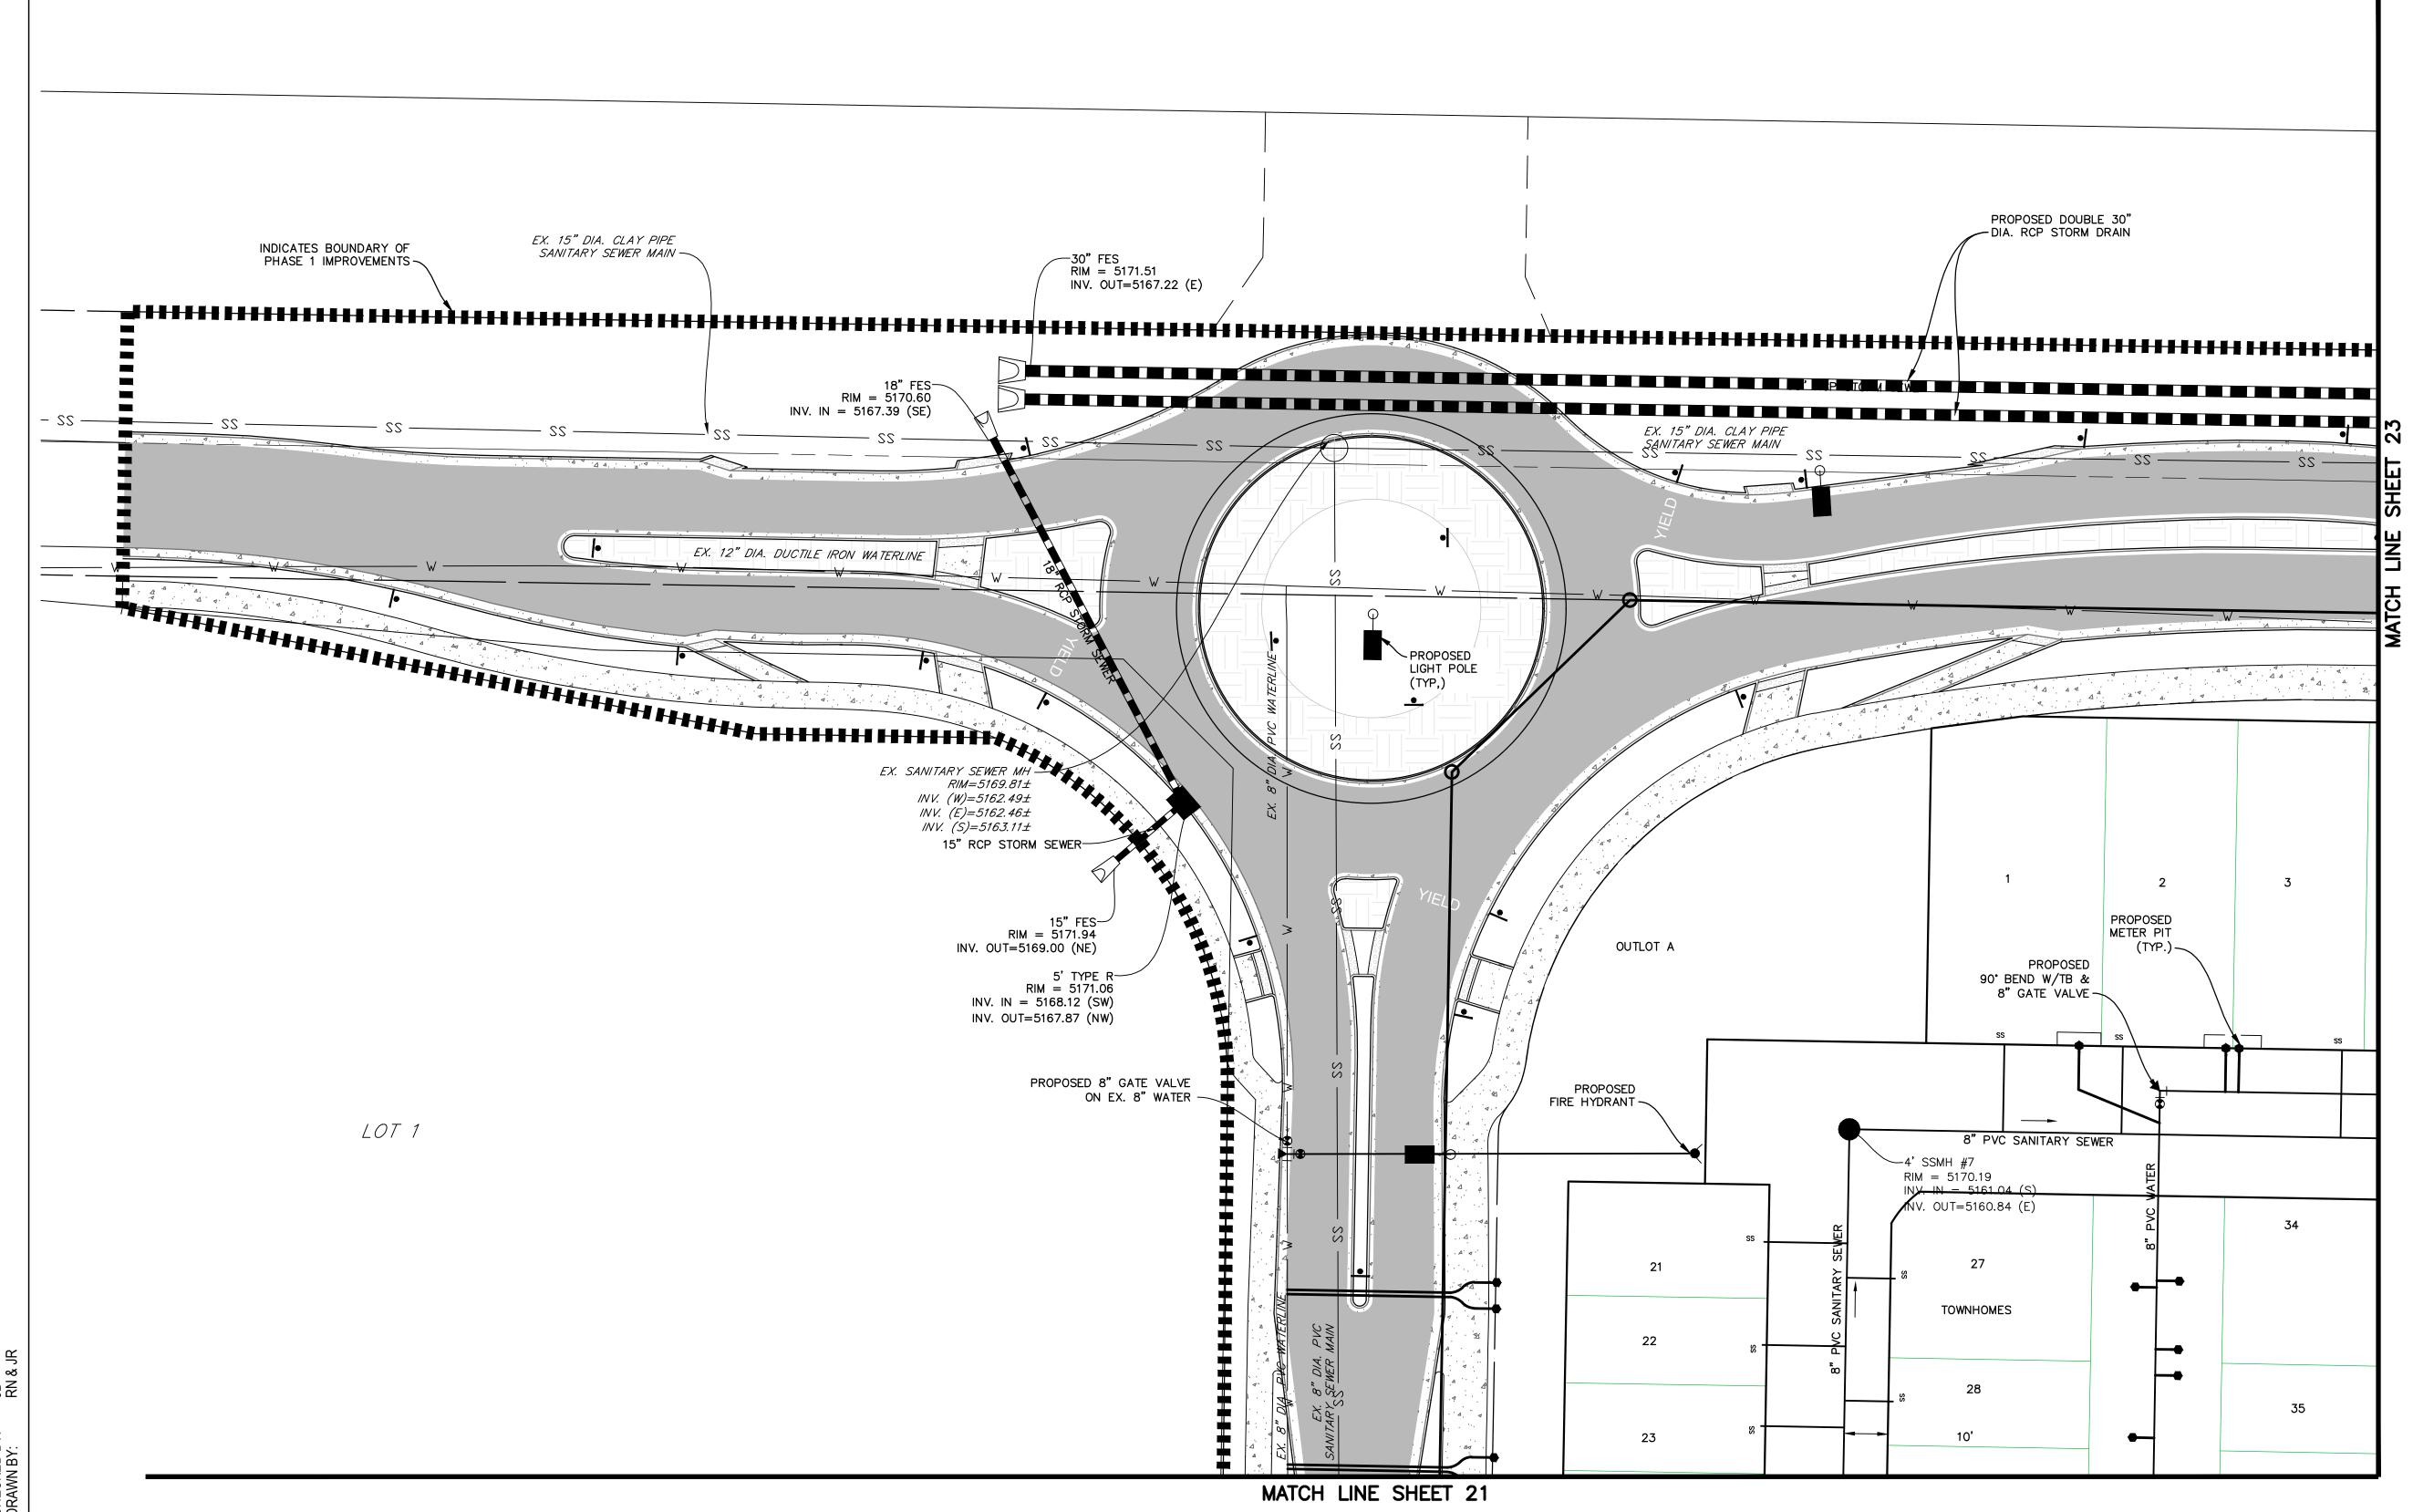
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FX 15" DIA CLAY PIPF

SANITARY SEWER MAIN

13

-15" RCP STORM SEWER

INV. IN = 5162.98 (NW)

INV. OUT=5162.88 (S)

PROPOSED

WATER METER

EAST EMMA STREET

15

PROPOSED WATER METER

ALLEY 2

' PVC WATER

4' SSMH #4-

RIM = 5165.25

INV. IN = 5158.28 (S)

INV. OUT=5158.18 (E)

EX. SANITARY SEWER MH

INV. (W)=5161.18±

12"X8"X12" TEE

8" GATE VALVE W/THRUST BLOCK -

12" GATE VALVE

ON EXISTING LINE -

8"X6"X8" TEE W/TB

TYPE C INLET— RIM = 5165.60 INV. OUT=5163.20 (E)

TYPE C INLET— RIM = 5165.60 INV. IN = 5163.07 (W)

INV. OUT=5163.07 (SE)

PROPOSED FIRE

HYDRANT (TYP.)


& 6" GATE VALVE ~

PROPOSED 8" CROSS &

8" PVC SANITARY SEWER

15" RCP STORM SEWER

(3) 8" GATE VALVES

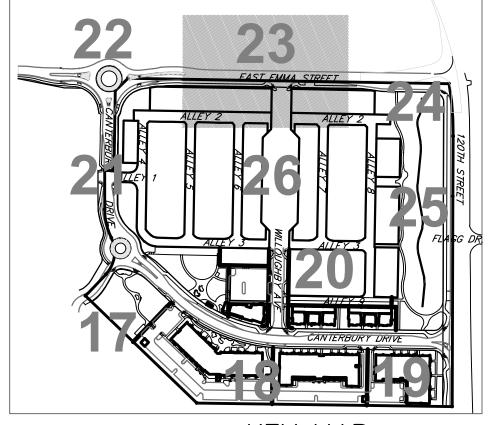

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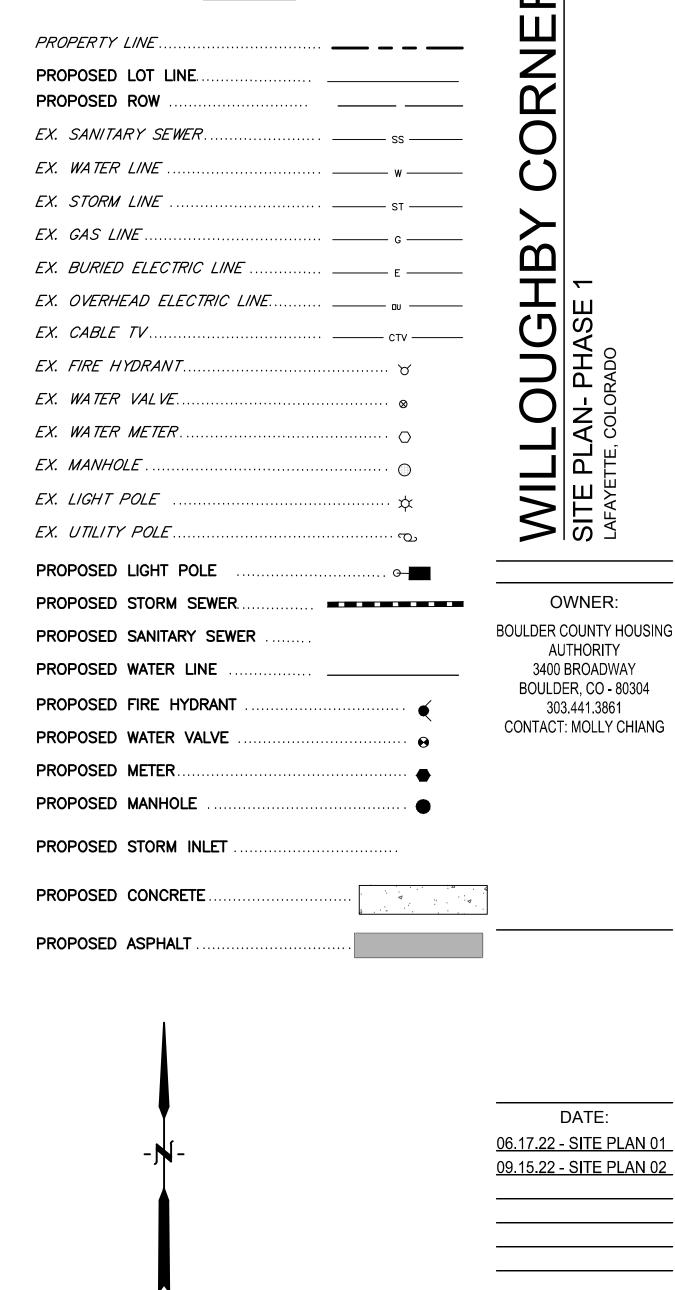
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<u>LEGEND</u>



18

8" TEE W/TB

& (2) 8" GATE VALVES

8" PVC SANITARY SEWER

LIGHT POLE

(TYP,)

1. ALL STORM, SEWER AND WATER MAINS SHALL BE INSTALLED WITH PHASE 1. **REFER TO WILLOUGHBY CORNER** SUBDIVISION CONSTRUCTION PLANS FOR PLAN & PROFILES, HORIZONTAL LAYOUT, AND CONSTRUCTION LEVEL DETAILS.

ORIGINAL SCALE: 1"=20'

2. BACKFLOW PREVENTION IS REQUIRED FOR ALL IRRIGATION TAPS.

UTILITY

INDICATES BOUNDARY OF

TYPE C INLET RIM = 5168.14

INV. OUT=5165.04 (S)

-4' SSMH #6

RIM = 5168.15

INV/IN = 5160.24 (S)

. OUT=5160.14 (E)

8" TEE W/TB

ALLEY 2

& (2) 8" GATE VALVES -

PHASE 1 IMPROVEMENTS -

EX. 30' ROW

EX. 20' DRAINAGE

& UTILITY EASEMENT

TYPE C INLET-

RIM = 5166.94

INV. OUT=5164.19 (S)

OUTLOT B

8" PVC SANITARY SEWER

PROPOSED -

(TYP,)

10

-4' SSMH #5

RIM = 5166.90


INV. IN = 5159.54 (W)

INV. IN = 5159.54 (S)


INV. OUT=5159.34 (E)

LIGHT POLE

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MATCH LINE SHEET 25

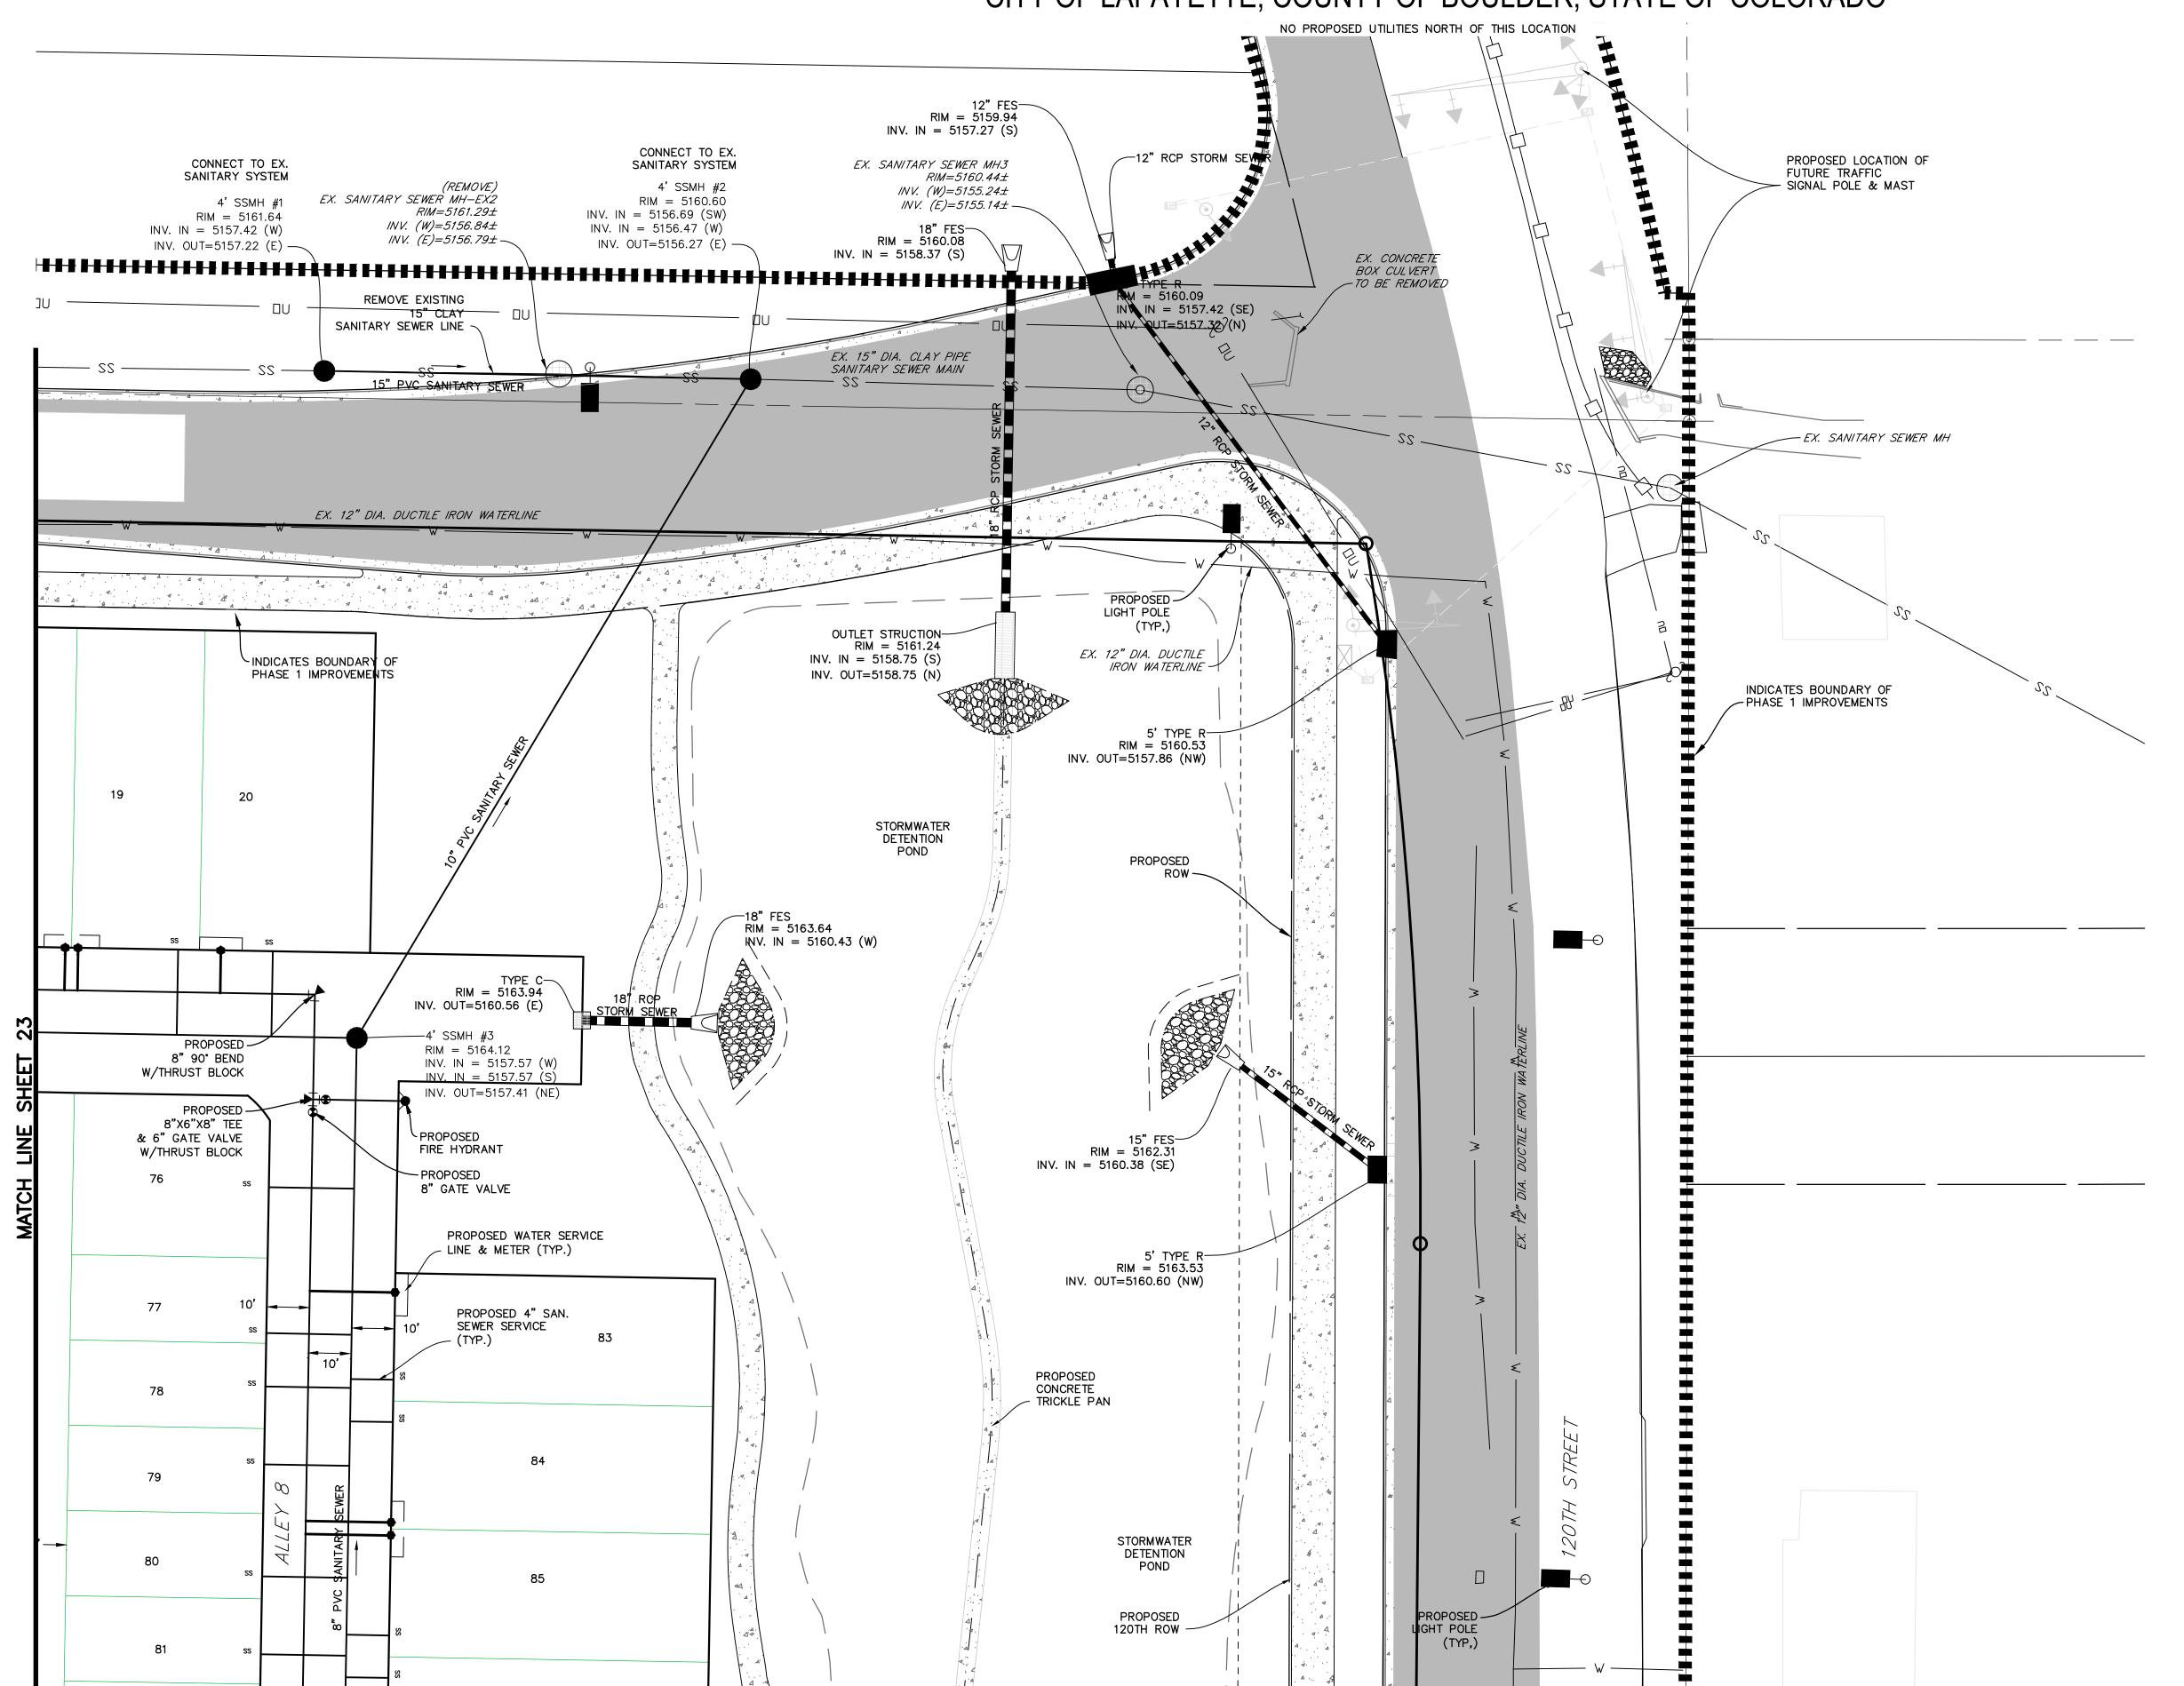

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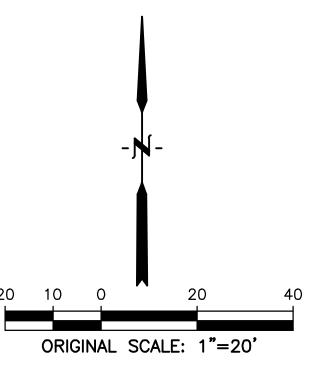
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<u>LEGEND</u>

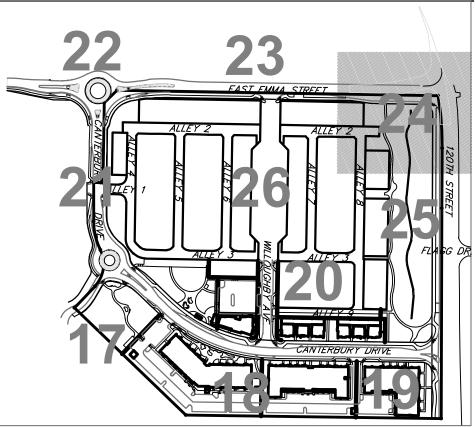PROPERTY LINE .. PROPOSED LOT LINE. PROPOSED ROW EX. SANITARY SEWER. EX. WATER LINE EX. STORM LINE EX. GAS LINE. EX. BURIED ELECTRIC LINE EX. OVERHEAD ELECTRIC LINE EX. CABLE TV. EX. FIRE HYDRANT. EX. WATER VALVE. EX. WATER METER EX. MANHOLE EX. LIGHT POLE EX. UTILITY POLE. PROPOSED LIGHT POLE PROPOSED SANITARY SEWER PROPOSED WATER LINE PROPOSED FIRE HYDRANT PROPOSED WATER VALVE PROPOSED METER. PROPOSED MANHOLE PROPOSED STORM INLET PROPOSED CONCRETE



PROPOSED ASPHALT

NOTE:

1. ALL STORM, SEWER AND WATER MAINS SHALL BE INSTALLED WITH PHASE 1. REFER TO WILLOUGHBY CORNER SUBDIVISION CONSTRUCTION PLANS FOR PLAN & PROFILES, HORIZONTAL LAYOUT, AND CONSTRUCTION LEVEL DETAILS.

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UTILITY

SHEET TITLE:

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BOULDER COUNTY HOUSING

AUTHORITY

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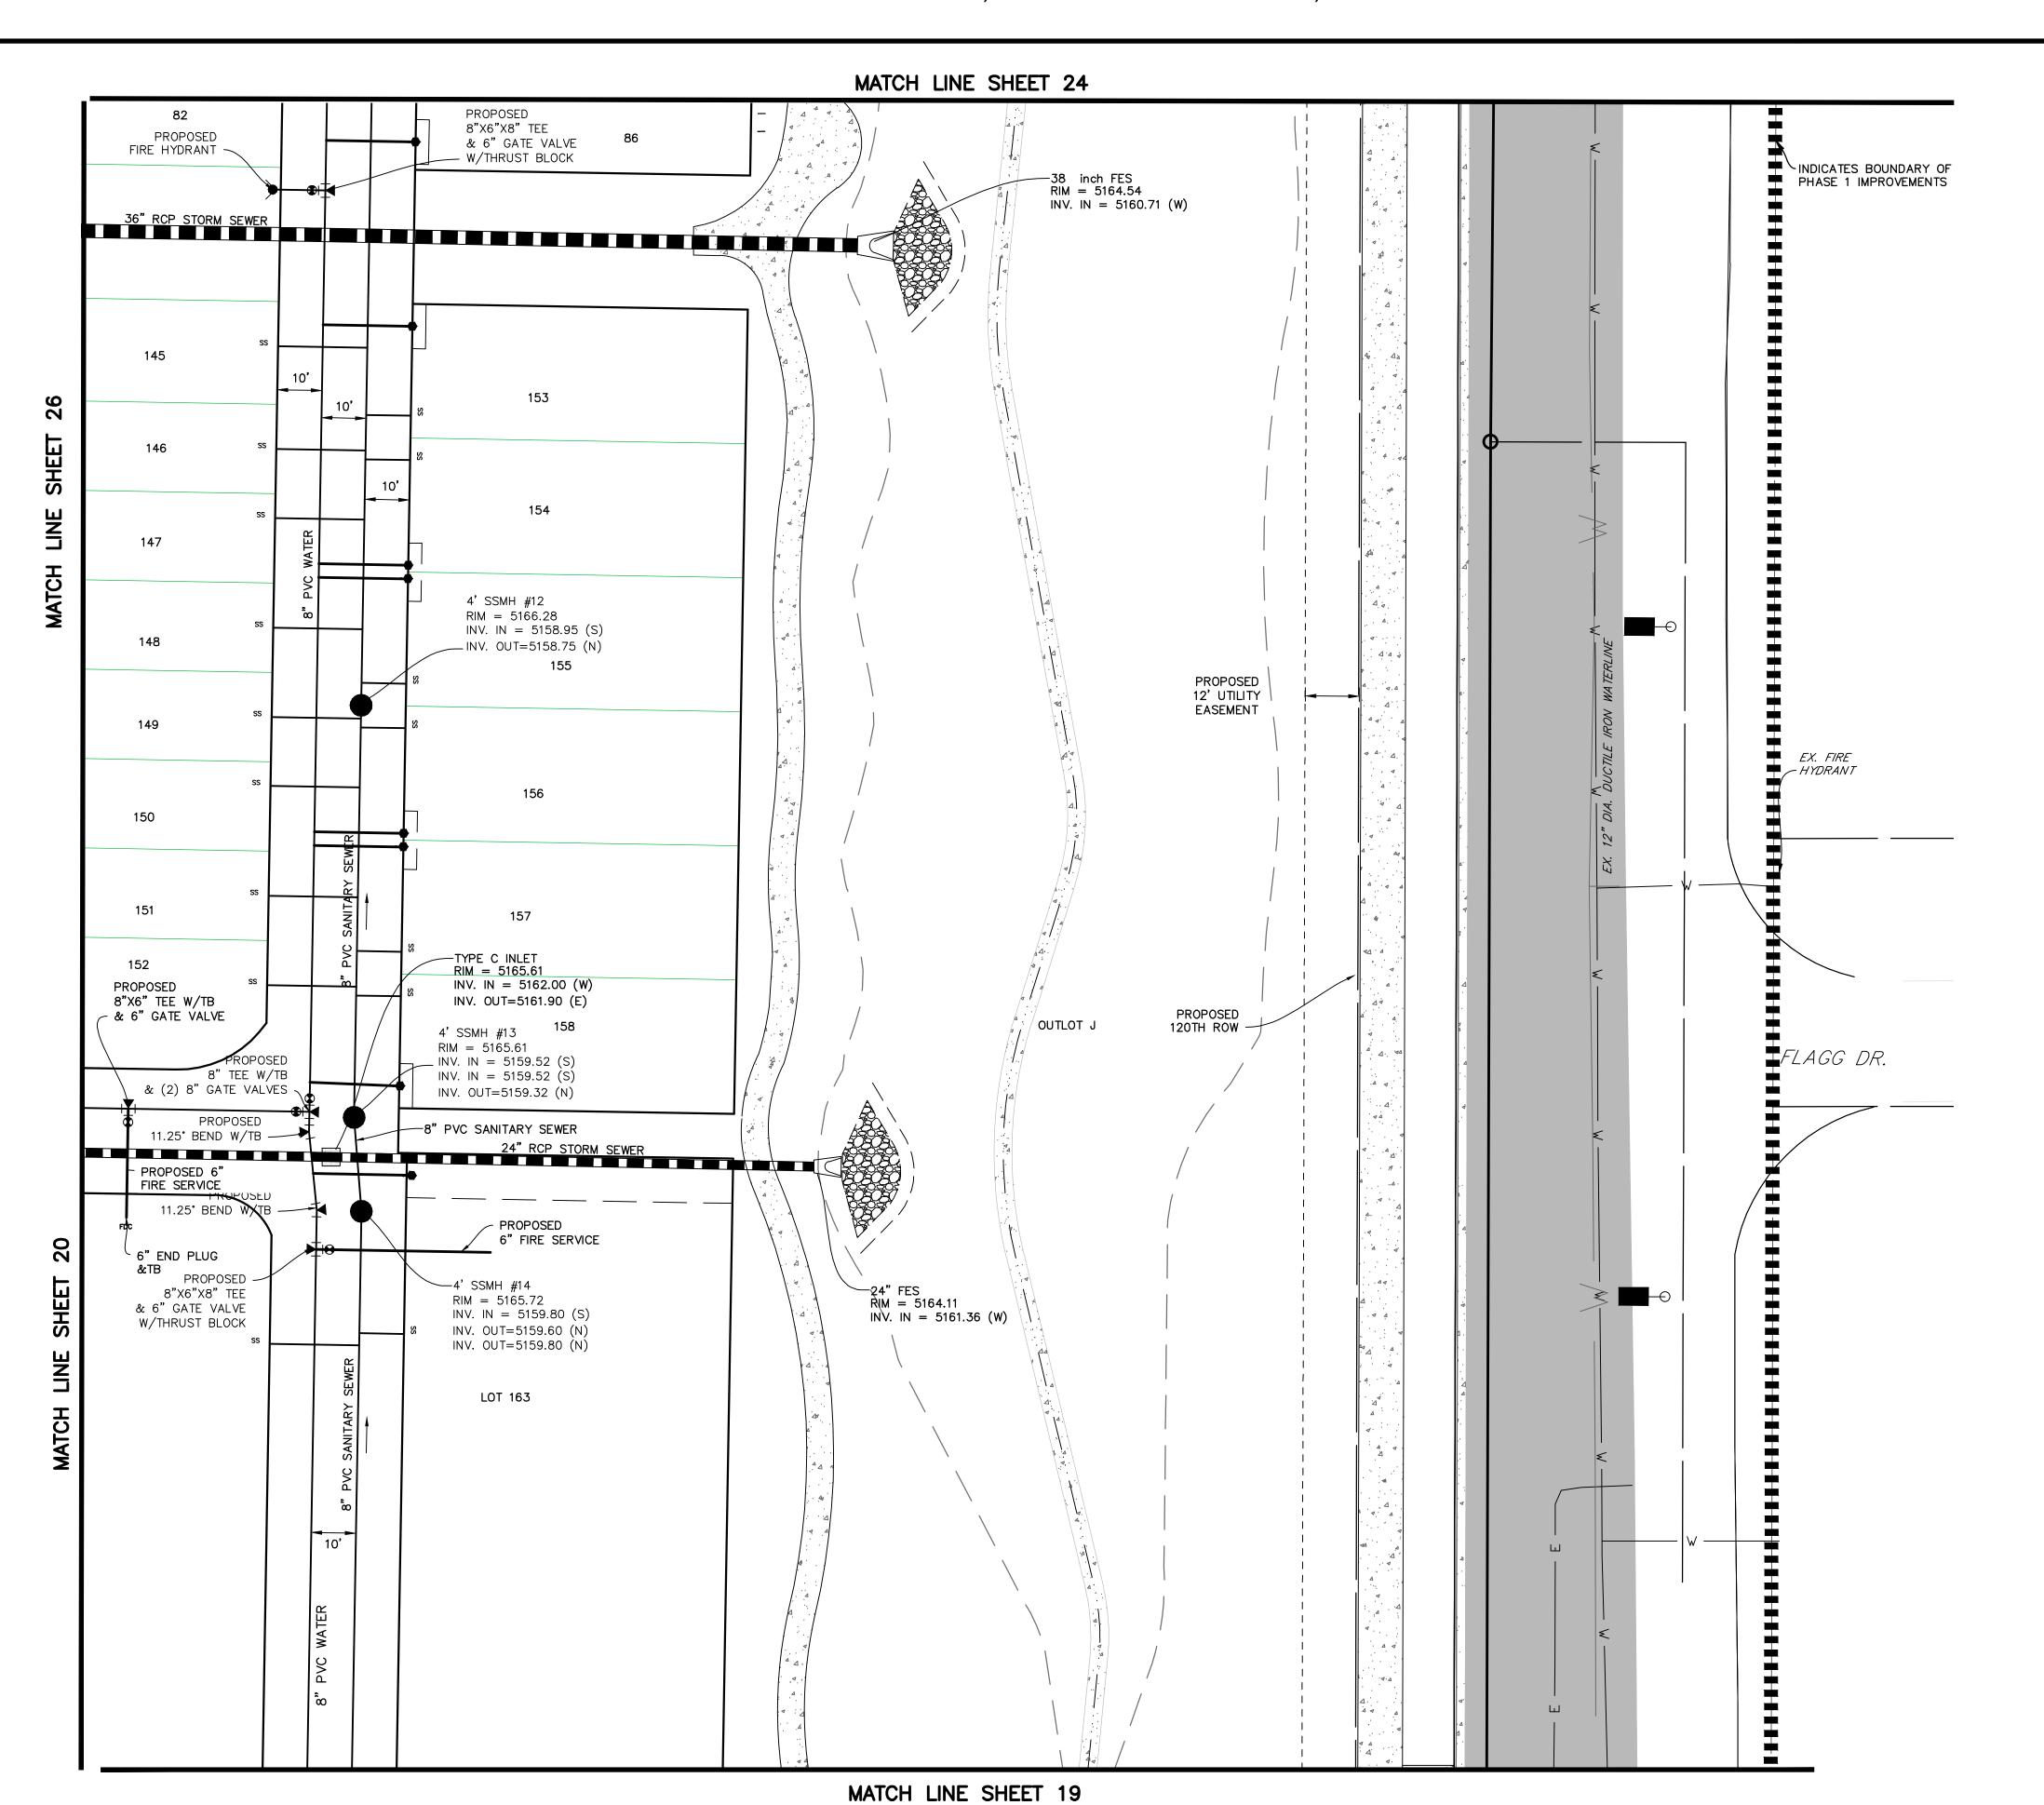
CONTACT: MOLLY CHIANG


DATE:

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LOTS 161, 164, 165, 166 & 167, & OUTLOTS F, I, J, K, L & N OF THE WILLOUGHBY CORNER SUBDIVISION, CITY OF LAFAYETTE, COUNTY OF BOULDER, STATE OF COLORADO





<u>LEGEND</u>

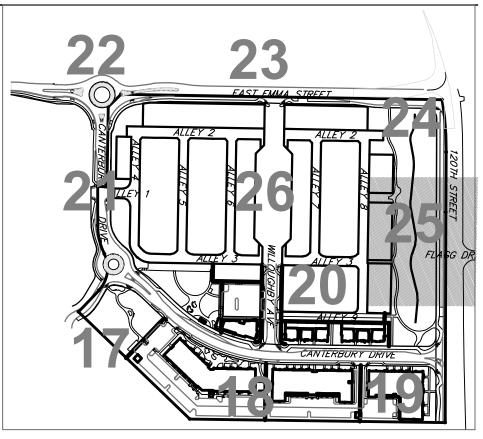PROPERTY LINE.

PROPOSED ROW	
EX. SANITARY SEWER	
EX. WATER LINE	
EX. STORM LINE	
EX. GAS LINE	
EX. BURIED ELECTRIC LINE	
EX. OVERHEAD ELECTRIC LINE	
EX. CABLE TV	
EX. FIRE HYDRANT	
EX. WATER VALVE	
EX. WATER METER	
EX. MANHOLE	_
EX. LIGHT POLE	
EX. UTILITY POLE	•
PROPOSED LIGHT POLE	O
PROPOSED STORM SEWER	
PROPOSED SANITARY SEWER	
PROPOSED WATER LINE	
PROPOSED FIRE HYDRANT	
PROPOSED WATER VALVE	`
PROPOSED METER	
PROPOSED MANHOLE	_
PROPOSED STORM INLET	
PROPOSED CONCRETE	
PROPOSED ASPHALT	

1. ALL STORM, SEWER AND WATER MAINS SHALL BE INSTALLED WITH PHASE 1. REFER TO WILLOUGHBY CORNER SUBDIVISION CONSTRUCTION PLANS FOR PLAN & PROFILES, HORIZONTAL LAYOUT, AND CONSTRUCTION LEVEL DETAILS.

20 10 0

2. BACKFLOW PREVENTION IS REQUIRED FOR ALL IRRIGATION TAPS.

ORIGINAL SCALE: 1"=20'



1101 Bannock Street Denver, Colorado 80204 P 303.892.1166 www.norris-design.com

BOULDER COUNTY HOUSING AUTHORITY 3400 BROADWAY BOULDER, CO - 80304 303.441.3861

CONTACT: MOLLY CHIANG

DATE: 06.17.22 - SITE PLAN 01

09.15.22 - SITE PLAN 02

SHEET TITLE:

UTILITY PLAN

LOTS 161, 164, 165, 166 & 167, & OUTLOTS F, I, J, K, L & N OF THE WILLOUGHBY CORNER SUBDIVISION, CITY OF LAFAYETTE, COUNTY OF BOULDER, STATE OF COLORADO

PROPOSED 4" SAN. SEWER SERVICE

OUTLOT G

130

131

132

133

134

135

140

143

4' STMH RIM = 5169.48

INV. IN = 5162.22 (N)

INV. IN = 5162.32 (W)

INV. OUT=5162.22 (E)

MATCH LINE SHEET 23

8" 45° BEND W/TB

OUTLOT L

PROPOSED 8"X6" TEE W/TB & 6" GATE VALVE

OUTLOT L

PROPOSED

MATCH LINE SHEET 20

8" 45° BEND W/TB

TOWNHOMES

-4 STMH RM = 5 69.51 OUTLOT E

TOWNHOMES

123

125

126

127

128

INV. IN = 5163.22 (N) INV. IN = 5163.22 (W)

INV. OUT=5163.12 (E)

PROPOSED FIRE HYDRANT

115

TOWNHOMES

116

117

118

119

120

121

10'

8"X6" TEE W/TB & 6" GATE VALVE

-4' STMH RIM = 5170.66 INV. N = 5164.07 (N)

INV. DUT=5163.97 (E)

109

111

113

PROPOSED


FIRE HYDRANT

21

OUTLOT D 24" RCP STORM SEWER

PROPOSED

FIRE HYDRANT

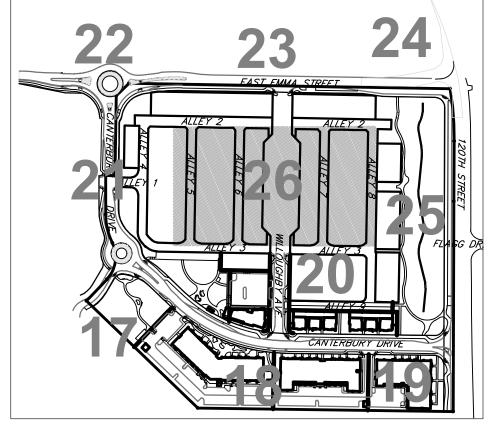

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7)))

<u>LEGEND</u>

PROPERTY LINE. PROPOSED LOT LINE. PROPOSED ROW EX. SANITARY SEWER EX. WATER LINE EX. STORM LINE EX. GAS LINE. EX. BURIED ELECTRIC LINE EX. OVERHEAD ELECTRIC LINE EX. CABLE TV.. EX. FIRE HYDRANT. EX. WATER VALVE. EX. WATER METER EX. MANHOLE . EX. LIGHT POLE EX. UTILITY POLE. PROPOSED LIGHT POLE PROPOSED STORM SEWER. PROPOSED SANITARY SEWER PROPOSED WATER LINE PROPOSED FIRE HYDRANT PROPOSED WATER VALVE PROPOSED METER. PROPOSED MANHOLE PROPOSED STORM INLET PROPOSED CONCRETE 4 PROPOSED ASPHALT

BOULDER COUNTY HOUSING AUTHORITY 3400 BROADWAY BOULDER, CO - 80304 303.441.3861 CONTACT: MOLLY CHIANG

DATE:

06.17.22 - SITE PLAN 01 09.15.22 - SITE PLAN 02

SHEET TITLE:

UTILITY

PLAN

26

ORIGINAL SCALE: 1"=20'

NOTE:

1. ALL STORM, SEWER AND WATER MAINS SHALL BE INSTALLED WITH PHASE 1. REFER TO WILLOUGHBY CORNER SUBDIVISION CONSTRUCTION PLANS FOR PLAN & PROFILES, HORIZONTAL LAYOUT, AND CONSTRUCTION LEVEL DETAILS.

2. BACKFLOW PREVENTION IS REQUIRED FOR ALL IRRIGATION TAPS.

LOTS 161, 164, 165, 166 & 167, & OUTLOTS F, I, J, K, L & N OF THE WILLOUGHBY CORNER SUBDIVISION, CITY OF LAFAYETTE, COUNTY OF BOULDER, STATE OF COLORADO

GENERAL NOTES

- 1. THESE PLANS SHALL NOT BE UTILIZED FOR CONSTRUCTION OR PERMITTING UNLESS STATED FOR SUCH USE IN THE TITLE BLOCK
- 2. DRAWINGS ARE INTENDED TO BE PRINTED ON 24" X 36" PAPER. PRINTING THESE DRAWINGS AT A DIFFERENT SIZE WILL IMPACT THE SCALE. VERIFY THE GRAPHIC SCALE BEFORE REFERENCING ANY MEASUREMENTS ON THESE SHEETS. THE RECIPIENT OF THESE DRAWINGS SHALL BE RESPONSIBLE FOR ANY ERRORS RESULTING FROM INCORREC PRINTING, COPYING, OR ANY OTHER CHANGES THAT ALTER THE SCALE OF THE DRAWINGS
- VERIFY ALL PLAN DIMENSIONS PRIOR TO START OF CONSTRUCTION. NOTIFY THE OWNER'S REPRESENTATIVE TO ADDRESS ANY QUESTIONS OR CLARIFY ANY DISCREPANCIES.
- WRITTEN DIMENSIONS TAKE PRECEDENCE OVER SCALED DIMENSIONS
- SUBMIT A CHANGE ORDER FOR APPROVAL FOR ANY CHANGES TO WORK SCOPE RESULTING FROM FIELD CONDITIONS OR DIRECTION BY OWNER'S REPRESENTATIVE WHICH REQUIRE ADDITIONAL COST TO THE OWNER PRIOR TO PERFORMANCE OF WORK
- 6. THE CONTRACTOR SHALL PROVIDE A STAKED LAYOUT OF ALL SITE IMPROVEMENTS FOR INSPECTION BY THE OWNER'S REPRESENTATIVE AND MAKE MODIFICATIONS AS REQUIRED ALL LAYOUT INFORMATION IS AVAILABLE IN DIGITAL FORMAT FOR USE BY THE CONTRACTOR
- IF A GEOTECHNICAL SOILS REPORT IS NOT AVAILABLE AT THE TIME OF CONSTRUCTION, NORRIS DESIGN RECOMMENDS A REPORT BE AUTHORIZED BY THE OWNER AND THAT ALL RECOMMENDATIONS OF THE REPORT ARE FOLLOWED DURING CONSTRUCTION. THE CONTRACTOR SHALL USE THESE CONTRACT DOCUMENTS AS A BASIS FOR THE BID. IF THE OWNER ELECTS TO PROVIDE A GEOTECHNICAL REPORT, THE CONTRACTOR SHALL REVIEW THE REPORT AND SUBMIT AN APPROPRIATE CHANGE ORDER TO THE OWNER'S REPRESENTATIVE IF ADDITIONAL COSTS ARE REQUESTED
- 8. CONTRACTOR SHALL CONFIRM THAT SITE CONDITIONS ARE SIMILAR TO THE PLANS, WITHIN TOLERANCES STATED IN THE CONTRACT DOCUMENTS. AND SATISFACTORY TO THE CONTRACTOR PRIOR TO START OF WORK. SHOULD SITE CONDITIONS BE DIFFERENT THAN REPRESENTED ON THE PLANS OR UNSATISFACTORY TO THE CONTRACTOR, THE CONTRACTOR SHALL CONTACT THE OWNER'S REPRESENTATIVE FOR CLARIFICATION AND FURTHER DIRECTION
- 9. CONTRACTOR IS RESPONSIBLE TO PAY FOR, AND OBTAIN, ANY REQUIRED APPLICATIONS, PERMITTING, LICENSES, INSPECTIONS AND METERS ASSOCIATED WITH WORK
- 10. THE CONTRACTOR SHALL BE RESPONSIBLE FOR ANY FINES OR PENALTIES ASSESSED TO THE OWNER RELATING TO ANY VIOLATIONS OR NON-CONFORMANCE WITH THE PLANS SPECIFICATIONS, CONTRACT DOCUMENTS, JURISDICTIONAL CODES, AND REGULATORY AGENCIES
- 11. THE CONTRACTOR SHALL BE RESPONSIBLE FOR COORDINATION OF ALL UTILITY LOCATES PRIOR TO ANY EXCAVATION. REFER TO ENGINEERING UTILITY PLANS FOR ALL PROPOSED UTILITY LOCATIONS AND DETAILS. NOTIFY OWNER'S REPRESENTATIVE IF EXISTING OR PROPOSED UTILITIES INTERFERE WITH THE ABILITY TO PERFORM WORK.
- 12. UNLESS IDENTIFIED ON THE PLANS FOR DEMOLITION OR REMOVAL, THE CONTRACTOR IS RESPONSIBLE FOR THE COST TO REPAIR UTILITIES, ADJACENT OR EXISTING LANDSCAPE, ADJACENT OR EXISTING PAVING, OR ANY PUBLIC AND PRIVATE PROPERTY THAT IS DAMAGED BY THE CONTRACTOR OR THEIR SUBCONTRACTOR'S OPERATIONS DURING INSTALLATION, ESTABLISHMENT OR DURING THE SPECIFIED MAINTENANCE PERIOD. ALL DAMAGES SHALL BE REPAIRED TO PRE-CONSTRUCTION CONDITIONS AS DETERMINED BY THE OWNER'S REPRESENTATIVE. CONTRACTOR SHALL BE RESPONSIBLE FOR LOGGING ANY DAMAGES PRIOR TO START OF CONSTRUCTION AND DURING THE CONTRACT PERIOD.
- 13. ALL WORK SHALL BE CONFINED TO THE AREA WITHIN THE CONSTRUCTION LIMITS AS SHOWN ON THE PLANS. ANY AREAS OR IMPROVEMENTS DISTURBED OUTSIDE THESE LIMITS SHALL BE RETURNED TO THEIR ORIGINAL CONDITION AT THE CONTRACTOR'S EXPENSE. IN THE EVENT THE CONTRACTOR REQUIRES A MODIFICATION TO THE CONSTRUCTION LIMITS, WRITTEN PERMISSION MUST BE OBTAINED FROM THE OWNER'S REPRESENTATIVE PRIOR TO ANY DISTURBANCE OUTSIDE OF THE LIMITS OF WORK.
- 14. THE CONTRACTOR SHALL BE RESPONSIBLE FOR THE REPAIR OF ANY OF THEIR TRENCHES OR EXCAVATIONS THAT SETTLE.
- 15. THE CONTRACTOR SHALL BE RESPONSIBLE TO PREPARE AND SUBMIT A TRAFFIC CONTROL PLAN TO THE APPROPRIATE JURISDICTIONAL AGENCIES AND THE OWNER'S REPRESENTATIVE IF THEIR WORK AND OPERATIONS AFFECT OR IMPACT THE PUBLIC RIGHTS-OF-WAY. OBTAIN APPROVAL PRIOR TO ANY WORK WHICH AFFECTS OR IMPACTS THE PUBLIC RIGHTS-OF-WAY. THE CONTRACTOR SHALL BE RESPONSIBLE FOR ANY FINES OR PENALTIES ASSESSED TO THE OWNER RELATING TO THIS REQUIREMENT DURING THE CONTRACT PERIOD.
- 16. SIGHT TRIANGLES AND SIGHT LINES SHALL REMAIN UNOBSTRUCTED BY EQUIPMENT CONSTRUCTION MATERIALS, PLANT MATERIAL OR ANY OTHER VISUAL OBSTACLE DURING THE CONTRACT PERIOD AND AT MATURITY OF PLANTS PER LOCAL JURISDICTIONAL REQUIREMENTS. NO PLANT MATERIAL OTHER THAN GROUND COVER IS ALLOWED TO BE PLANTED ADJACENT TO FIRE HYDRANTS AS STIPULATED BY JURISDICTIONAL REQUIREMENTS.
- 17. COORDINATE SITE ACCESS, STAGING, STORAGE AND CLEANOUT AREAS WITH OWNER'S REPRESENTATIVE.
- 18. CONTRACTOR IS RESPONSIBLE FOR PROVIDING TEMPORARY SAFETY FENCING AND BARRIERS AROUND ALL IMPROVEMENTS SUCH AS WALLS, PLAY STRUCTURES, EXCAVATIONS, ETC. ASSOCIATED WITH THEIR WORK UNTIL SUCH FACILITIES ARE COMPLETELY INSTALLED PER THE PLANS, SPECIFICATIONS AND MANUFACTURER'S RECOMMENDATIONS.
- 19. CONTRACTOR SHALL BE RESPONSIBLE FOR PROTECTION OF THEIR MATERIAL STOCK PILES AND WORK FROM VANDALISM, EROSION OR UNINTENDED DISTURBANCE DURING THE CONSTRUCTION PERIOD AND UNTIL FINAL ACCEPTANCE IS ISSUED.

- 20. THE CONTRACTOR SHALL KNOW, UNDERSTAND AND ABIDE BY ANY STORM WATER POLLUTION PREVENTION PLAN (SWPPP) ASSOCIATED WITH THE SITE. IF A STORM WATER POLLUTION PREVENTION PLAN IS NOT PROVIDED BY THE OWNER'S REPRESENTATIVE, REQUEST A COPY BEFORE PERFORMANCE OF ANY SITE WORK.
- 21. MAINTAIN ANY STORM WATER MANAGEMENT FACILITIES THAT EXIST ON SITE FOR FULL FUNCTIONALITY. THE CONTRACTOR SHALL INSTALL AND MAINTAIN ANY NEW STORM WATER MANAGEMENT FACILITIES THAT ARE IDENTIFIED IN THE SCOPE OF WORK TO FULL FUNCTIONALITY. THE CONTRACTOR SHALL BE RESPONSIBLE FOR ANY FINES OR PENALTIES ASSESSED TO THE OWNER FOR FAILURE TO MAINTAIN STORM WATER MANAGEMENT FACILITIES DURING THE CONTRACT PERIOD.
- 22. THE CONTRACTOR SHALL PREVENT SEDIMENT, DEBRIS AND ALL OTHER POLLUTANTS FROM CONSTRUCTION OPERATIONS THAT ARE PART OF THIS PROJECT. THE CONTRACTOR SHALL BE RESPONSIBLE FOR ANY FINES OR PENALTIES ASSESSED TO THE OWNER RELATING TO THESE REQUIREMENTS DURING THEIR CONTRACTED COURSE OF WORK.
- 23. THE CONTRACTOR SHALL BE RESPONSIBLE TO PREVENT ANY IMPACTS TO ADJACENT WATERWAYS, WETLANDS, OR OTHER ENVIRONMENTALLY SENSITIVE AREAS RESULTING FROM WORK DONE AS PART OF THIS PROJECT. THE CONTRACTOR SHALL BE RESPONSIBLE FOR ANY FINES OR PENALTIES ASSESSED TO THE OWNER RELATING TO THESE STANDARDS DURING THEIR CONTRACTED COURSE OF WORK
- 24. THE CONTRACTOR AND/OR THEIR AUTHORIZED AGENTS SHALL INSURE THAT ALL LOADS OF CONSTRUCTION MATERIAL IMPORTED TO OR EXPORTED FROM THE PROJECT SITE SHALL BE PROPERLY COVERED TO PREVENT LOSS OF MATERIAL DURING TRANSPORT TRANSPORTATION METHODS ON PUBLIC RIGHT-OF WAYS SHALL CONFORM TO JURISDICTIONAL REQUIREMENTS. THE CONTRACTOR SHALL BE RESPONSIBLE FOR ANY FINES. OR PENALTIES ASSESSED TO THE OWNER RELATING TO THESE REQUIREMENTS
- 25. THE CLEANING OF EQUIPMENT IS PROHIBITED AT THE JOB SITE UNLESS AUTHORIZED BY THE OWNER'S REPRESENTATIVE IN A DESIGNATED AREA. THE DISCHARGE OF WATER, WASTE CONCRETE, POLLUTANTS, OR OTHER MATERIALS SHALL ONLY OCCUR IN AREAS DESIGNED FOR SUCH USE AND APPROVED BY THE OWNER'S REPRESENTATIVE
- 26. THE CLEANING OF CONCRETE EQUIPMENT IS PROHIBITED AT THE JOB SITE EXCEPT IN DESIGNATED CONCRETE WASHOUT AREAS. THE DISCHARGE OF WATER CONTAINING WASTE CONCRETE IN THE STORM SEWER IS PROHIBITED
- 27. OPEN SPACE SWALES: IF SWALES ARE EXISTING ON SITE AND ARE NOT INTENDED TO BE MODIFIED AS PART OF THE PLANS. THE CONTRACTOR SHALL BE RESPONSIBLE TO MAINTAIN THE CONVEYANCE OF WATER WITHIN THE SWALES DURING THE CONTRACT PERIOD. THE CONTRACTOR SHALL BE RESPONSIBLE FOR ANY DIVERSION OR PUMPING OF WATER IF REQUIRED TO COMPLETE WORK. ANY SWALES DISTURBED BY THE CONTRACTOR SHALL BE REPAIRED/RESTORED TO THEIR ORIGINAL CONDITION. IF THE SWALE NEEDS TO BE DISTURBED OR MODIFIED FOR ANY REASON, THE CONTRACTOR SHALL NOTIFY THE OWNER'S REPRESENTATIVE FOR APPROVAL PRIOR TO DISTURBANCE.
- 28. DETENTION AND WATER QUALITY PONDS: IF DETENTION PONDS AND WATER QUALITY PONDS ARE EXISTING ON SITE AND ARE NOT INTENDED TO BE MODIFIED AS PART OF THE PLANS, THE CONTRACTOR SHALL MINIMIZE DISTURBANCE TO THE PONDS, DRAINAGE STRUCTURES AND SPILLWAYS DURING CONSTRUCTION. ALL PONDS, DRAINAGE STRUCTURES AND SPILLWAYS SHALL BE MAINTAINED IN OPERABLE CONDITIONS AT ALL TIMES. ANY POND OR SPILLWAY AREAS DISTURBED BY THE CONTRACTOR SHALL BE REPAIRED/RESTORED TO THEIR ORIGINAL CONDITION. IF THE POND NEEDS TO BE DISTURBED OR MODIFIED FOR ANY REASON, THE CONTRACTOR SHALL NOTIFY THE OWNER'S REPRESENTATIVE FOR APPROVAL PRIOR TO DISTURBANCE.
- 29. MAINTENANCE ACCESS BENCHES: IF MAINTENANCE BENCHES OR ACCESS ROADS EXIST ON SITE AND ARE NOT INTENDED TO BE MODIFIED AS PART OF THE PLANS. THE CONTRACTOR SHALL MINIMIZE DISTURBANCE TO THE BENCHES OR ACCESS ROADS DURING CONSTRUCTION. ANY BENCHES OR ACCESS ROADS DISTURBED BY THE CONTRACTOR SHALL BE REPAIRED/RESTORED TO THEIR ORIGINAL CONDITION. THE CONTRACTOR SHALL MAINTAIN ACCESS TO ALL EXISTING BENCHES AND ACCESS ROADS DURING THE CONSTRUCTION PERIOD. IF ACCESS NEEDS TO BE BLOCKED FOR ANY REASON, THE CONTRACTOR SHALL NOTIFY THE OWNER'S REPRESENTATIVE FOR APPROVAL PRIOR TO INTERRUPTION OF ACCESS.
- 30. LOCAL, STATE AND FEDERAL JURISDICTIONAL REQUIREMENTS, RESTRICTIONS OR PROCEDURES SHALL SUPERSEDE THESE PLANS, NOTES AND SPECIFICATIONS WHEN MORE STRINGENT. NOTIFY THE OWNER'S REPRESENTATIVE IF CONFLICTS OCCUR.

LANDSCAPE NOTES

- THE CONTRACTOR SHALL FOLLOW THE LANDSCAPE PLANS AND SPECIFICATIONS AS WITHOUT APPROVAL OF THE OWNER'S REPRESENTATIVE. OVERALL PLANT QUANTITY AND QUALITY SHALL BE CONSISTENT WITH THE PLANS.
- THE CONTRACTOR IS RESPONSIBLE FOR VERIFYING ALL PLANT QUANTITIES. GRAPHIC QUANTITIES TAKES PRECEDENCE OVER WRITTEN QUANTITIES
- THE OWNER'S REPRESENTATIVE RESERVES THE RIGHT TO INSPECT AND TAG ALL PLANT MAY REJECT PLANT MATERIAL AT THE SITE IF MATERIAL IS DAMAGED. DISEASED. OR DECLINING IN HEALTH AT THE TIME OF ONSITE INSPECTIONS OR IF THE PLANT MATERIAL DOES NOT MEET THE MINIMUM SPECIFIED STANDARD IDENTIFIED ON THE PLANS AND IN THE SPECIFICATIONS. THE CONTRACTOR SHALL COORDINATE WITH THE OWNER'S REPRESENTATIVE FOR INSPECTION AND APPROVAL OF ALL MATERIALS AND PRODUCTS PRIOR TO INSTALLATION.
- THE OWNER'S REPRESENTATIVE MAY ELECT TO UPSIZE PLANT MATERIAL AT THEIR DISCRETION BASED ON SELECTION, AVAILABILITY, OR TO ENHANCE SPECIFIC AREAS OF THE PROJECT. THE CONTRACTOR SHALL VERIFY PLANT MATERIAL SIZES WITH OWNER'S REPRESENTATIVE PRIOR TO PURCHASING, SHIPPING OR STOCKING OF PLANT MATERIALS SUBMIT CHANGE ORDER REQUEST TO OWNER'S REPRESENTATIVE FOR APPROVAL IF ADDITIONAL COST IS REQUESTED BY THE CONTRACTOR PRIOR TO INSTALLATION RE-STOCKING CHARGES WILL NOT BE APPROVED IF THE CONTRACTOR FAILS TO SUBMIT A REQUEST FOR MATERIAL CHANGES
- THE CONTRACTOR SHALL WARRANTY ALL CONTRACTED WORK AND MATERIALS FOR A PERIOD OF ONE YEAR AFTER SUBSTANTIAL COMPLETION HAS BEEN ISSUED BY THE OWNER'S REPRESENTATIVE FOR THE ENTIRE PROJECT UNLESS OTHERWISE SPECIFIED IN THE CONTRACT DOCUMENTS OR SPECIFICATIONS.
- REFER TO IRRIGATION PLANS FOR LIMITS AND TYPES OF IRRIGATION DESIGNED FOR THE LANDSCAPE. IN NO CASE SHALL IRRIGATION BE EMITTED WITHIN THE MINIMUM DISTANCE FROM BUILDING OR WALL FOUNDATIONS AS STIPULATED IN THE GEOTECHNICAL REPORT. ALL IRRIGATION DISTRIBUTION LINES, HEADS AND EMITTERS SHALL BE KEPT OUTSIDE THE MINIMUM DISTANCE AWAY FROM ALL BUILDING AND WALL FOUNDATIONS AS STIPULATED IN THE GEOTECHNICAL REPORT.
- LANDSCAPE MATERIAL LOCATIONS SHALL HAVE PRECEDENCE OVER IRRIGATION MAINLINE AND LATERAL LOCATIONS. COORDINATE INSTALLATION OF IRRIGATION EQUIPMENT SO THAT IT DOES NOT INTERFERE WITH THE PLANTING OF TREES OR OTHER LANDSCAPE
- THE LANDSCAPE CONTRACTOR SHALL BE RESPONSIBLE FOR ENSURING POSITIVE DRAINAGE EXISTS IN ALL LANDSCAPE AREAS. SURFACE DRAINAGE ON LANDSCAPE AREAS SHALL NOT FLOW TOWARD STRUCTURES AND FOUNDATIONS. MAINTAIN SLOPE AWAY FROM FOUNDATIONS PER THE GEOTECHNICAL REPORT RECOMMENDATIONS. ALL LANDSCAPE AREAS BETWEEN WALKS AND CURBS SHALL DRAIN FREELY TO THE CURB UNLESS OTHERWISE IDENTIFIED ON THE GRADING PLAN. IN NO CASE SHALL THE GRADE, TURF THATCH. OR OTHER LANDSCAPE MATERIALS DAM WATER AGAINST WALKS. MINIMUM SLOPES ON LANDSCAPE AREAS SHALL BE 2%; MAXIMUM SLOPE SHALL BE 25% UNLESS SPECIFICALLY IDENTIFIED ON THE PLANS OR APPROVED BY THE OWNER'S REPRESENTATIVE.
- PRIOR TO INSTALLATION OF PLANT MATERIALS, AREAS THAT HAVE BEEN COMPACTED OR DISTURBED BY CONSTRUCTION ACTIVITY SHALL BE THOROUGHLY LOOSENED TO A DEPTH OF 8" - 12" AND AMENDED PER SPECIFICATIONS.
- 10. ALL LANDSCAPED AREAS ARE TO RECEIVE ORGANIC SOIL PREPARATION AT 4 cu.yrds/1,000sf OR AS NOTED IN THE TECHNICAL SPECIFICATIONS.
- 11. TREES SHALL NOT BE LOCATED IN DRAINAGE SWALES. DRAINAGE AREAS. OR UTILITY EASEMENTS. CONTACT OWNER'S REPRESENTATIVE FOR RELOCATION OF PLANTS IN QUESTIONABLE AREAS PRIOR TO INSTALLATION.
- 12. THE CENTER OF EVERGREEN TREES SHALL NOT BE PLACED CLOSER THAN 8' AND THE CENTER OF ORNAMENTAL TREES CLOSER THAN 6' FROM A SIDEWALK, STREET OR DRIVE LANE. EVERGREEN TREES SHALL NOT BE LOCATED ANY CLOSER THAN 15' FROM IRRIGATION ROTOR HEADS. NOTIFY OWNER'S REPRESENTATIVE IF TREE LOCATIONS CONFLICT WITH THESE STANDARDS FOR FURTHER DIRECTION.
- 13. ALL EVERGREEN TREES SHALL BE FULLY BRANCHED TO THE GROUND AND SHALL NOT EXHIBIT SIGNS OF ACCELERATED GROWTH AS DETERMINED BY THE OWNER'S
- 14. ALL TREES ARE TO BE STAKED AND GUYED PER DETAILS FOR A PERIOD OF 1 YEAR. THE CONTRACTOR SHALL BE RESPONSIBLE FOR REMOVING STAKES AT THE END OF 1 YEAR FROM ACCEPTANCE OF LANDSCAPE INSTALLATION BY THE OWNER'S REPRESENTATIVE. OBTAIN APPROVAL BY OWNER'S REPRESENTATIVE PRIOR TO REMOVAL
- 15. ALL TREES INSTALLED ABOVE RETAINING WALLS UTILIZING GEO-GRID MUST BE HAND DUG TO PROTECT GEO-GRID. IF GEO-GRID MUST BE CUT TO INSTALL TREES, APPROVAL MUST BE GIVEN BY OWNER'S REPRESENTATIVE PRIOR TO DOING WORK.
- 16. TREE WRAP SHALL BE APPLIED IN LATE FALL AFTER INSTALLATION AND REMOVED THE FOLLOWING SPRING. TREES GREATER THEN 4" IN CALIPER MAY NOT REQUIRE TREE WRAP

IF BARK IS SUFFICIENTLY DEVELOPED. OBTAIN APPROVAL FROM OWNER'S REPRESENTATIVE FOR ANY TREES THAT WILL NOT BE WRAPPED.

ALL TREES IN SEED OR TURF AREAS SHALL RECEIVE MULCH RINGS. OBTAIN APPROVAL FROM OWNER'S REPRESENTATIVE FOR ANY TREES THAT WILL NOT BE MULCHED FOR EXCESSIVE MOISTURE REASONS

- SHRUB, GROUNDCOVER AND PERENNIAL BEDS ARE TO BE CONTAINED BY 4" x 14 GAUGE GREEN, ROLL TOP, INTERLOCKING TYPE EDGER, RYERSON OR EQUAL. EDGER IS NOT REQUIRED WHEN ADJACENT TO CURBS, WALLS, WALKS OR SOLID FENCES WITHIN 3" OF PRE-MULCHED FINAL GRADE. EDGER SHALL NOT BE REQUIRED TO SEPARATE MULCH TYPES UNLESS SPECIFIED ON THE PLANS.
- IN ALL CASES SHRUB, GROUNDCOVER AND PERENNIAL BEDS ADJACENT TO BUILDING AND WALL FOUNDATIONS SHALL BE CONTAINED BY 14 GAUGE GREEN, ROLL TOP, INTERLOCKING TYPE PERFORATED EDGER, RYERSON OR EQUAL. EDGER SHALL NOT RESTRICT THE FREE FLOW OF DRAINAGE OR DAM WATER IN ANY CASE. EDGER IS NOT REQUIRED WHEN ADJACENT TO CURBS, WALLS, WALKS OR SOLID FENCES WITHIN 3" OF PRE-MULCHED FINAL GRADE. EDGER SHALL NOT BE REQUIRED TO SEPARATE MULCH TYPES UNLESS SPECIFIED ON THE PLANS.
- 20. ALL SHRUB BEDS ARE TO BE MULCHED WITH MIN. 3" DEPTH, 1-2" ROCK MULCH OR 4-6" ROCK MULCH OVER SPECIFIED GEOTEXTILE WEED CONTROL FABRIC. REFER TO PLANS FOR LOCATIONS. ALL GROUND COVER AND PERENNIAL FLOWER BEDS SHALL BE MULCHED WITH 3" DEPTH 1-2" ROCK MULCH. NO WEED CONTROL FABRIC IS REQUIRED IN GROUNDCOVER OR PERENNIAL AREAS
- AT SEED AREA BOUNDARIES ADJACENT TO EXISTING NATIVE AREAS, OVERLAP ABUTTING NATIVE AREAS BY THE FULL WIDTH OF THE SEEDER.
- 22. CONTRACTOR SHALL OVER SEED ALL MAINTENANCE OR SERVICE ACCESS BENCHES AND ROADS WITH SPECIFIED SEED MIX UNLESS OTHERWISE NOTED ON THE PLANS.
- ALL SEEDED SLOPES EXCEEDING 25% IN GRADE (4:1) SHALL RECEIVE EROSION CONTROL BLANKETS. PRIOR TO INSTALLATION, NOTIFY OWNER'S REPRESENTATIVE FOR APPROVAL OF LOCATION AND ANY ADDITIONAL COST IF A CHANGE ORDER IS NECESSARY
- 24. WHEN COMPLETE. ALL GRADES SHALL BE WITHIN +/- 1/8" OF FINISHED GRADES AS SHOWN ON THE PLANS.
- 25. SOFT SURFACE TRAILS NEXT TO MANICURED TURF OR SHRUB BEDS SHALL BE CONTAINED WITH 4" x 14 GAUGE GREEN ROLL TOP EDGER, RYERSON OR EQUAL
- 26. THE DEVELOPER, HIS SUCCESSORS AND ASSIGNS SHALL BE RESPONSIBLE FOR THE INSTALLATION, MAINTENANCE AND REPLACEMENT OF ALL IMPROVEMENTS SHOWN OR INDICATED ON THE APPROVED LANDSCAPE PLAN ON FILE IN THE PLANNING DEPARTMENT.

LANDSCAPE SHEET INDEX

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IRRIGATION DETAILS

NORRIS DESIGN

> 1101 Bannock Street Denver, Colorado 80204 P 303.892.1166 www.norris-design.com

09.15.22 - SITE PLAN 02

SHEET TITLE: LANDSCAPE NOTES



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BOULDER COUNTY HOUSING AUTHORITY 3400 BROADWAY BOULDER, CO - 80304

303.441.3861 CONTACT: MOLLY CHIANG

DATE: 06.17.22 - SITE PLAN 01

09.15.22 - SITE PLAN 02

SHEET TITLE: LANDSCAPE SCHEDULE

WILLOUGHBY CORNER SITE PLAN - PHASE 1

LOTS 161, 164, 165, 166 & 167, & OUTLOTS F, I, J, K, L & N OF THE WILLOUGHBY CORNER SUBDIVISION, CITY OF LAFAYETTE, COUNTY OF BOULDER, STATE OF COLORADO

PLANT SCHEDULE	SITEPL	AN-30SC						MA DO	MALUS X 'DOLGO'	DOLGO CRABAPPLE	B & B	1.5"CAL	16
DECIDUOUS TREES	CODE	BOTANICAL NAME	COMMON NAME	<u>ROOT</u>	<u>SIZE</u>	<u>QTY</u>	(*)	MA RB	MALUS X `RED BARRON`	RED BARRON CRAB APPLE	B & B	1.5"CAL	2
	CA HI	CATALPA SPECIOSA `HIAWATHA 2` TM	HEARTLAND NORTHERN CATALPA	B & B	2"CAL	10		MA TH	MALUS X 'THUNDERCHILD'	THUNDERCHILD CRAB APPLE	B & B	1.5"CAL	1
	CE CH	CELTIS OCCIDENTALIS 'CHICAGOLAND'	CHICAGOLAND HACKBERRY	B & B	2"CAL	22		PR CH	PRUNUS X VIRGINIANA `P002`	SUCKER PUNCH CANADA CHOKECHERRY	B & B	1.5"CAL	7
	GL IM	GLEDITSIA TRIACANTHOS INERMIS 'IMPERIAL'	IMPERIAL HONEYLOCUST	B & B	2"CAL	25		SY RE	SYRINGA RETICULATA	JAPANESE TREE LILAC	B & B	6` HEIGHT	9
	GY DI	GYMNOCLADUS DIOICA 'ESPRESSO'	KENTUCKY COFFEETREE	B & B	2"CAL	25	DECIDUOUS SHRUBS	CODE	BOTANICAL NAME	COMMON NAME	ROOT	SIZE	QTY
£ 0 }}	PO AC	POPULUS X ACUMINATA	LANCELEAF POPLAR	B & B	2"CAL	8		BE CP	BERBERIS THUNBERGII `CRIMSON PYGMY`	CRIMSON PYGMY BARBERRY	CONT	5 GAL	357
·	QU MA	QUERCUS MACROCARPA	BURR OAK	B & B	2"CAL	15	Exercises &	CE IN	CERCOCARPUS INTRICATUS	LITTLE LEAF MOUNTAIN MAHOGONY	CONT	5 GAL	6
	QU MU	QUERCUS MUEHLENBERGII	CHINKAPIN OAK	B & B	2"CAL	11		CH SS	CHAENOMELES SPECIOSA 'SCARLET STORM' TM	DOUBLE TAKE SCARLET STORM FLOWERING QUINCE	CONT	5 GAL	6
	QU CR	QUERCUS ROBUR `CRIMSCHMIDT` TM	CRIMSCHMIDT ENGLISH OAK	B & B	2"CAL	15	Example 1	CO AF	CORNUS SERICEA 'ARCTIC FIRE'	ARCTIC FIRE DOGWOOD	CONT	5 GAL	71
	TI GR	TILIA CORDATA 'GREENSPIRE'	GREENSPIRE LITTLELEAF LINDEN	B & B	2"CAL	7	Exercity State of the state of	CO BU	CORNUS SERICEA 'BUD'S YELLOW'	BUD'S YELLOW TWIG DOGWOOD	CONT.	5 GAL.	94
EVERGREEN TREES	CODE	BOTANICAL NAME	COMMON NAME	<u>ROOT</u>	SIZE	QTY	6 6 8 5 6 7 6 7 6 7 6 7 6 7 6 7 6 7 6 7 6 7 6	CO KE	CORNUS SERICEA `KELSEYI`	KELSEYI DOGWOOD	CONT	5 GAL	108
	JU ME	JUNIPERUS SCOPULORUM 'MEDORA'	MEDORA JUNIPER	B & B	6` HEIGHT	2	\odot	DA CM	DAPHNE X BURKWOODII 'CAROL MACKIE'	CAROL MACKIE DAPHNE	CONT	5 GAL	2
+ }	PI BB	PICEA PUNGENS 'BABY BLUE'	BABY BLUE COLORADO SPRUCE	B & B	6` HEIGHT	6		HY LI	HYDRANGEA PANICULATA `LIMELIGHT`	LIMELIGHT HYDRANGEA	CONT	5 GAL	14
**************************************	PI FA	PICEA PUNGENS 'FASTIGATA'	FASTIGIATE COLORADO SPRUCE	B & B	6` HEIGHT	4		HY RE	HYDRANGEA PANICULATA 'RENHY'	VANILLA STRAWBERRY HYDRANGEA	CONT	5 GAL	3
+	PI BA	PICEA PUNGENS GLAUCA 'BAKERI'	BAKERI BLUE SPRUCE	B & B	6` HEIGHT	2		AM HY	HYDRANGEA QUERCIFOLIA 'AMETHYST'	AMETHYST OAKLEAF HYDRANGEA	CONT.	5 GAL	15
+	PI ED	PINUS EDULIS	PINON PINE	B & B	6` HEIGHT	8		KR LA	KRASCHENINNIKOVIA LANATA	WINTERFAT	CONT.	5 GAL	79
+	PI VP	PINUS FLEXILIS 'VANDERWOLF'S PYRAMID'	VANDERWOLF`S PYRAMID LIMBER PINE	B & B	6` HEIGHT	1		PE LS	PEROVSKIA ATRIPLICIFOLIA `LITTLE SPIRE` TM	LITTLE SPIRE RUSSIAN SAGE	CONT	5 GAL	62
A CONTRACTOR OF THE PARTY OF TH	PI NI	PINUS NIGRA	AUSTRIAN BLACK PINE	B & B	6` HEIGHT	6		PH DI	PHYSOCARPUS OPULIFOLIUS 'DIABOLO'	DIABLO NINEBARK	CONT	5 GAL	4
+	PI PO	PINUS PONDEROSA	PONDEROSA PINE	B & B	6` HEIGHT	6	Errong	РО РВ	POTENTILLA FRUTICOSA 'PINK BEAUTY'	PINK BEAUTY POTENTILLA	CONT	5 GAL	62
FRUIT TREES	CODE	BOTANICAL NAME	COMMON NAME	ROOT	SIZE	QTY		PR PB	PRUNUS BESSEYI PAWNEE BUTTES	CREEPING WESTERN SAND CHERRY	CONT	5 GAL	5
€	MA OE	MALUS X DOMESTICA 'MCINTOSH'	MCINTOSH APPLE	B & B	1.5"CAL	8		RH AU	RHUS TRILOBATA 'AUTUMN AMBER'	AUTUMN AMBER SUMAC	CONT	5 GAL	25
	MA RE	MALUS X DOMESTICA 'RED DELICIOUS'	RED DELICIOUS APPLE	B & B	1.5"CAL	12	Errong	RI AU	RIBES AUREUM	GOLDEN CURRANT	CONT	5 GAL	4
	PR AV	PRUNUS AVIUM 'STELLA'	STELLA SWEET CHERRY	B & B	1.5"CAL	21	E S S S S S S S S S S S S S S S S S S S	RO WO	ROSA WOODSII	MOUNTAIN ROSE	CONT	5 GAL	2
	PR MO	PRUNUS CERASUS 'MONTMORENCY'	MONTMORENCY CHERRY	B & B	1.5"CAL	12		RO BL	ROSA X 'BLUSHING KNOCKOUT'	ROSE	CONT	5 GAL	18
	PR ST	PRUNUS DOMESTICA 'STANLEY'	STANLEY PLUM	B & B	1.5"CAL	15		SY MK	SYRINGA PATULA 'MISS KIM'	MISS KIM LILAC	CONT	5 GAL	61
ORNAMENTAL TREES	CODE	BOTANICAL NAME	COMMON NAME	ROOT	SIZE	QTY	EVERGREEN SHRUBS	CODE	BOTANICAL NAME	COMMON NAME	ROOT	<u>SIZE</u>	QTY
	AC HW	ACER TATARICUM 'HOT WINGS'	HOT WINGS TATARIAN MAPLE	B & B	1.5"CAL	3	ار مارس	AR PA	ARCTOSTAPHYLOS X COLORADOENSIS 'PANCHITO'	PANCHITO MANZANITA	CONT	5 GAL	109
	CR AM	CRATAEGUS AMBIGUA	RUSSIAN HAWTHORN	B & B	1.5"CAL	5		BU IS	BUXUS SINICA INSULARIS	KOREAN BOXWOOD	CONT	5 GAL	108
	CR CR	CRATAEGUS CRUS-GALLI INERMIS `CRUSADER`	CRUSADER COCKSPUR HAWTHORN	B & B	1.5"CAL	37		EU EG	EUONYMUS FORTUNEI 'EMERALD GAIETY' TM	EMERALD GAIETY EUONYMUS	CONT	5 GAL	78
	HE MI	HEPTACODIUM MICONIOIDES	SEVEN SONS FLOWER	B & B	6' CLUMP	2	()	JU BH	JUNIPERUS HORIZONTALIS 'BAR HARBOR'	BAR HARBOR CREEPING JUNIPER	CONT	5 GAL	31
								JU SC	JUNIPERUS SABINA 'SCANDIA'	SCANDIA JUNIPER	CONT	5 GAL	15

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BY CORNER

OWNER:

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CONTACT: MOLLY CHIANG

DATE: 06.17.22 - SITE PLAN 01 09.15.22 - SITE PLAN 02

09.15.22 - SITE PLAN 02

SHEET TITLE: LANDSCAPE SCHEDULE

WILLOUGHBY CORNER SITE PLAN - PHASE 1


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	JU MO	JUNIPERUS SCOPULORUM `MOONGLOW`	MOONGLOW JUNIPER	CONT	5 GAL	3	PERENNIALS	CODE	BOTANICAL NAME	COMMON NAME	ROOT	SIZE	<u>QTY</u>
,(}	JU SG	JUNIPERUS X MEDIA `SEA GREEN`	SEA GREEN JUNIPER	CONT	5 GAL	4		AC PA	ACHILLEA MILLEFOLIUM 'PAPRIKA'	PAPRIKA COMMON YARROW	CONT	1 GAL	116
								AG RU	AGASTACHE RUPESTRIS 'APACHE SUNSET'	APACHE SUNSET THREADLEAF HYSSOP	CONT	1 GAL	52
	MA AQ	MAHONIA AQUIFOLIUM 'COMPACTA'	COMPACT OREGON GRAPE	CONT	5 GAL	16	4 ~ P	AO CA			CONT	1 GAL	1.4
STANDARD COLORS	PI DW	PINUS EDULIS	DWARF PINON PINE	CONT	5 GAL	75		AQ CA	AQUILEGIA CAERULEA	ROCKY MOUNTAIN COLUMBINE	CONT	I GAL	14
,	PI MU	PINUS MUGO 'SLOWMOUND'	SLOWMOUND MUGO PINE	CONT	5 GAL	6	() c	AS TU	ASCLEPIAS TUBEROSA	BUTTERFLY MILKWEED	CONT	1 GAL	16
Runnorite J.								BE LY	BERLANDIERA LYRATA	CHOCOLATE DAISY	CONT	1 GAL	19
AN MARAMAN WE	YU FI	YUCCA FILAMENTOSA	ADAM'S NEEDLE	CONT	5 GAL	45	ş	CO 1 A	CODEODGIC LANGEOLATA 'CTEDNITALED'		CONT	1 0 1	40
GROUNDCOVER	CODE	BOTANICAL NAME	COMMON NAME	ROOT	SIZE	<u>QTY</u>		CO LA	COREOPSIS LANCEOLATA `STERNTALER`	STERNTALER LANCELEAF TICKSEED	CONT	1 GAL	42
£3	HO AM	HOSTA X `AMERICAN HALO`	AMERICAN HALO HOSTA	CONT.		15		DI FL	DIANTHUS DELTOIDES 'FLASHING LIGHT'	FLASHING LIGHT MAIDEN PINK	CONT	1 GAL	14
ORNAMENTAL GRASSES	CODE	BOTANICAL NAME	COMMON NAME	ROOT	SIZE	QTY		EC PU	ECHINACEA PURPUREA	PURPLE CONEFLOWER	CONT	1 GAL	61
	BO BA	BOUTELOUA GRACILIS 'BLONDE AMBITION'	BLOND AMBITION BLUE GRAMA GRASS	CONT	1 GAL	627		04.45	CALL ADDIA ADIOTATA	NATIVE DI ANIZET EL ONZED	CONT	4.041	50
annie.								GA AR	GAILLARDIA ARISTATA	NATIVE BLANKET FLOWER	CONT	1 GAL	52
an anne	HE SE	HELICTOTRICHON SEMPERVIRENS	BLUE OAT GRASS	CONT	1 GAL	608		HE HR	HEMEROCALLIS X 'HAPPY RETURNS'	HAPPY RETURNS DAYLILY	CONT	1 GAL	21
	MI PU	MISCANTHUS SINENSIS 'PURPURESCENS'	FLAME GRASS	CONT	1 GAL	33		НО РА	HOSTA FORTUNEI 'PATRIOT'	PATRIOT HOSTA	CONT	1 GAL	28
*	MU RE	MUHLENBERGIA REVERCHONI 'UNDAUNTED'	UNDAUNTED MUHLY	CONT	1 GAL	654	\	IR 00	IRIS X GERMANICA 'OPEN OCEAN'	OPEN OCEAN GERMAN IRIS	CONT	1 GAL	6
*	PA SH	PANICUM VIRGATUM `SHENANDOAH`	SWITCH GRASS	CONT	1 GAL	201	λ						
								LA AN	LAVANDULA ANGUSTIFOLIA `MUNSTEAD`	MUNSTEAD ENGLISH LAVENDER	CONT	1 GAL	11
	PE HA	PENNISETUM ALOPECUROIDES 'HAMELN'	HAMELN FOUNTAIN GRASS	CONT	1 GAL	726		PE RR	PENSTEMON MEXICALI 'RED ROCKS'	RED ROCKS PENSTEMON	CONT	1 GAL	20
*	SC SC	SCHIZACHYRIUM SCOPARIUM 'THE BLUES'	THE BLUES LITTLE BLUESTEM	CONT.	1 GAL.	277		RA CO	RATIBIDA COLUMNIFERA	YELLOW PRAIRIE CONEFLOWER	CONT	1 GAL	29
Edving.	SP HE	SPOROBOLUS HETEROLEPIS	PRAIRIE DROPSEED	CONT	1 GAL	298		SO RU	SOLIDAGO RUGOSA 'FIREWORKS'	FIREWORKS WRINKLELEAF GOLDENROD	CONT	1 GAL	13
SEED MIX LIST								ZI GR	ZINNIA GRANDIFLORA 'GOLD ON BLUE'	GOLD ON BLUE ROCKY MOUNTAIN ZINNIA	CONT	1 GAL	47
WETLAND SEED)						_						
	_	COMMON NAME BOTANICAL	L NAME										

ETLAND SEED

BOTANICAL NAME PASCOPYRUM SMITHII VAR ARRIBA 14.5 LBS. 0.5 LBS. CAREX LANUGINOSA **BOUTELOUA GRACILIS VAR LOVINGTON** 2.5 LBS. 0.5 LBS. CAREX NEBRASKENSIS 13 LBS. PANICUM VIRGATUM VAR BLACKWELL 2.5 LBS. DISTICLIS STRICTA 0.5 LBS. ELEOCHARIS PALUSTRIS 2 LBS. JUNCUS BALTICUS 2 LBS. SCIRPUS ACUTUS 10 LBS. SPARTINA PECTINATA 2 LBS. SPOROBOLUS CRYPTANDRUS 50 LBS. / PLS 100%

ENHANCED NATIVE SEED

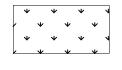


		100%	PER ACRE
COMMON NAME	BOTANICAL NAME		
SIDE OATS GRAMA	BOUTELOUA CURTIPENDULA	5%	0.57 LBS
BLUE GRAMA	BOUTELOUA GRACILIS	10%	0.26 LBS
BUFFALOGRASS	BOUTELOUA DACTYLOIDES	10%	3.89 LBS
CANADA WILDRYE	ELYMUS CANADENSIS	10%	1.89 LBS
THICKSPIKE WHEATGRASS	ELYMUS LANCEOLATUS	10%	1.41 LBS
SLENDER WHEATGRASS	ELYMUS TRACHYCAULUS	10%	1.37 LBS
SWITCHGRASS	PANICUM VIRGATUM 'TRAILBLAZER'	3%	0.17 LBS
WESTERN WHEATGRASS	PASCOPYRUM SMITHII	5%	0.99 LBS
LITTLE BLUESTEM	SCHIZACHYRIUM SCOPARIUM	5%	0.42 LBS
ALKALI SACATON	PUCCINELLIA	2%	0.02 LBS
SAND DROPSEED	SPOROBOLUS CRYPTANDRUS	5%	0.02 LBS
ROCKY MOUNTAIN BEE	CLEOME SERRULATA	5%	1.65 LBS
PLANT PLAINS COREOPSIS	COREOPSIS TINCTORIA	5%	0.02 LBS
PURPLE PRAIRE CLOVER	DALEA PURPUREA	5%	0.36 LBS
BLANKET FLOWER	GAILLARDIA ARISTATA	5%	0.83 LBS
YELLOW CONEFLOWER	RATIBIDA COLUMNIFERA	5%	0.09 LBS
		100%	13.97 LBS.

LOW GROW MIX



SPECIES
BUFFALOGRASS
BLUE GRAMMA GRASS

ARKANSAS VALLEY SEED WESTERN WILDFLOWER MIX

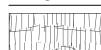

DRILLED

<u>SPECIES</u> CORNFLOWER SIBERIAN WALLFLOWER PLAINS COREOPSIS CALIFORNIA POPPY BLANKETFLOWER INDIAN BLANKET **GLOBE GILIA** BABY'S BREATH CANDYTUFT SCARLET FLAX LEMON MINT CORN POPPY **ROCKY MOUNTAION** PENSTEMON PURPLE CONEFLOWER SHOWY GOLDENEYE MAXIMILLIAN SUNFLOWER RUSSEL LUPINE **COMMON YARROW** LACY PHACELIA PRAIRIE CONEFLOWER

WESTERN WHEATGRASS

WOOLY SEDGE

SWITCHGRASS

NEBRASKA SEDGE

INLAND SALTGRASS

HARDSTEM BULRUSH

PRAIRIE CORDGRASS

SAND DROPSEED

CREEPING SPIKERUSH

BLUE GRAMA

BALTIC RUSH

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MATERIAL SCHEDULE (CONTRACTOR TO SUBMIT SAMPLES FOR ALL ITEMS IN MATERIAL SCHEDULE FOR OWNER / ARCHITECT REVIEW AND APPROVAL.)

_	ITEM	DESCRIPTION	PROVIDER	SIZE / DIMENSIONS	PRODUCT NAME	COLOR / FINISH	NOTES	QUANTITY
	(A)	CONCRETE FLATWORK	N/A	N/A	N/A	STANDARD GRAY, BROOM FINISH	INSTALL PER MANUFACTURER'S SPECIFICATIONS	N/A; SEE CIVIL
_	B	ENHANCED PAVING	DAVIS COLOR OR APPROVED EQUAL	N/A		TBD	INSTALL PER MANUFACTURER'S SPECIFICATIONS	
	♦	COBBLE MULCH	PIONEER OR APPROVED EQUAL	6-12" ROCK, MIN. 4" DEPTH.	N/A	RIVER ROCK BLEND	INSTALL PER MANUFACTURER'S SPECIFICATIONS	
_	(ROCK MULCH	PIONEER OR APPROVED EQUAL	MIX OF 30% 1-2" ROCK, 30% 4-6" ROCK, AND 40% 6-12" ROCK; MIN. 4" DEPTH	N/A	RIVER ROCK BLEND	INSTALL PER MANUFACTURER'S SPECIFICATIONS	
	Ē	WOOD MULCH	PIONEER OR APPROVED EQUAL	CUSTOM	N/A	GORILLA HAIR SHREDDED CEDAR MULCH	INSTALL PER MANUFACTURER'S SPECIFICATIONS	
	F	CRUSHER FINES	PIONEER OR APPROVED EQUAL	N/A	N/A	DOLOMITE TAN COLOR	INSTALL PER MANUFACTURER'S SPECIFICATIONS	
	G	IRRIGATED TURF- SOD	N/A	N/A	TEXAS HYBRID BLUEGRASS BLEND	N/A	INSTALL PER MANUFACTURER'S SPECIFICATIONS	
	$\langle H \rangle$	PLAYGROUND SURFACING	POUR IN PLACE (PIP)	CUSTOM	N/A		INSTALL PER MANUFACTURER'S SPECIFICATIONS	
	\Diamond	STEEL EDGER	RYERSON OR APPROVED EQUAL	6" X 14 GAUGE	N/A	INTERLOCKING, ROLLED TOP EDGER OR APPROVED EQUAL, COLOR- BLACK	INSTALL PER MANUFACTURER'S SPECIFICATIONS	

ITEM	DESCRIPTION	MANUFACTURER	CONTACT	PRODUCT NAME	COLOR/FINISH	NOTES
1>	BENCH	LANDSCAPE FORMS	CONTACT: Vivian Kovacs 800.430.6206 x 1323 www.landscapeforms.com	GENERATION 50 BENCH WITH LOOPED END ARMS OR APPROVED EQUAL	TBD	SURFACE MOUNT PER MANUFACTURER SPECIFICATIONS
2>	TWIG BENCH	LANDSCAPE FORMS	CONTACT: Vivian Kovacs 800.430.6206 x 1323 www.landscapeforms.com	BACKED TWIG BENCH	TBD	FREE STANDING
3>	TRASH RECEPTACLE	SITE PIECES	CONTACT: 800.484.0797 www.sitepieces.com	MONOLINE LITTER BIN ML-LGLITTER-DL OR APPROVED EQUAL	POWDERCOAT BLACK	SURFACE MOUNT PER MANUFACTURER SPECIFICATIONS
4	BIKE RACK	LANDSCAPE FORMS	CONTACT: Vivian Kovacs 800.430.6206 x 1323 www.landscapeforms.com	FLO BIKE RACK OR APPROVED EQUAL	TBD	SURFACE MOUNT PER MANUFACTURER SPECIFICATIONS
\$	DOG WASTE STATION	SITE PIECES	CONTACT: 800.484.0797 www.sitepieces.com	MONOLINE NO.2 BAG HOLDER + WASTE BIN OR APPROVED EQUAL	TBD	SURFACE MOUNT PER MANUFACTURER SPECIFICATIONS
6	BISTRO TABLES	LANDSCAPE FORMS	CONTACT: Vivian Kovacs 800.430.6206 x 1323 www.landscapeforms.com	CATENA SURFACE MOUNT TABLE WITH PERFORATED STEELHEAD METAL OR APPROVED EQUAL	TBD	SURFACE MOUNT PER MANUFACTURER SPECIFICATIONS
6	BISTRO CHAIRS	LANDSCAPE FORMS	CONTACT: Vivian Kovacs 800.430.6206 x 1323 www.landscapeforms.com	CATENA CHAIRS OR APPROVED EQUAL	TBD	FREESTANDING
♦	STRING LIGHTS	AQ LIGHTING	CONTACT: 800.865.7221 www.aqlightinggroup.com	120V COMMERCIAL GRADE OUTDOOR LED STRING LIGHTS BLACK WIRE, CLEAR BULB OR APPROVED EQUAL		INSTALL PER MANUFACTURER'S SPECIFICATIONS, TO BE FASTENED TO STEEL CABLE FOR SUPPORT, STRINGS TO BE TAUT, REFER TO ELECTRICAL
₹	STRING LIGHTS POLE	STRUCTURA	CONTACT: 913:390.8787 www.structura.com			INSTALL PER MANUFACTURER'S SPECIFICATIONS
8	PLANTERS	TBD	TBD	TBD	TBD	INSTALL PER MANUFACTURER'S SPECIFICATIONS
9>	GRILL	TBD	TBD	TBD	TBD	INSTALL PER MANUFACTURER'S SPECIFICATIONS
10 >	LIGHT PILLAR	ATTRACTION LIGHTS	CONTACT: 970.316.0019 www.attractionlights.com	ASPEN PILLAR, 10'-6" H x 8" x 8"	CORTEN STEEL	INSTALL PER MANUFACTURER'S SPECIFICATIONS

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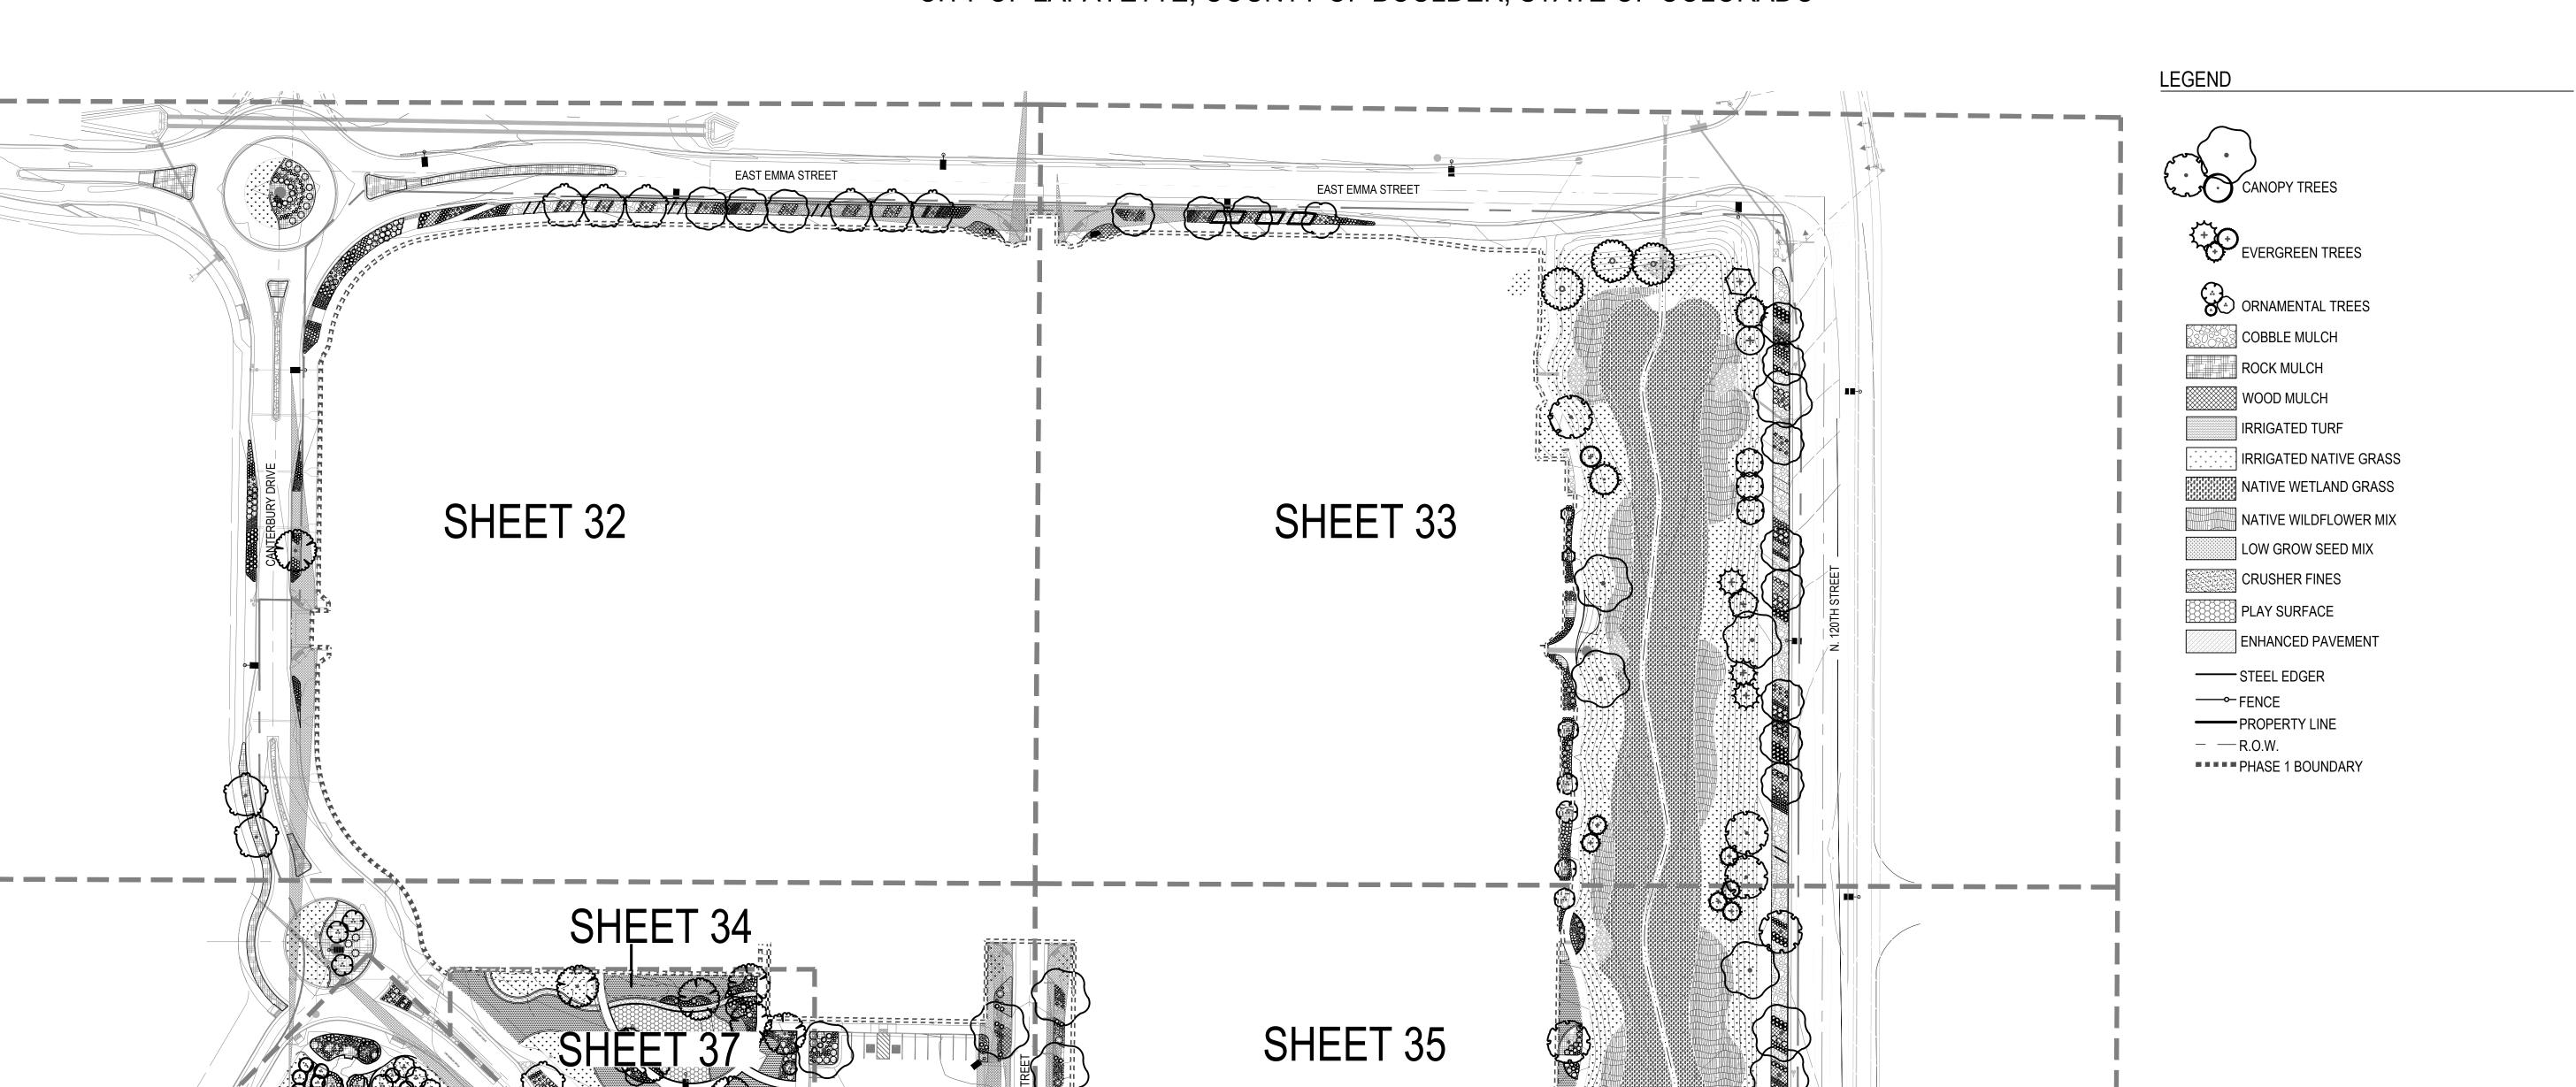
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SHEET TITLE:
MATERIAL & AMENITY
SCHEDULE

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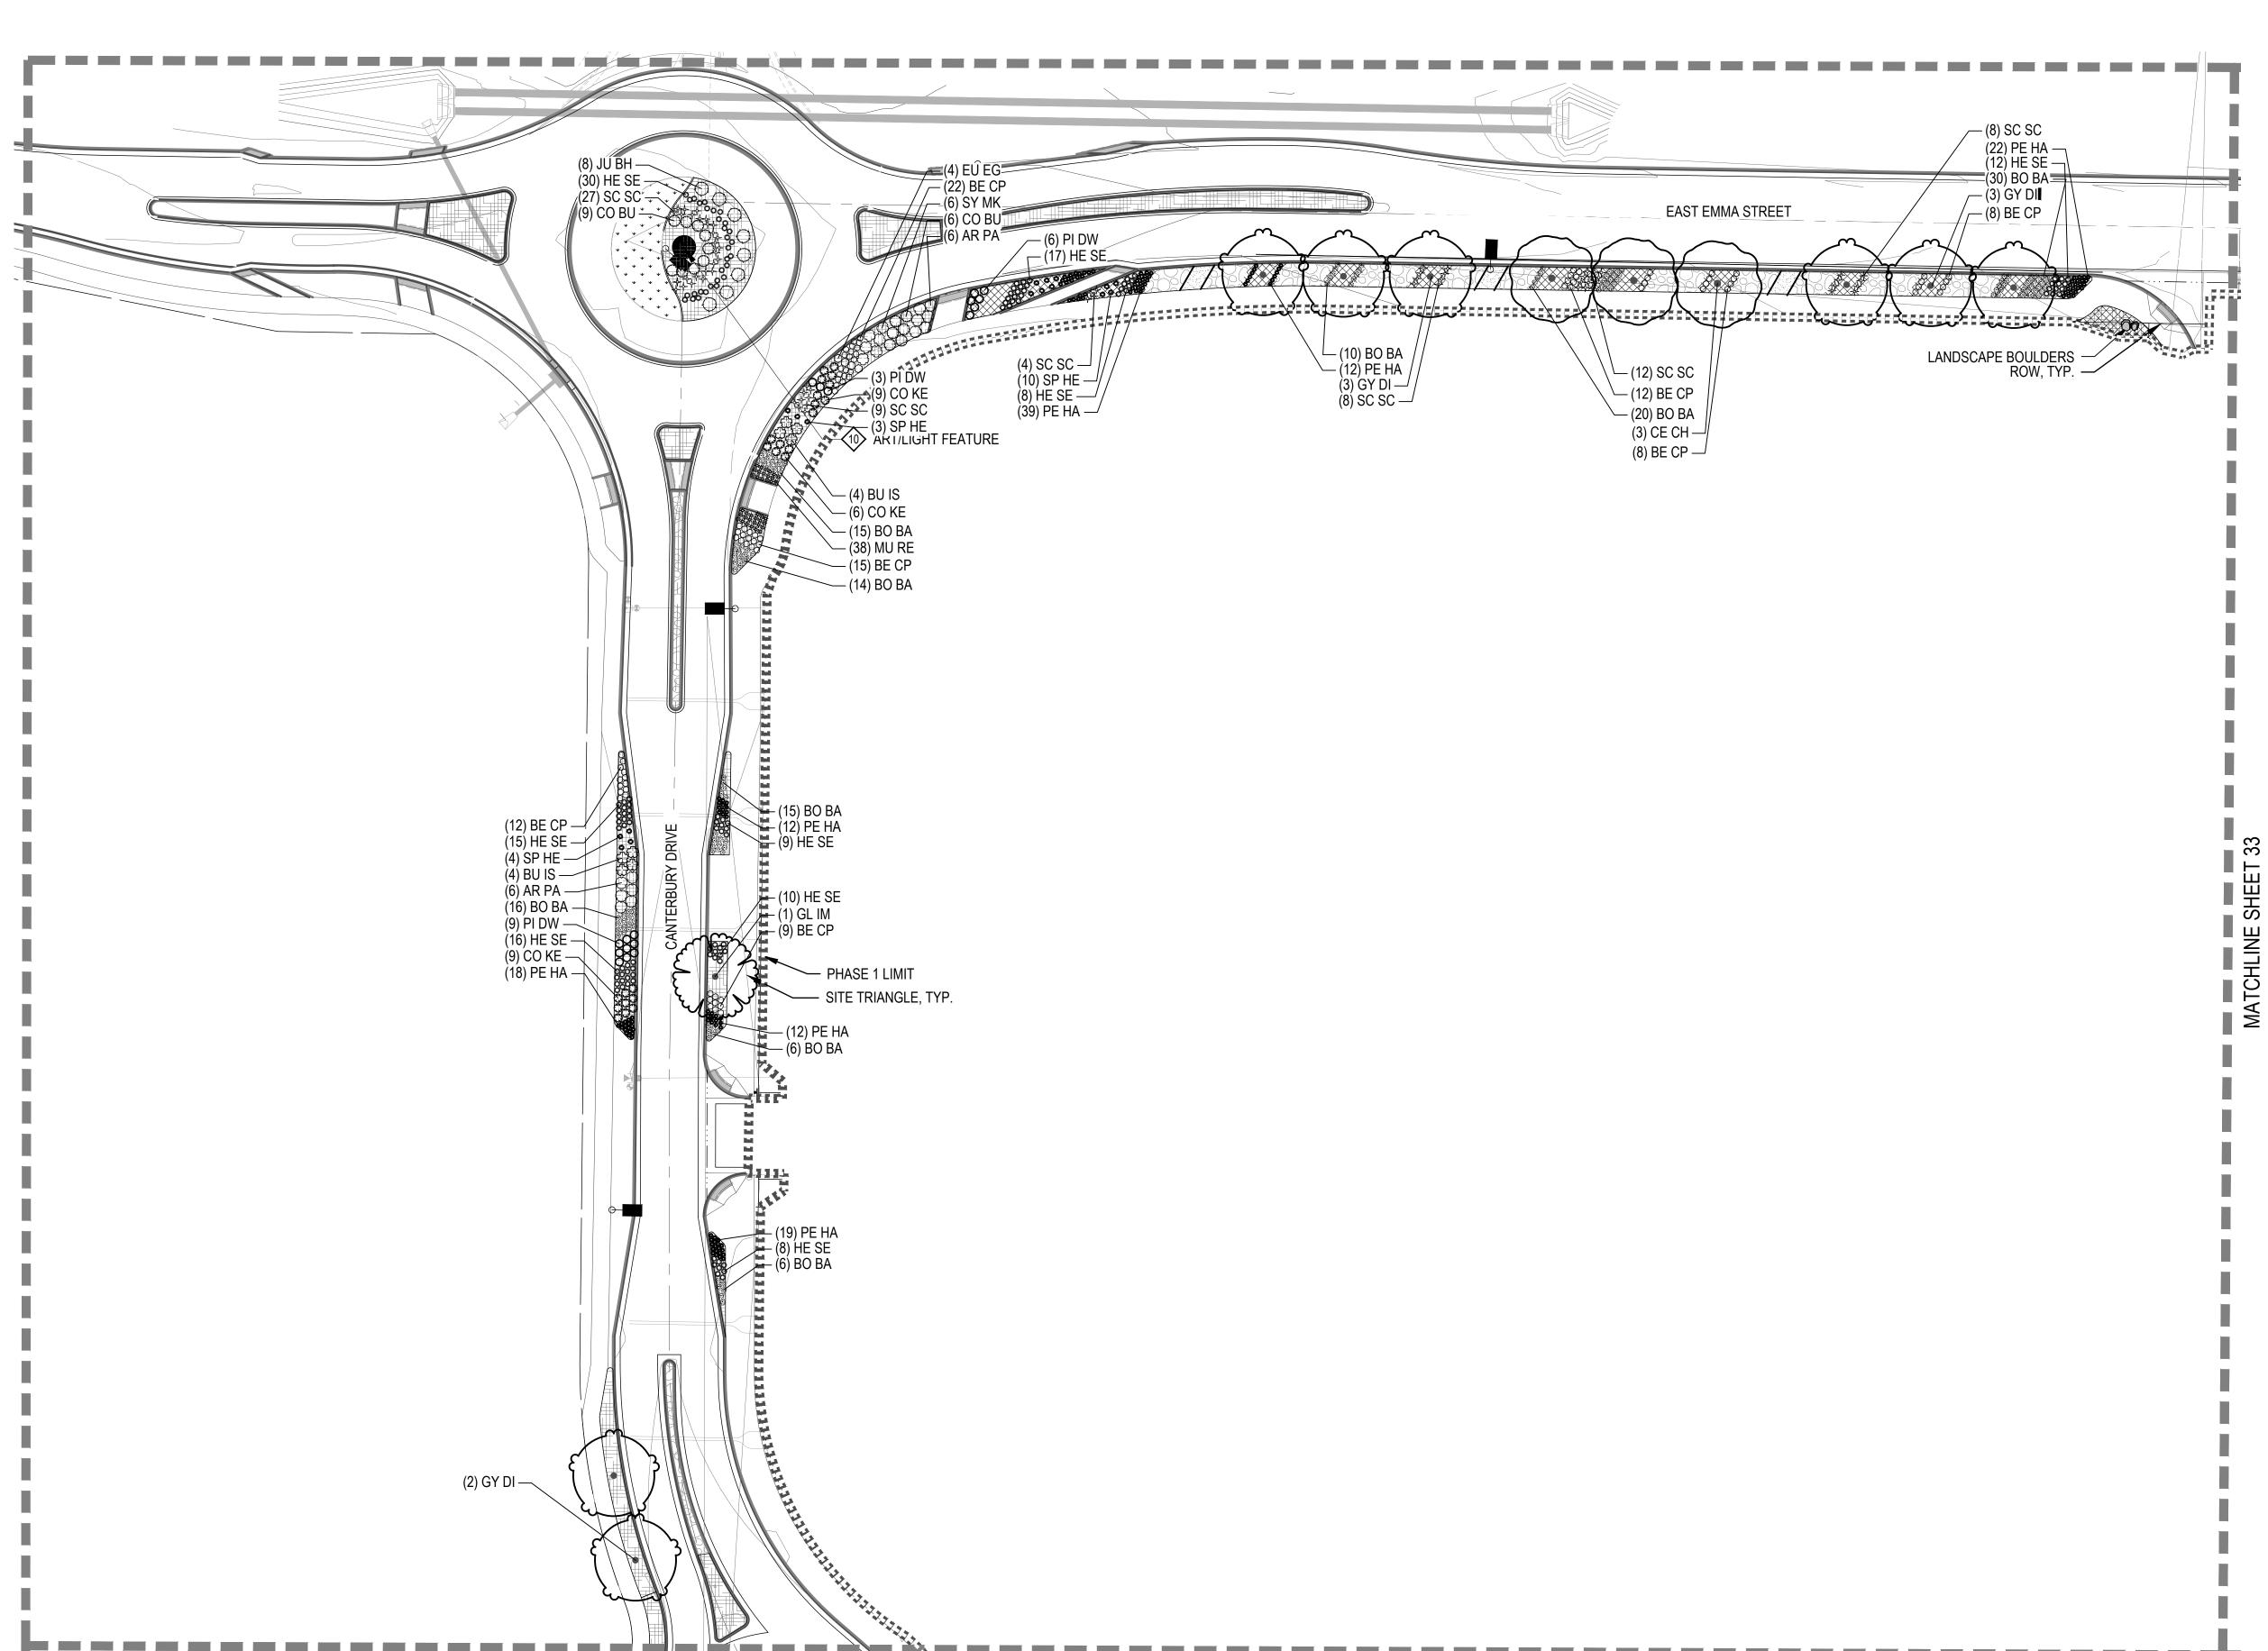
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OVERALL PLAN

30 60 120 SCALE 1" = 60'



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LEGEND

ORNAMENTAL TREES

COBBLE MULCH

ROCK MULCH

WOOD MULCH

IRRIGATED TURF

NATIVE WETLAND GRASS

IRRIGATED NATIVE GRASS

NATIVE WILDFLOWER MIX

LOW GROW SEED MIX

CRUSHER FINES

PLAY SURFACE

——— STEEL EDGER

IIIIIIIIIIIII PHASE 1 BOUNDARY

♦ (SHEET 30)

TWIG BENCH ♦ (SHEET 30)

BIKE RACK ♦ (SHEET 30)

PET PICK UP STATION

TRASH AND RECYCLING

RECEPTACLES

⟨₃⟩ (SHEET 30)

KEY MAP

——⊶ FENCE

____ R.O.W.

ENHANCED PAVEMENT

BISTRO TABLE AND

⟨₅⟩ (SHEET 30)

STRING LIGHTS

PLANTERS
(SHEET 30)

OUTDOOR GRILL

(SHEET 30)

ART/LIGHT FEATURE

(SHEET 30)

CHAIRS

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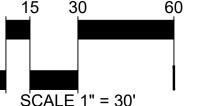
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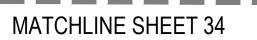
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SHEET TITLE: LANDSCAPE PLAN








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LEGEND

COBBLE MULCH

ROCK MULCH

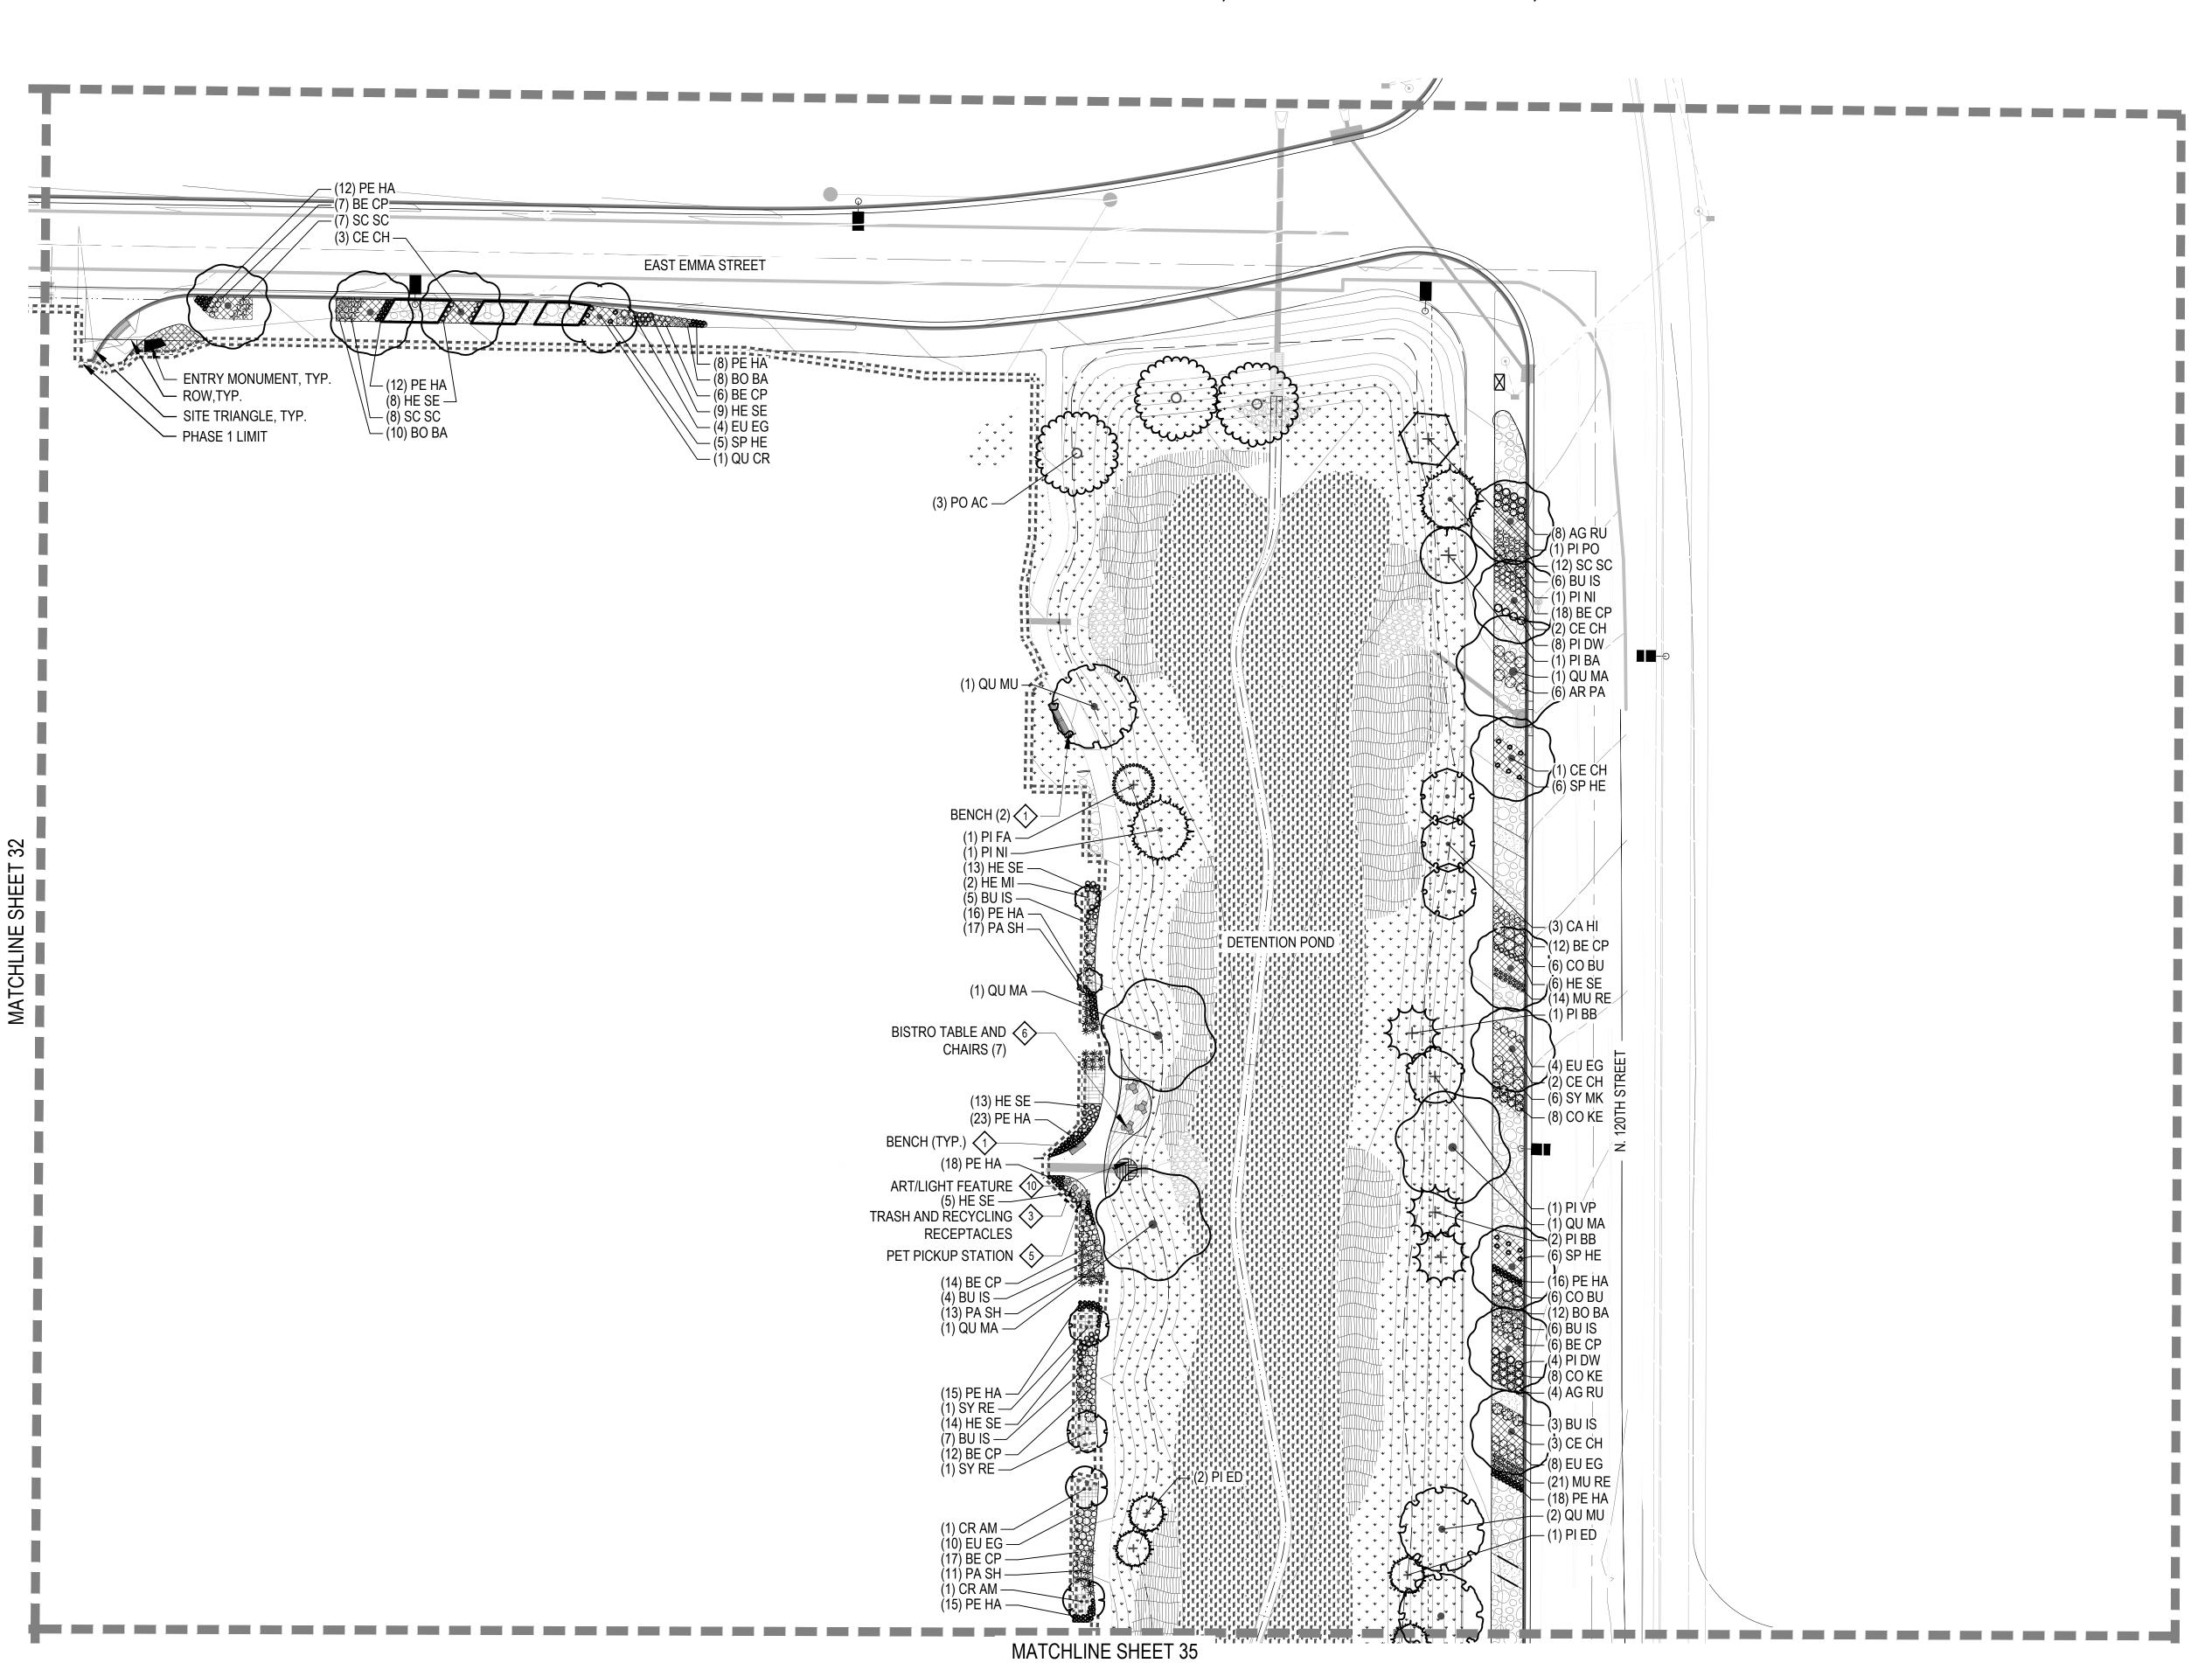WOOD MULCH

IRRIGATED TURF

IRRIGATED NATIVE GRASS

NATIVE WETLAND GRASS

NATIVE WILDFLOWER MIX

LOW GROW SEED MIX

CRUSHER FINES

PLAY SURFACE

——— STEEL EDGER

######## PHASE 1 BOUNDARY

♦ (SHEET 30)

♦ (SHEET 30)

♦ (SHEET 30)

PET PICK UP STATION

TRASH AND RECYCLING

■

RECEPTACLES

(SHEET 30)

KEY MAP

BIKE RACK

——⊶ FENCE

ENHANCED PAVEMENT

BISTRO TABLE AND

♠ (SHEET 30)

STRING LIGHTS

PLANTERS
(SHEET 30)

OUTDOOR GRILL

(SHEET 30)

ART/LIGHT FEATURE

(SHEET 30)

CHAIRS

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SITE PLAN- PHA

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DATE: 6.17.22 - SITE PLAN

06.17.22 - SITE PLAN 01 09.15.22 - SITE PLAN 02


SHEET TITLE: LANDSCAPE PLAN

33

15 30 60 SCALE 1" = 30'



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LEGEND

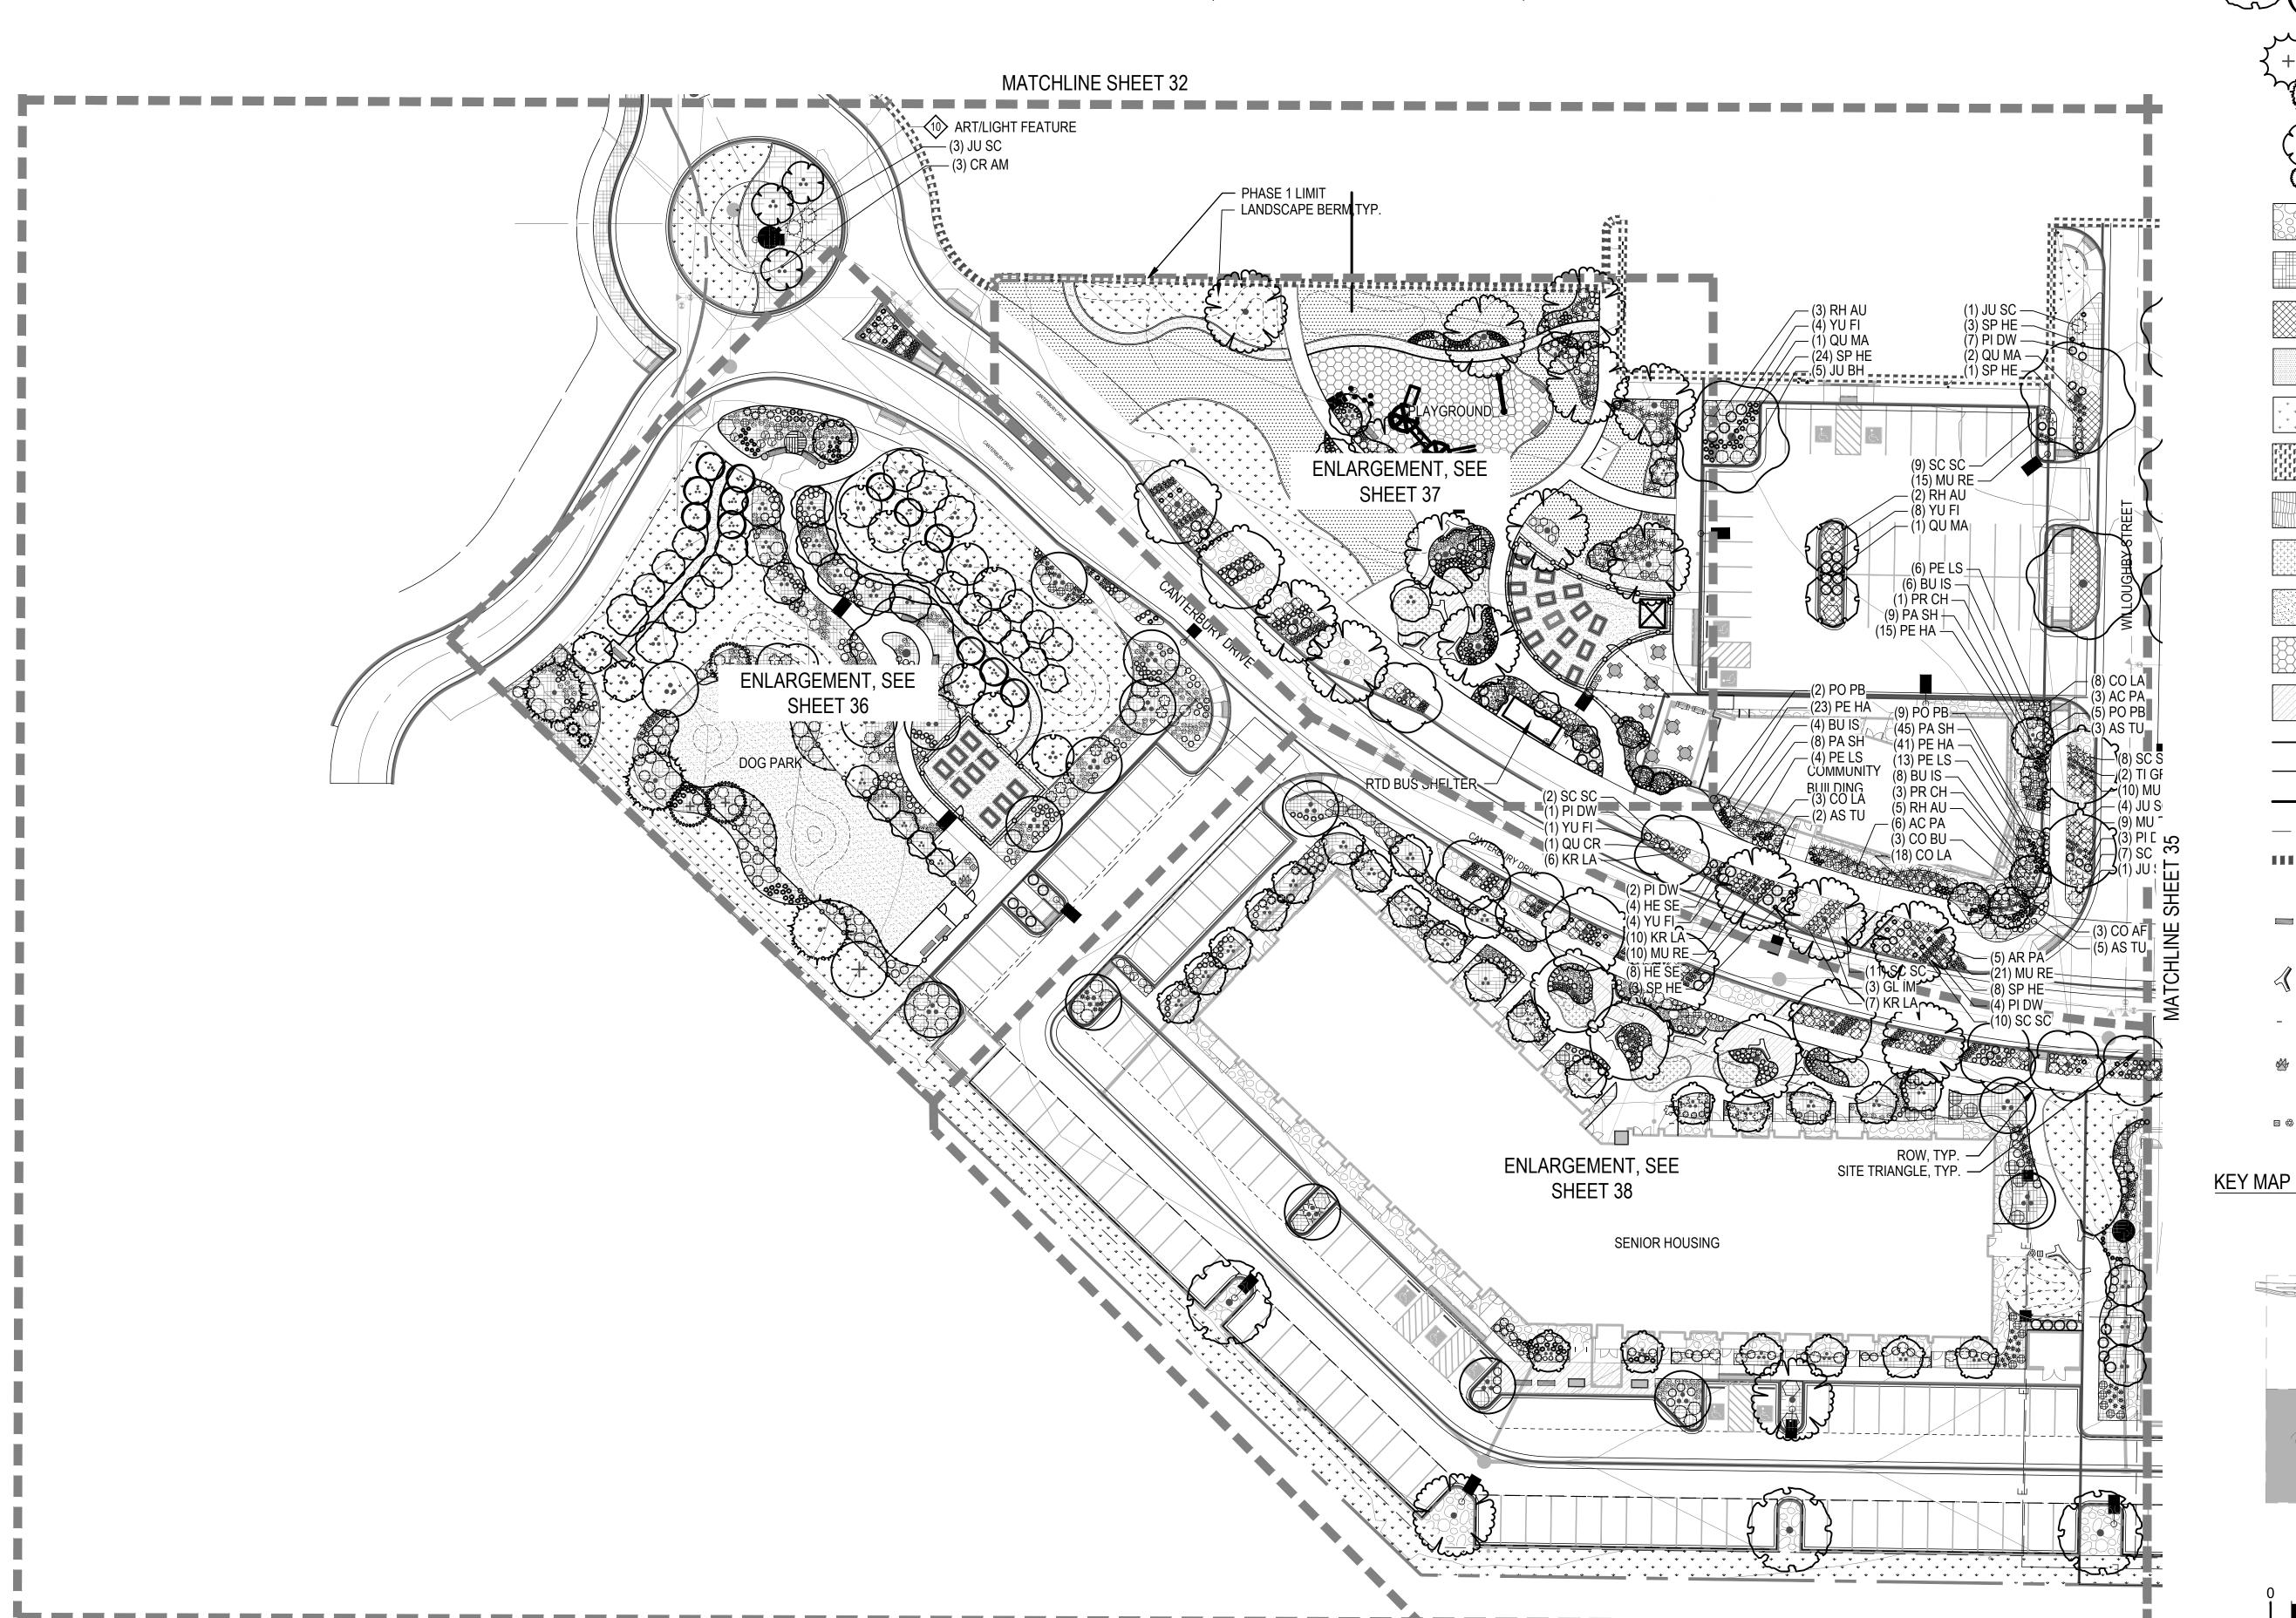ROCK MULCH

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IRRIGATED TURF

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NATIVE WILDFLOWER MIX

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PLAY SURFACE

— STEEL EDGER

IIIIIIIIIIIII PHASE 1 BOUNDARY

♦ (SHEET 30)

TWIG BENCH

BIKE RACK ♦ (SHEET 30)

♦ (SHEET 30)

PET PICK UP STATION

TRASH AND RECYCLING

■ ● RECEPTACLES

③ (SHEET 30)

——⊶ FENCE

____ R.O.W.

ENHANCED PAVEMENT

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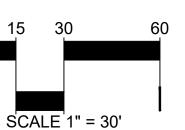
BOULDER, CO - 80304


CONTACT: MOLLY CHIANG

DATE: 06.17.22 - SITE PLAN 01

09.15.22 - SITE PLAN 02

SHEET TITLE: LANDSCAPE PLAN



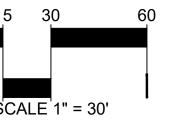



BISTRO TABLE AND

<a>♠ (SHEET 30)

STRING LIGHTS

♦ (SHEET 30)

PLANTERS
(SHEET 30)

OUTDOOR GRILL


(SHEET 30)

ART/LIGHT FEATURE (SHEET 30)

CHAIRS



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a R R

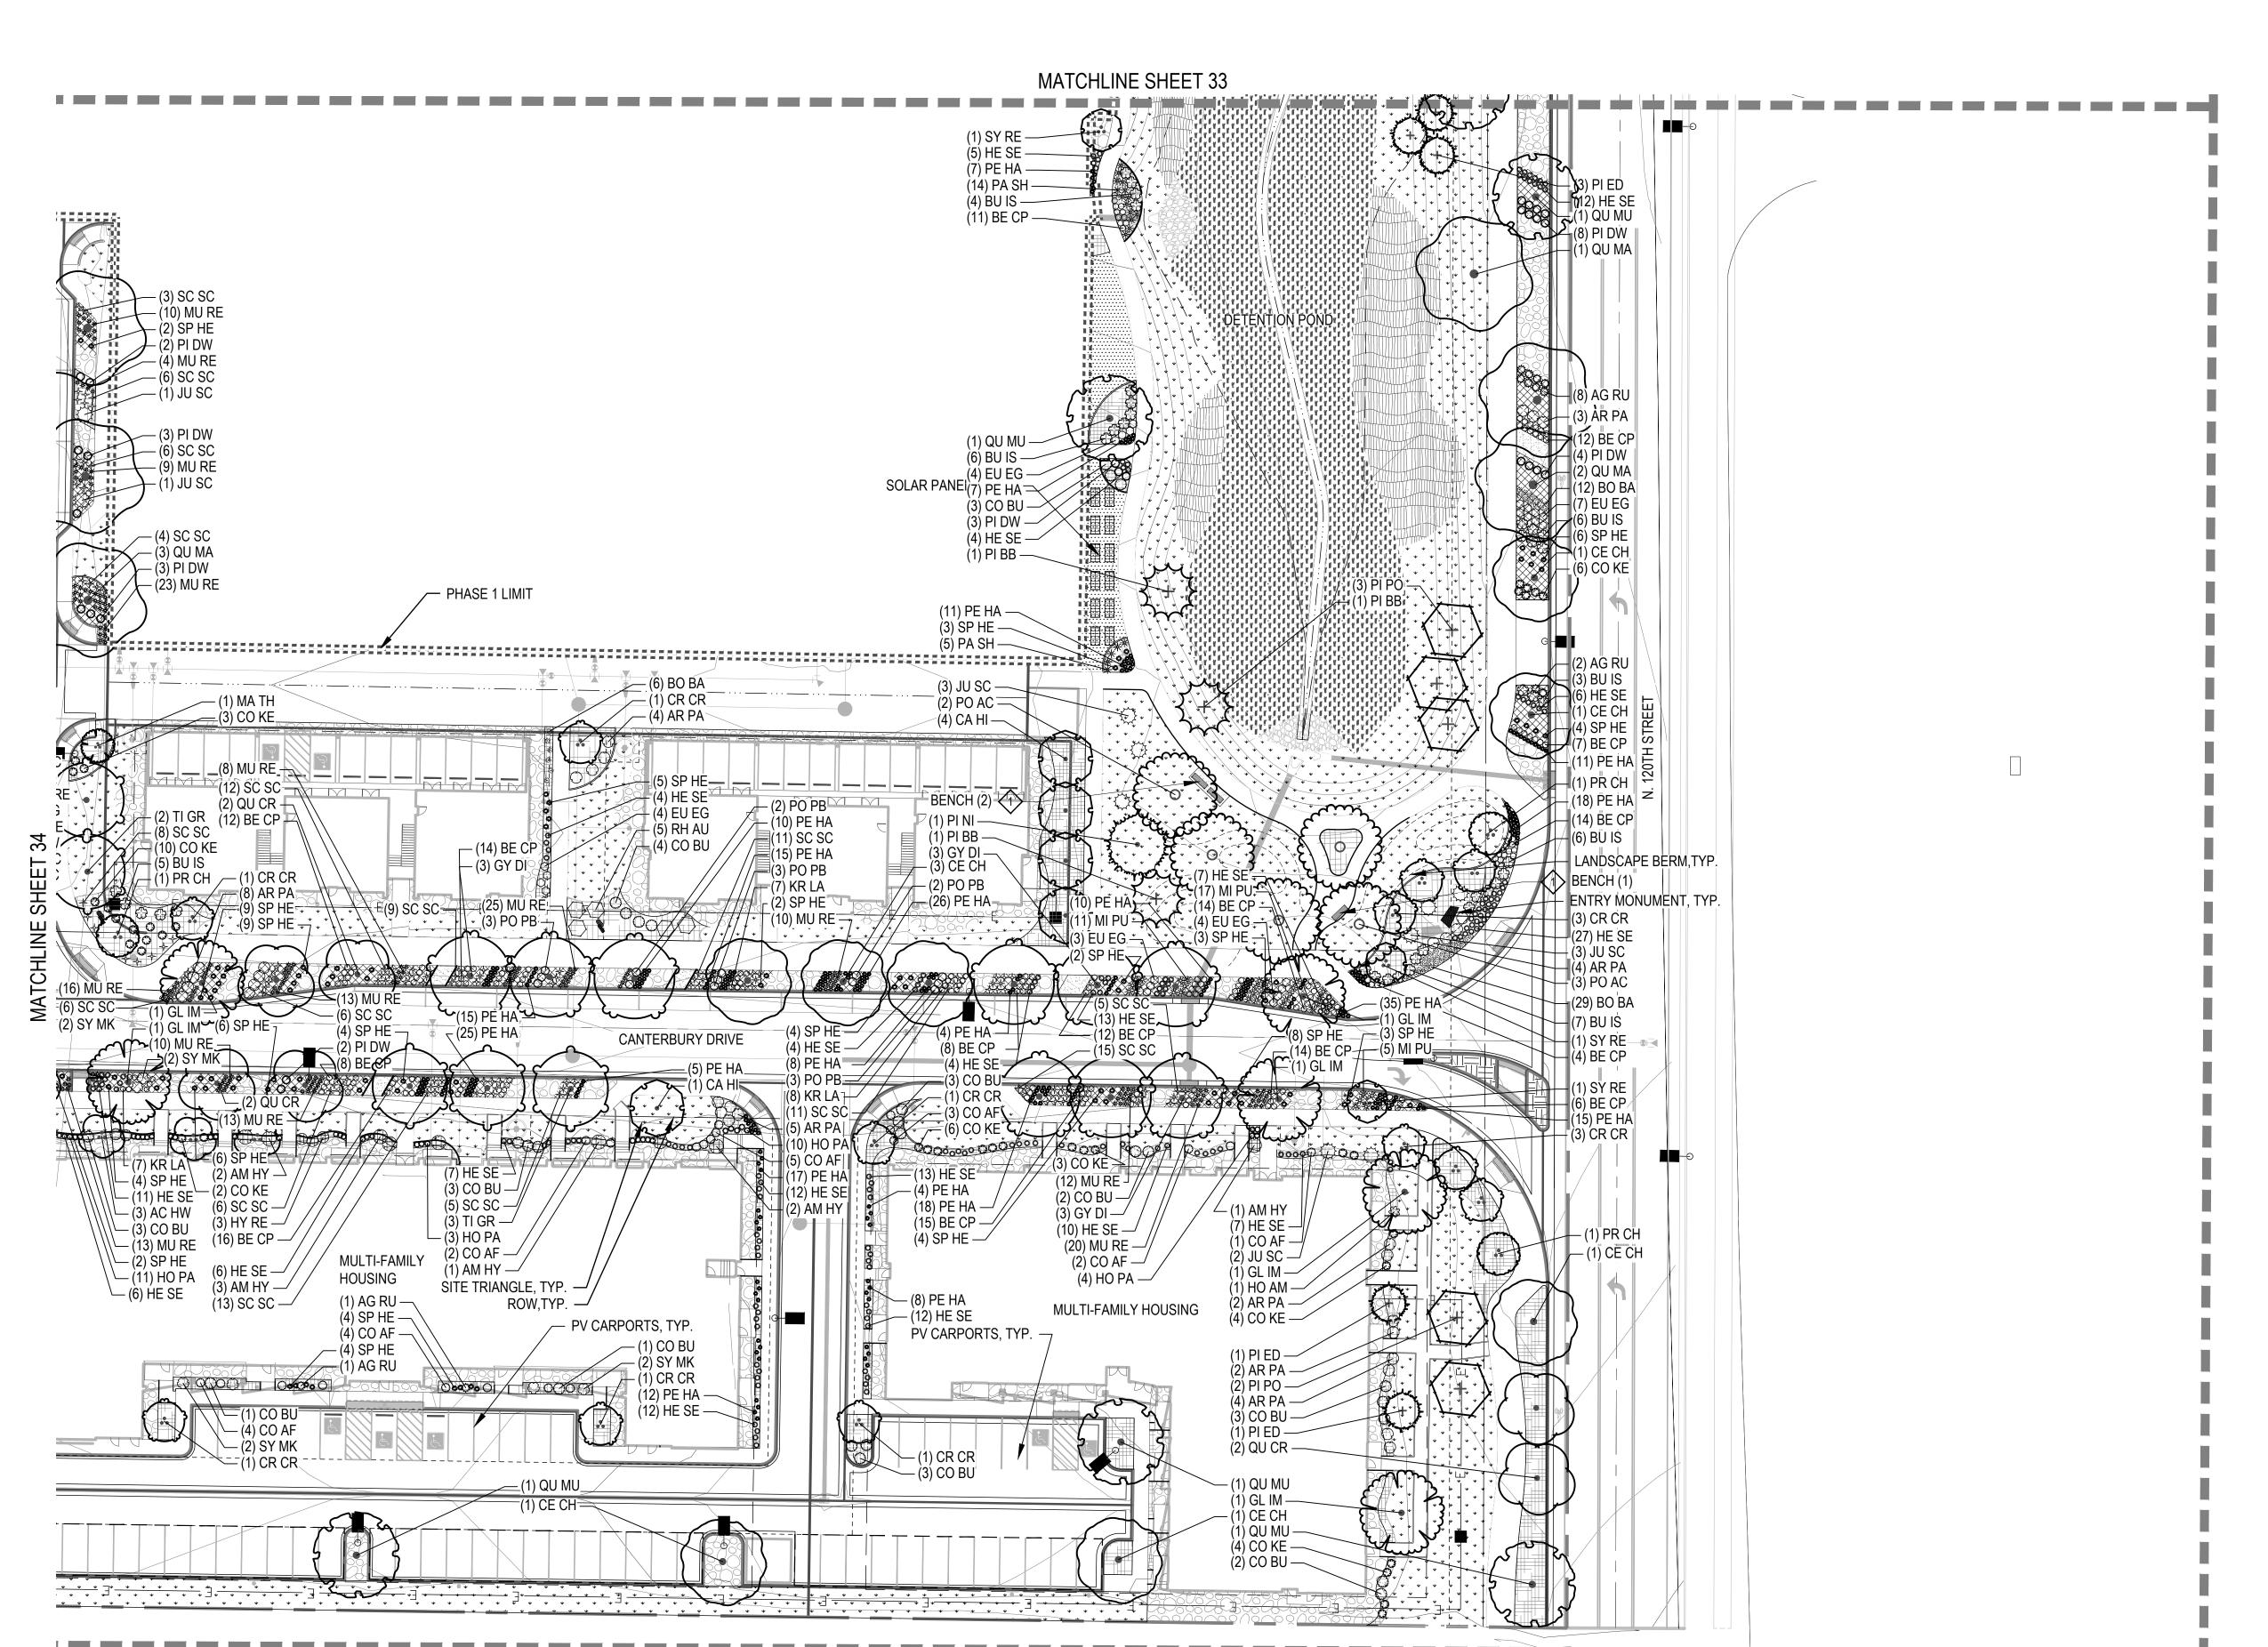LEGEND

COBBLE MULCH

ROCK MULCH

WOOD MULCH

IRRIGATED TURF

IRRIGATED NATIVE GRASS

NATIVE WETLAND GRASS

NATIVE WILDFLOWER MIX

LOW GROW SEED MIX

ENHANCED PAVEMENT

BISTRO TABLE AND

⟨6⟩ (SHEET 30)

STRING LIGHTS

PLANTERS

© OUTDOOR GRILL ♦ (SHEET 30)

ART/LIGHT FEATURE

CHAIRS

CRUSHER FINES

PLAY SURFACE

STEEL EDGER

IIIIIIIIII PHASE 1 BOUNDARY

——⊶— FENCE

BENCH

♦ (SHEET 30)

TWIG BENCH

♦ (SHEET 30)

⟨4⟩ (SHEET 30)

PET PICK UP STATION

TRASH AND RECYCLING

BIKE RACK

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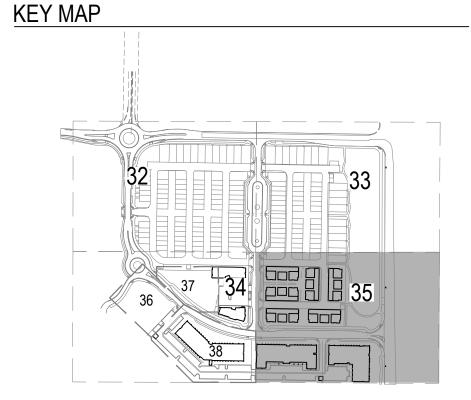
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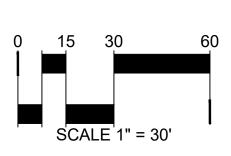
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③ (SHEET 30)












SHEET TITLE:

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DATE:
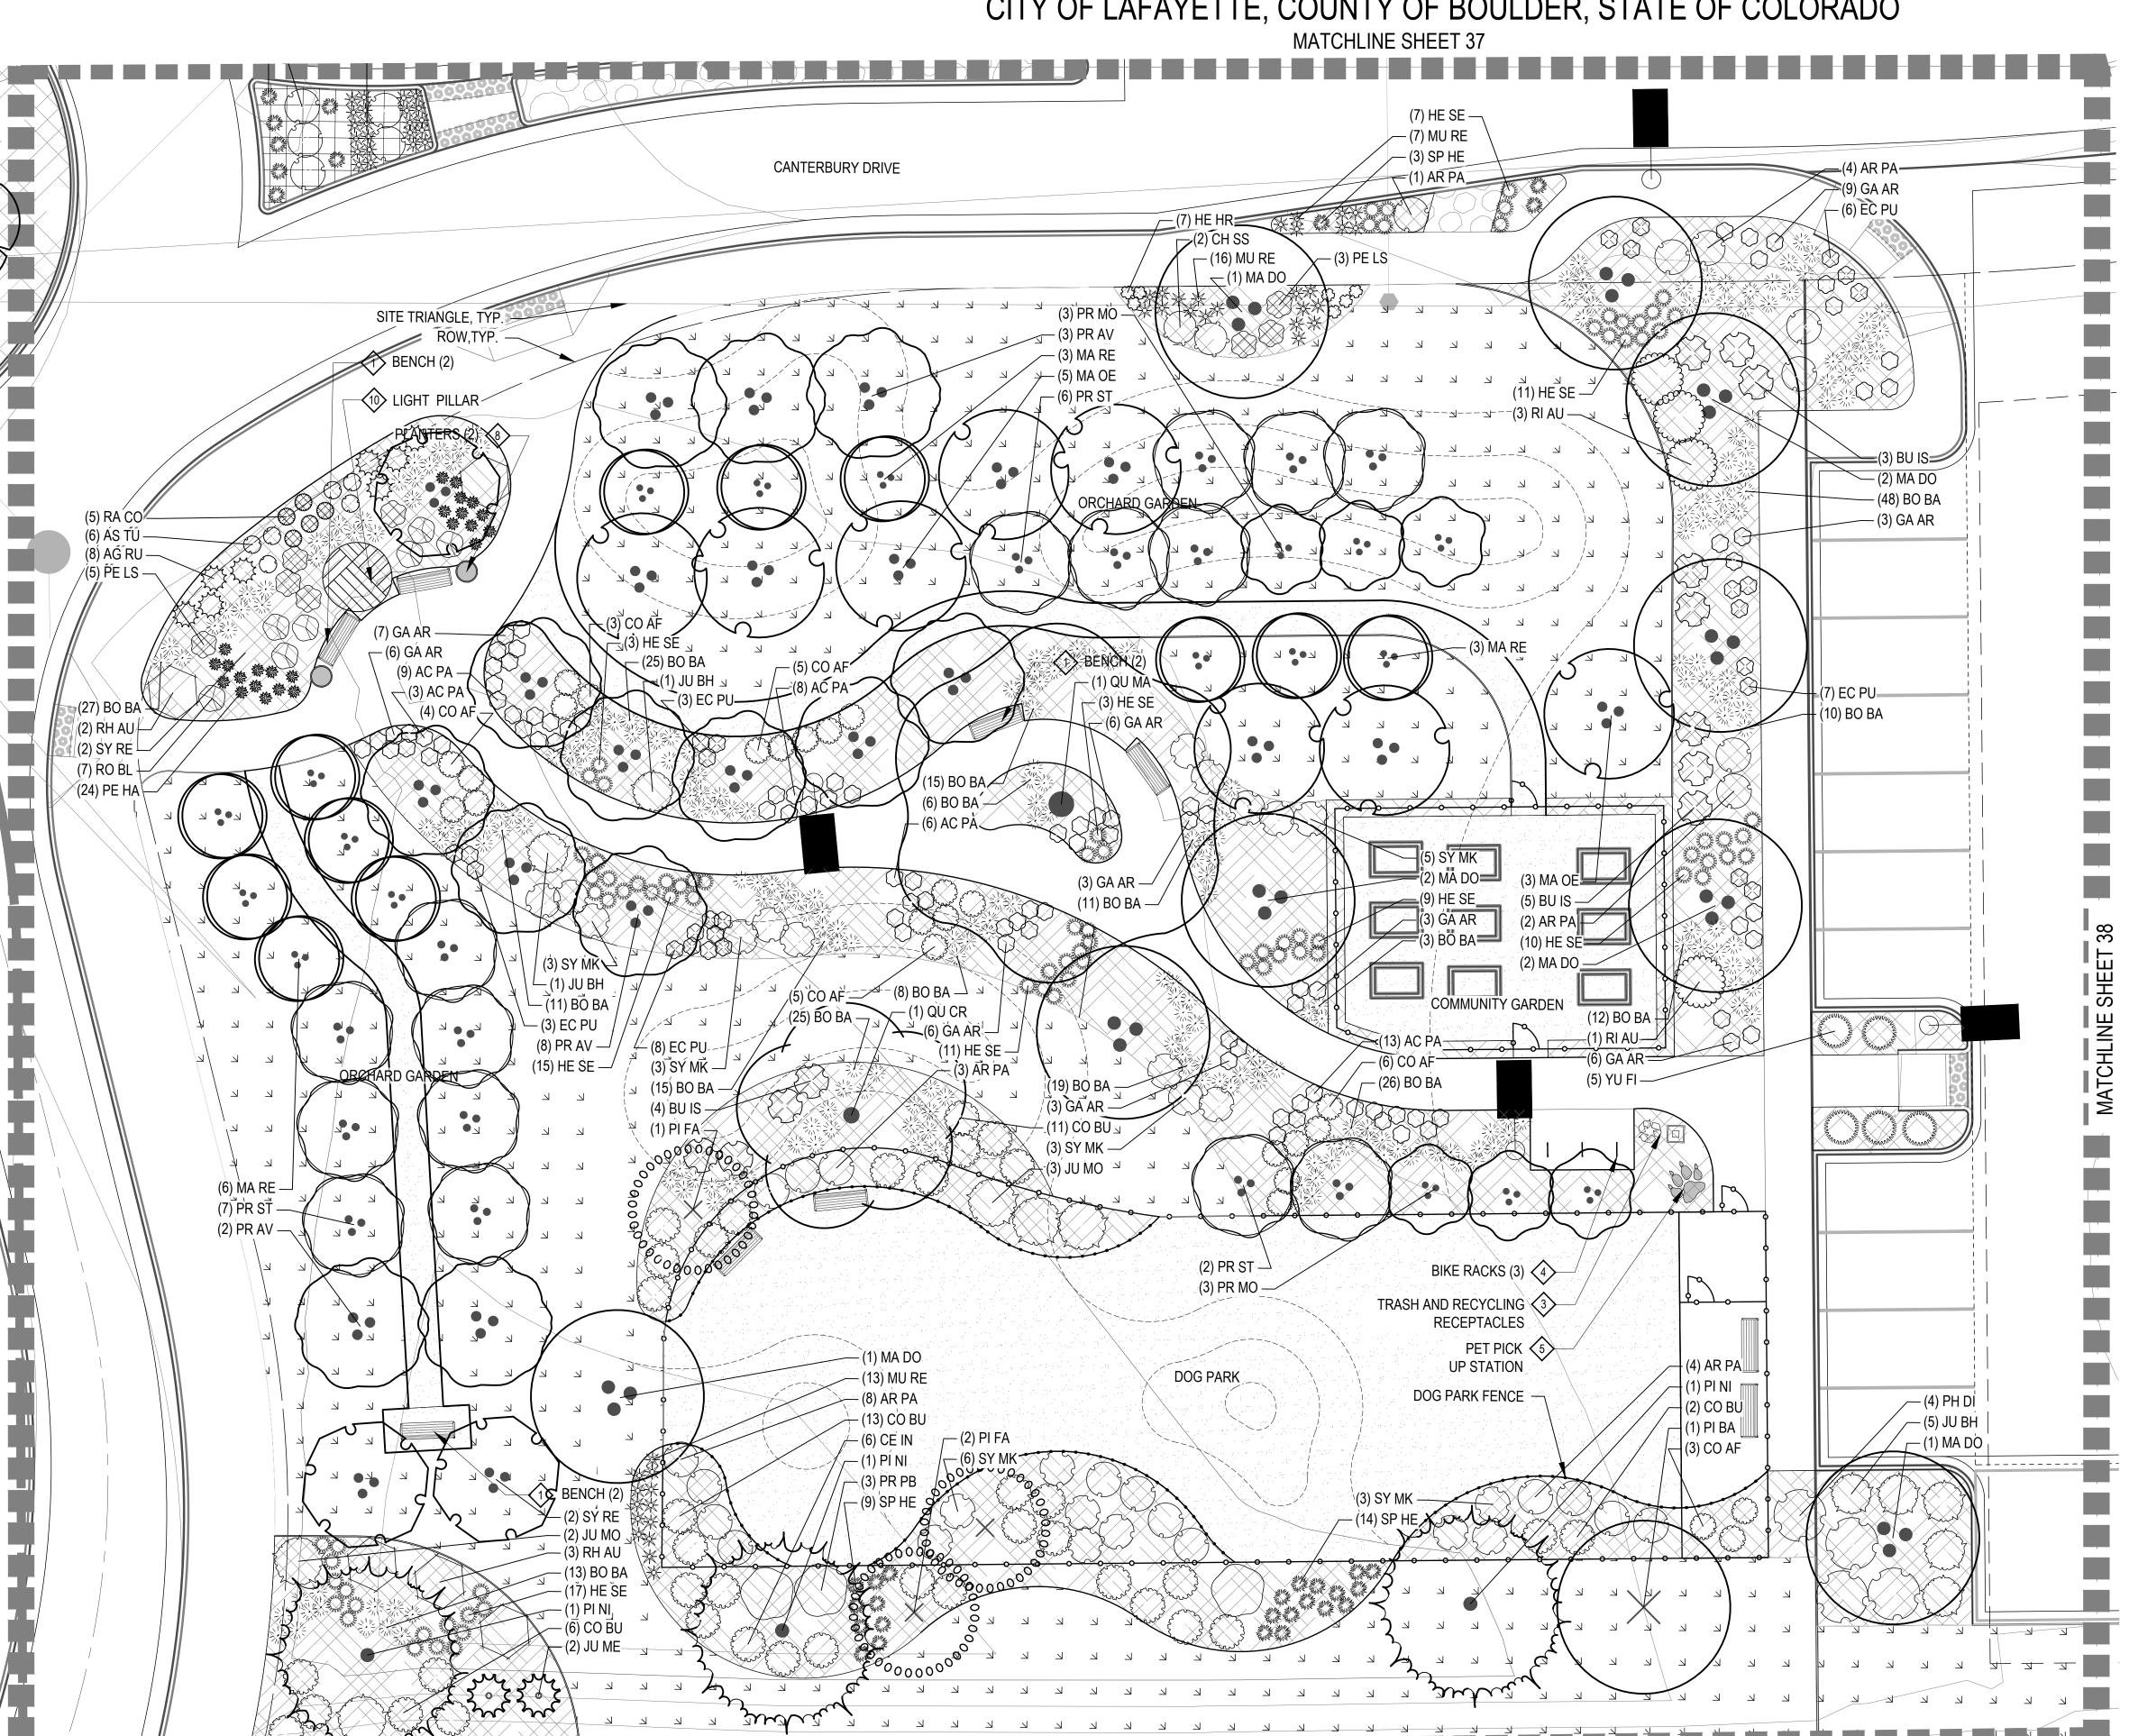
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ENLARGEMENT
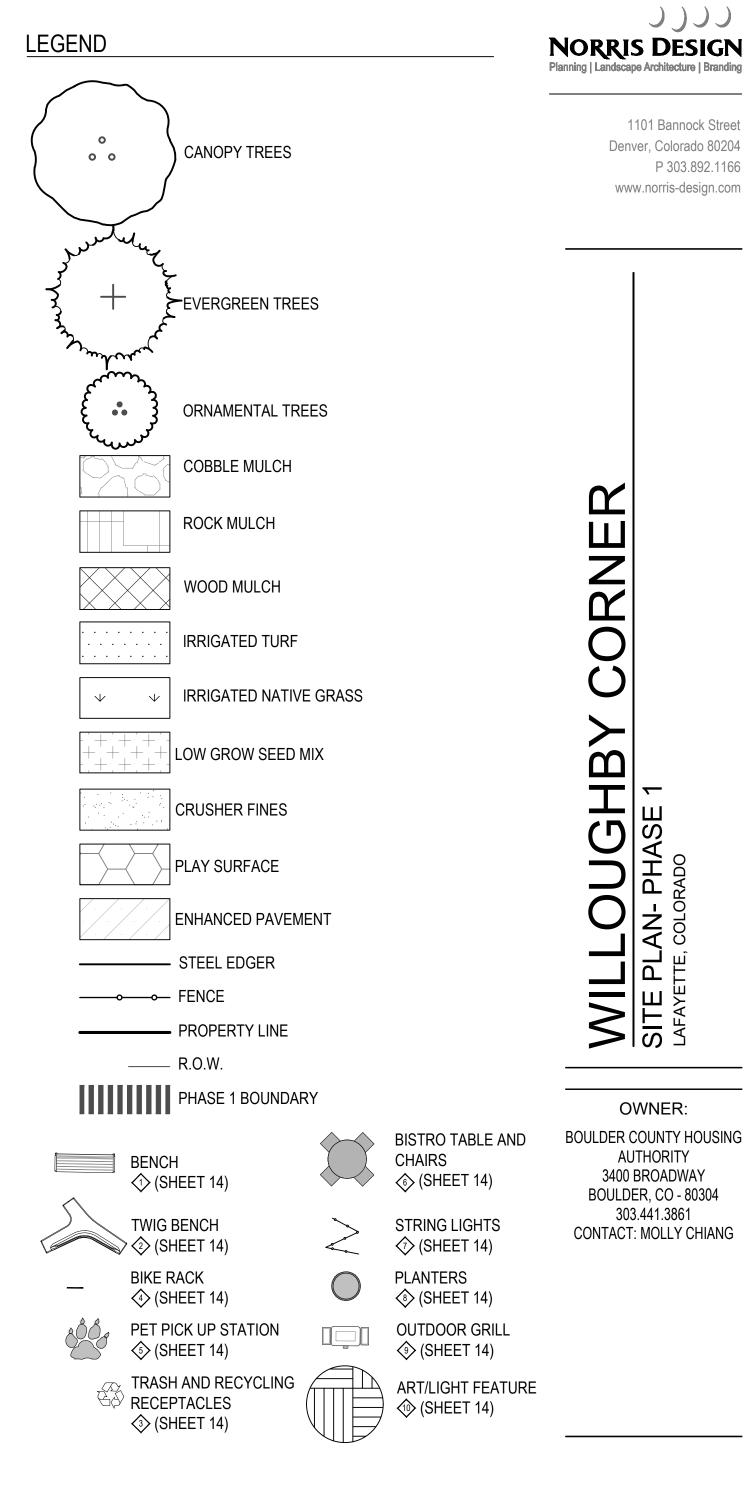
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OUTDOOR GRILL (SHEET 14) ART/LIGHT FEATURE ♦ (SHEET 14)

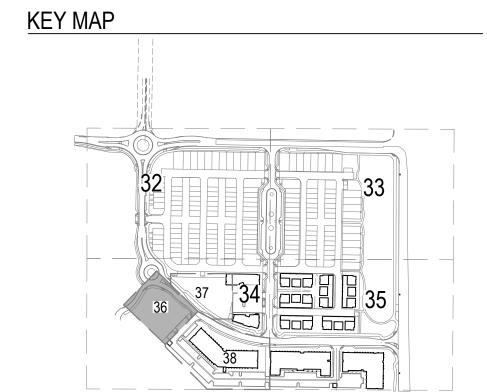BISTRO TABLE AND

CHAIRS

⟨6⟩ (SHEET 14)

STRING LIGHTS ⟨¬> (SHEET 14)

KEY MAP

LEGEND

CANOPY TREES

≻EVERGREEN TREES

COBBLE MULCH

ROCK MULCH

IRRIGATED TURF

CRUSHER FINES

ENHANCED PAVEMENT

PHASE 1 BOUNDARY

♦ (SHEET 14)

TWIG BENCH

BIKE RACK

⟨4⟩ (SHEET 14)

♦ (SHEET 14)


♦ (SHEET 14)

PET PICK UP STATION

BENCH

IRRIGATED NATIVE GRASS



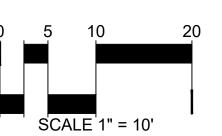

BISTRO TABLE AND 6




LANDSCAPE

ENLARGEMENT

SHEET TITLE:

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LEGEND

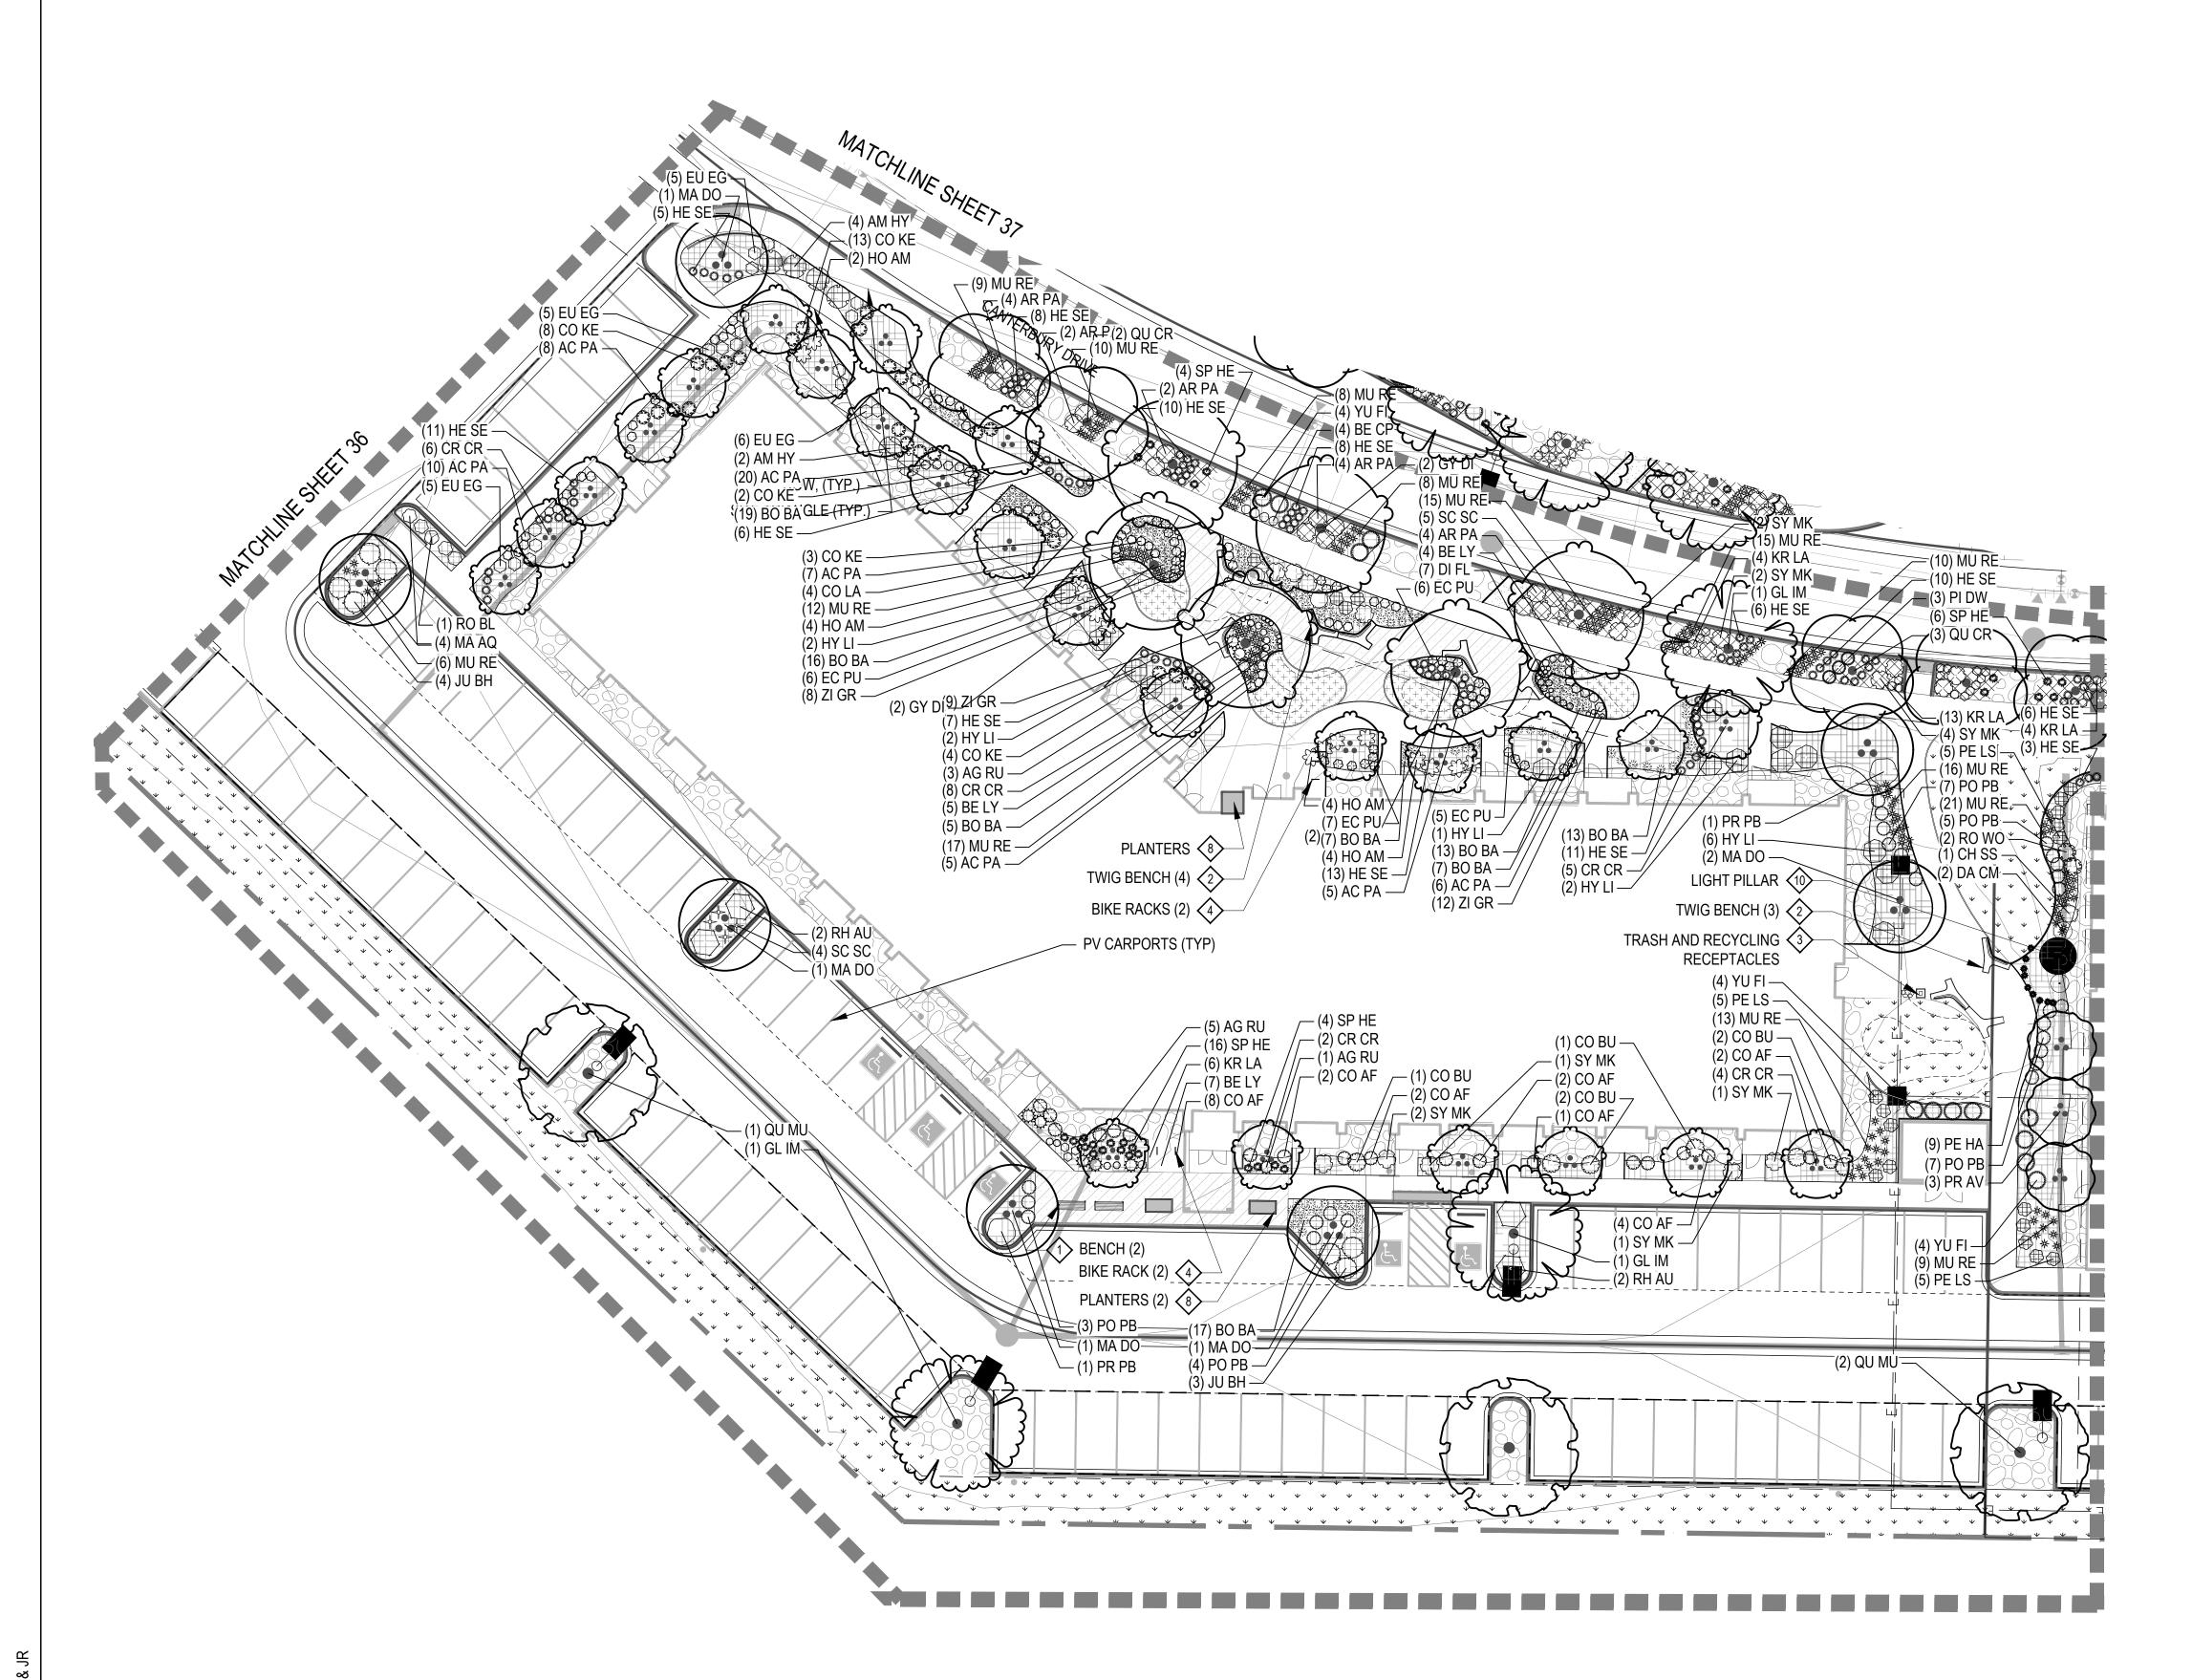ROCK MULCH

WOOD MULCH

IRRIGATED TURF

IRRIGATED NATIVE GRASS

NATIVE WETLAND GRASS

NATIVE WILDFLOWER MIX

LOW GROW SEED MIX

CRUSHER FINES

PLAY SURFACE

— STEEL EDGER

######## PHASE 1 BOUNDARY

♦ (SHEET 30)

♦ (SHEET 30)

PET PICK UP STATION

TRASH AND RECYCLING

■

RECEPTACLES

(SHEET 30)

KEY MAP

BIKE RACK ♦ (SHEET 30)

——⊶ FENCE

____ R.O.W.

ENHANCED PAVEMENT

BISTRO TABLE AND

♠ (SHEET 30)

STRING LIGHTS

PLANTERS
(SHEET 30)

OUTDOOR GRILL

(SHEET 30)

ART/LIGHT FEATURE

(SHEET 30)

CHAIRS

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SHEET TITLE: LANDSCAPE **ENLARGEMENT**

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HEIGHT 2X CONTAINER

1 SET SHRUB ROOT-BALL 1" HIGHER THAN FINISH GRADE

(2) FINISH GRADE (TOP OF

(3) SPECIFIED MULCH, REFER TO MATERIAL SCHEDULE, SHEET

(4) TILL IN SPECIFIED SOIL AMENDMENT TO A DEPTH OF 8" IN BED

(5) BACKFILLED AMENDED SOIL

(6) UNDISTURBED SOIL

1. BROKEN OR CRUMBLING ROOT-BALLS WILL BE REJECTED

3. ALL JUNIPERS SHOULD BE PLANTED SO THE TOP OF THE ROOT-BALL OCCURS ABOVE THE FINISH GRADE OF THE MULCH LAYER.

4. DIG PLANT PIT TWICE AS WIDE AND AS HIGH AS THE CONTAINER.

5. PRUNE ALL DEAD OR DAMAGED WOOD PRIOR TO PLANTING, DO NOT PRUNE MORE THAN 20%

SHRUB PLANTING

(1) 2'-6" WOODEN STAKE DRIVEN INTO THE GROUND NEXT TO ROOTBALL, 18" OF THE STAKE MUST BE VISIBLE

SCALE: 1 1/2" = 1'-0"

(2) SET SHRUB ROOTBALL 1" HIGHER THAN FINISH GRADE

(3) FINISH GRADE (TOP OF NATIVE

(4) SPECIFIED NATIVE SEED

1X CONTAINER

HEIGHT

(5) TILL SPECIFIED SOIL AMENDMENT TO A DEPTH OF

6 UNDISTURBED GRADE

BROKEN OR CRUMBLING ROOT-BALLS WILL BE REJECTED.

CARE SHOULD BE TAKEN NOT TO DAMAGE THE SHRUB OR ROOT-BALL WHEN REMOVING IT FROM ITS CONTAINER.

2X CONTAINER

3. ALL JUNIPERS SHOULD BE PLANTED SO THE TOP OF THE ROOT-BALL OCCURS ABOVE THE FINISH GRADE OF THE MULCH LAYER.

4. DIG PLANT PIT TWICE AS WIDE AND AS HIGH AS THE CONTAINER.

5. PRUNE ALL DEAD OR DAMAGED WOOD PRIOR TO PLANTING, DO NOT PRUNE MORE THAN 20%

ROOT PROTECTION ZONE

VARIES PER TREE SIZE

EXTENDS FROM DRIPLINE TO DRIPLINE

SHRUB PLANTING IN NATIVE AREAS

SCALE: 1 1/2" = 1'-0"

TREE PROTECTION NOTES


ACTIVITIES.

BRANCH PROTECTION PROTECT LOWER BRANCHES OF TREE CANOPY. PROVIDE CONSTRUCTION FENCING OR EQUAL AT DRIPLINE

PLACE SIGNS:

KEEP OUT TREE PROTECTION

EVERY 50' ATTACHED TO FENCING

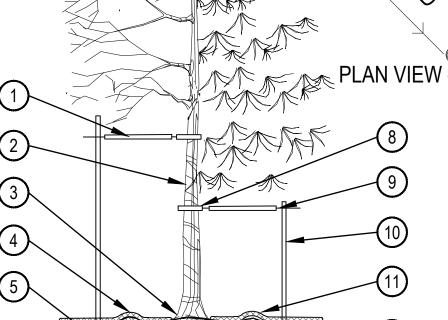

ROOT BALL DIAMETER

1. $\,$ ALL TREES AND SHRUBS TO BE PROTECTED AND PRESERVED SHALL BE PER DETAIL. GROUPING OF MORE THAN ONE TREE MAY OCCUR

3. TO PREVENT ROOT SMOTHERING, SOIL STOCKPILES, SUPPLIES, EQUIPMENT OR ANY OTHER MATERIAL SHALL NOT BE PLACED OR STORED

5. TRENCHES SHALL BE HAND DUG WITHIN THE DRIP LINE IN AREAS WHERE ROOTS TWO INCHES IN DIAMETER AND GREATER ARE PRESENT, OR

6. WHEN ROOT CUTTING IS UNAVOIDABLE, A CLEAN SHARP CUT SHALL BE MADE TO AVOID SHREDDING OR SMASHING. ROOT CUTS SHOULD BE

SUPPLIES ARE HIGH AND CONDITIONS ARE LEAST FAVORABLE FOR DISEASE CAUSING AGENTS. EXPOSED ROOTS SHALL BE COVERED

9. FENCING MATERIAL SHALL ENCIRCLE ANY TREE OR SHRUB WHOSE OUTER DRIP LINE EDGE IS WITHIN 20 FEET OF ANY CONSTRUCTION

11. FENCING MATERIAL SHALL BE SET AT THE DRIP LINE OR 15 FEET FROM TREE TRUNK, WHICHEVER IS GREATER, AND MAINTAINED IN AN UPRIGHT

12. ANY GRADE CHANGES (SUCH AS THE REMOVAL OF TOPSOIL OR ADDITION OF FILL MATERIAL) WITHIN THE DRIP LINE SHOULD BE AVOIDED FOR

EXISTING TREES TO REMAIN. RETAINING WALLS AND TREE WELLS ARE ACCEPTABLE ONLY WHEN CONSTRUCTED PRIOR TO GRADE CHANGE.

WHEN IN CLOSE PROXIMITY TO LOW BRANCHING TREES. WHENEVER POSSIBLE, ROOTS TWO INCHES OR GREATER IN DIAMETER SHALL BE

MADE BACK TO A LATERAL ROOT. WHENEVER POSSIBLE, ROOTS SHOULD BE CUT BETWEEN LATE FALL AND BUD OPENING, WHEN ROOT ENERGY

2. TREES AND SHRUBS TO BE PROTECTED AND PRESERVED SHALL BE IDENTIFIED ON THE TRUNK WITH WHITE SURVEY TAPE.

IMMEDIATELY TO PREVENT DEHYDRATION. ROOTS SHALL BE COVERED WITH SOIL OR BURLAP AND KEPT MOIST

10. FENCING MATERIAL SHALL BE BRIGHT, CONTRASTING COLOR, DURABLE, AND A MINIMUM OF FOUR FEET IN HEIGHT.

7. WATERING OF PROTECTED TREES IN WHICH ROOTS WERE CUT SHALL BE PROVIDED BY THE CONTRACTOR.

8. AUGER TUNNELING RATHER THAN TRENCHING SHOULD BE USED FOR UTILITY PLACEMENT WITHIN DRIP LINE

WITHIN THE DRIP LINE OR WITHIN 15 FEET OF A TREE OR SHRUB TRUNK, WHICHEVER IS GREATER.

— O.C. SPACING

PERENNIAL PLANT LAYOUT

4. TREE AND SHRUB ROOTS SHALL NOT BE CUT UNLESS CUTTING IS UNAVOIDABLE.

POSITION THROUGHOUT THE DURATION OF CONSTRUCTION ACTIVITIES.

13. REFER TO PLANS FOR FENCE STAKING LOCATIONS.

TUNNELED OR BORED UNDER AND SHALL BE COVERED TO PREVENT DEHYDRATION.

TREE PLANTING DETAIL

1) SPECIFIED MULCH

(3) CENTER OF PLANT

WHEN PLANTED ON A CURVE ORIENT ROWS TO FOLLOW

THE LONG AXIS OF AREAS WHERE PLANTS ARE MASSED

2 AMENDED PLANTING BED TILLED TO A DEPTH OF 6"

ALL PRUNING SHALL COMPLY WITH ANSI A300 STANDARDS

DO NOT HEAVILY PRUNE THE TREE AT PLANTING. PRUNE ONLY CROSSOVER LIMBS, CO-DOMINANT LEADERS AND BROKEN BRANCHES. SOME INTERIOR TWIGS AND LATERAL BRANCHES MAY BE PRUNED. HOWEVER, DO NOT REMOVE THE TERMINAL BUDS OF BRANCHES THAT EXTEND TO THE EDGE OF THE CROWN.

STAKING NOTES: STAKE TREES PER FOLLOWING SCHEDULE, THEN REMOVE AT END OF FIRST **GROWING SEASON. FOLLOWS**

1-1" CALIPER SIZE - MIN. 1 STAKE ON SIDE OF PREVAILING WIND (GENERALLY N.W. SIDE) $1-\frac{1}{2}$ " - 3" CALIPER SIZE - MIN. 2 STAKES - ONE ON N.W. SIDE, ONE ON

S.W. SIDE (OR PREVAILING WIND SIDE AND 180° FROM THAT SIDE) 1.3 3" CALIPER SIZE AND LARGER - 3 STAKES PER DIAGRAM

WIRE OR CABLE SHALL BE MIN. 12 GAUGE, TIGHTEN WIRE OR CABLE ONLY ENOUGH TO KEEP FROM SLIPPING. ALLOW FOR SOME TRUNK MOVEMENT NYLON STRAPS SHALL BE LONG ENOUGH TO ACCOMMODATE 1-7" OF GROWTH AND BUFFER ALL BRANCHES FROM WIRE.

EACH WIRE. EXPOSED WIRE SHALL BE MAX. 2" EACH SIDE

TREE WRAP TO BE INSTALLED **ONLY FROM OCTOBER 1** THROUGH APRIL 30. (DECIDUOUS

3 PLANT TREE SO THAT FIRST ORDER MAJOR ROOT IS 1"-2" ABOVE FINAL GRADE.

3" DEEP MULCH RING PLACED A

MINIMUM OF 4 FT. IN DIAMETER. DO NOT PLACE MULCH IN CONTACT WITH TREE TRUNK (FINISHED GRADE REFERENCES TOP OF MULCH). STREET TREES (12) BACKFILL WITH BLEND OF LEGEND ON LANDSCAPE PLANS. TREES OUTSIDE OF WOOD MULCH HATCH CAN BE MULCHED (13) PLACE ROOT BALL ON WITH ROCK MULCH

(5) 1:1 SLOPE ON SIDES OF PLANTING

6 REMOVE ALL TWINE, ROPE, **ROOT BALL AND TRUNK**

(1) PLACE MIN. ½" PVC PIPE AROUND (7) PLACE SOIL AROUND ROOT BALL FIRMLY, DO NOT COMPACT OR TAMP. SETTLE SOIL WITH WATER

(8) GROMMETED NYLON STRAPS

TO FILL ALL AIR POCKETS.

(9) GALVANIZED WIRE, MIN. 12 GAUGE CABLE - TWIST WIRE ONLY TO KEEP FROM SLIPPING. (10) 6 FT. STEEL T-POST (SEE

SCHEDULE). ALL SHALL BE DRIVEN OUTSIDE ROOTBALL AND IN UNDISTURBED SOIL.

(11) 4-6" HIGH WATER SAUCER IN

20% (BY VOLUME) ORGANIC MATERIAL. WATER THOROUGHLY WHEN BACKFILLING

UNDISTURBED SOIL TO PREVENT SETTLEMENT

BURLAP AND WIRE FROM ENTIRE

SCALE: 3/16" = 1'-0"

1 BOULDER, FROM LOVELAND BUFF OR SILOAM STONE. NATURALLY SET BOULDER SO THAT A MINIMUM 1/4 OF **BOULDER IS BELOW FINISH**

(2) SPECIFIED MULCH, CRUSHER PLAN

(3) 3" MINIMUM ROAD BASE COMPACTED TO 95% OF STANDARD PROCTOR DENSITY

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4 UNDISTURBED GRADE

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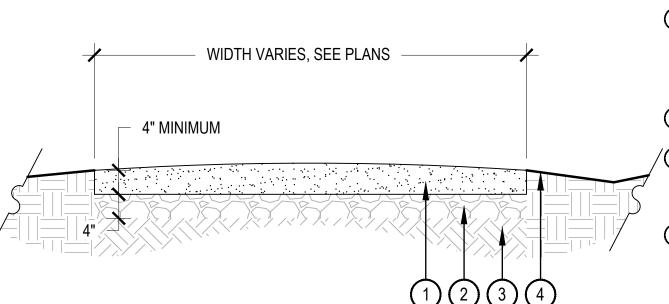
THESE ARE FREE STANDING BOULDERS ONLY. BOULDERS ASSOCIATED WITH THE BOULDER RETAINING WALLS, PARK ENTRY SIGNS AND INTERPRETIVE SIGNS ARE NOT INCLUDED IN THIS

THE OWNERS REPRESENTATIVE SHALL APPROVE LOCATIONS AND SIZES OF ALL BOULDERS

CONTRACTOR SHALL SUBMIT SAMPLE OR PHOTOS FOR APPROVAL

LANDSCAPE BOULDER

SCALE: 3/4" = 1'-0"



(1) COMPACTED, STABILIZED CRUSHER FINES, REFER TO MATERIAL SCHEDULE, SHEET

(2) AGGREGATE BASE

 $^{\prime}$ (3) SUBGRADE COMPACTED TO 95% STANDARD PROCTOR

COMPACT CRUSHER FINES WET, COMPACT TO 95% STANDARD PROCTOR DENSITY.

USE A SMALL 4' RIDING ROLLER TO COMPACT TRAIL IN (2) 2" LIFTS.

CROWN OF 2% IN FLAT AREAS AS SHOWN. CROSS SLOPE TRAIL AT 1-2% WITH GRADE WHERE TOPOGRAPHY DICTATES.

APPLY STABILIZER/TACKIFIER TO CRUSHER FINES SURFACE.

CRUSHER FINES TRAIL

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(4) SLOPE ADJACENT GRADE AWAY FROM TRAIL

SHEET TITLE: LANDSCAPE **DETAILS**

TREE AND SHRUB PROTECTION

TRUNK PROTECTION

CONSTRUCTION

REQUIRED IF WHEELED

EQUIPMENT INVOLVED

1" BOARDS NOT LESS

REACH FIRST SCAFFOLD

BRANCH. WIRE TO HOLD

BOARDS IN PLACE, NO

INCLUDE WRAPPING OF

BURLAP UNDER BOARDS

NAILS PERMITTED


THAN 5' LONG OR TO

WITHIN 20' OR LESS

SCALE: 1" = 1'-0"

SCALE: 1/8" = 1'-0"

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JGHBY CORNER

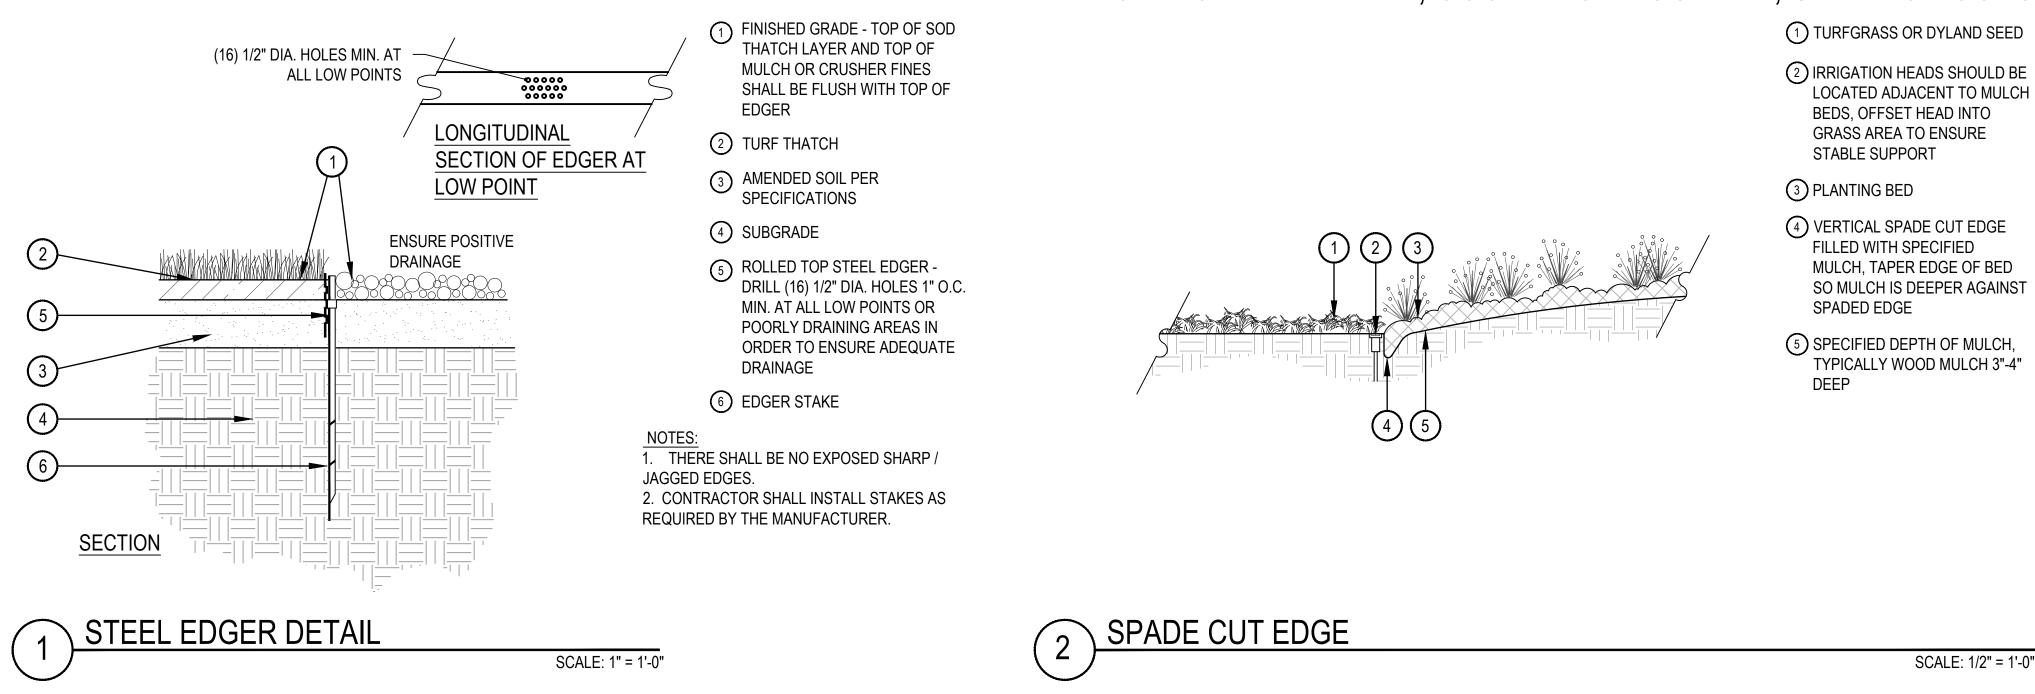OWNER:
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AUTHORITY
3400 RPOADWAY

AUTHORITY
3400 BROADWAY
BOULDER, CO - 80304
303.441.3861
CONTACT: MOLLY CHIANG

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SHEET TITLE: LANDSCAPE DETAILS

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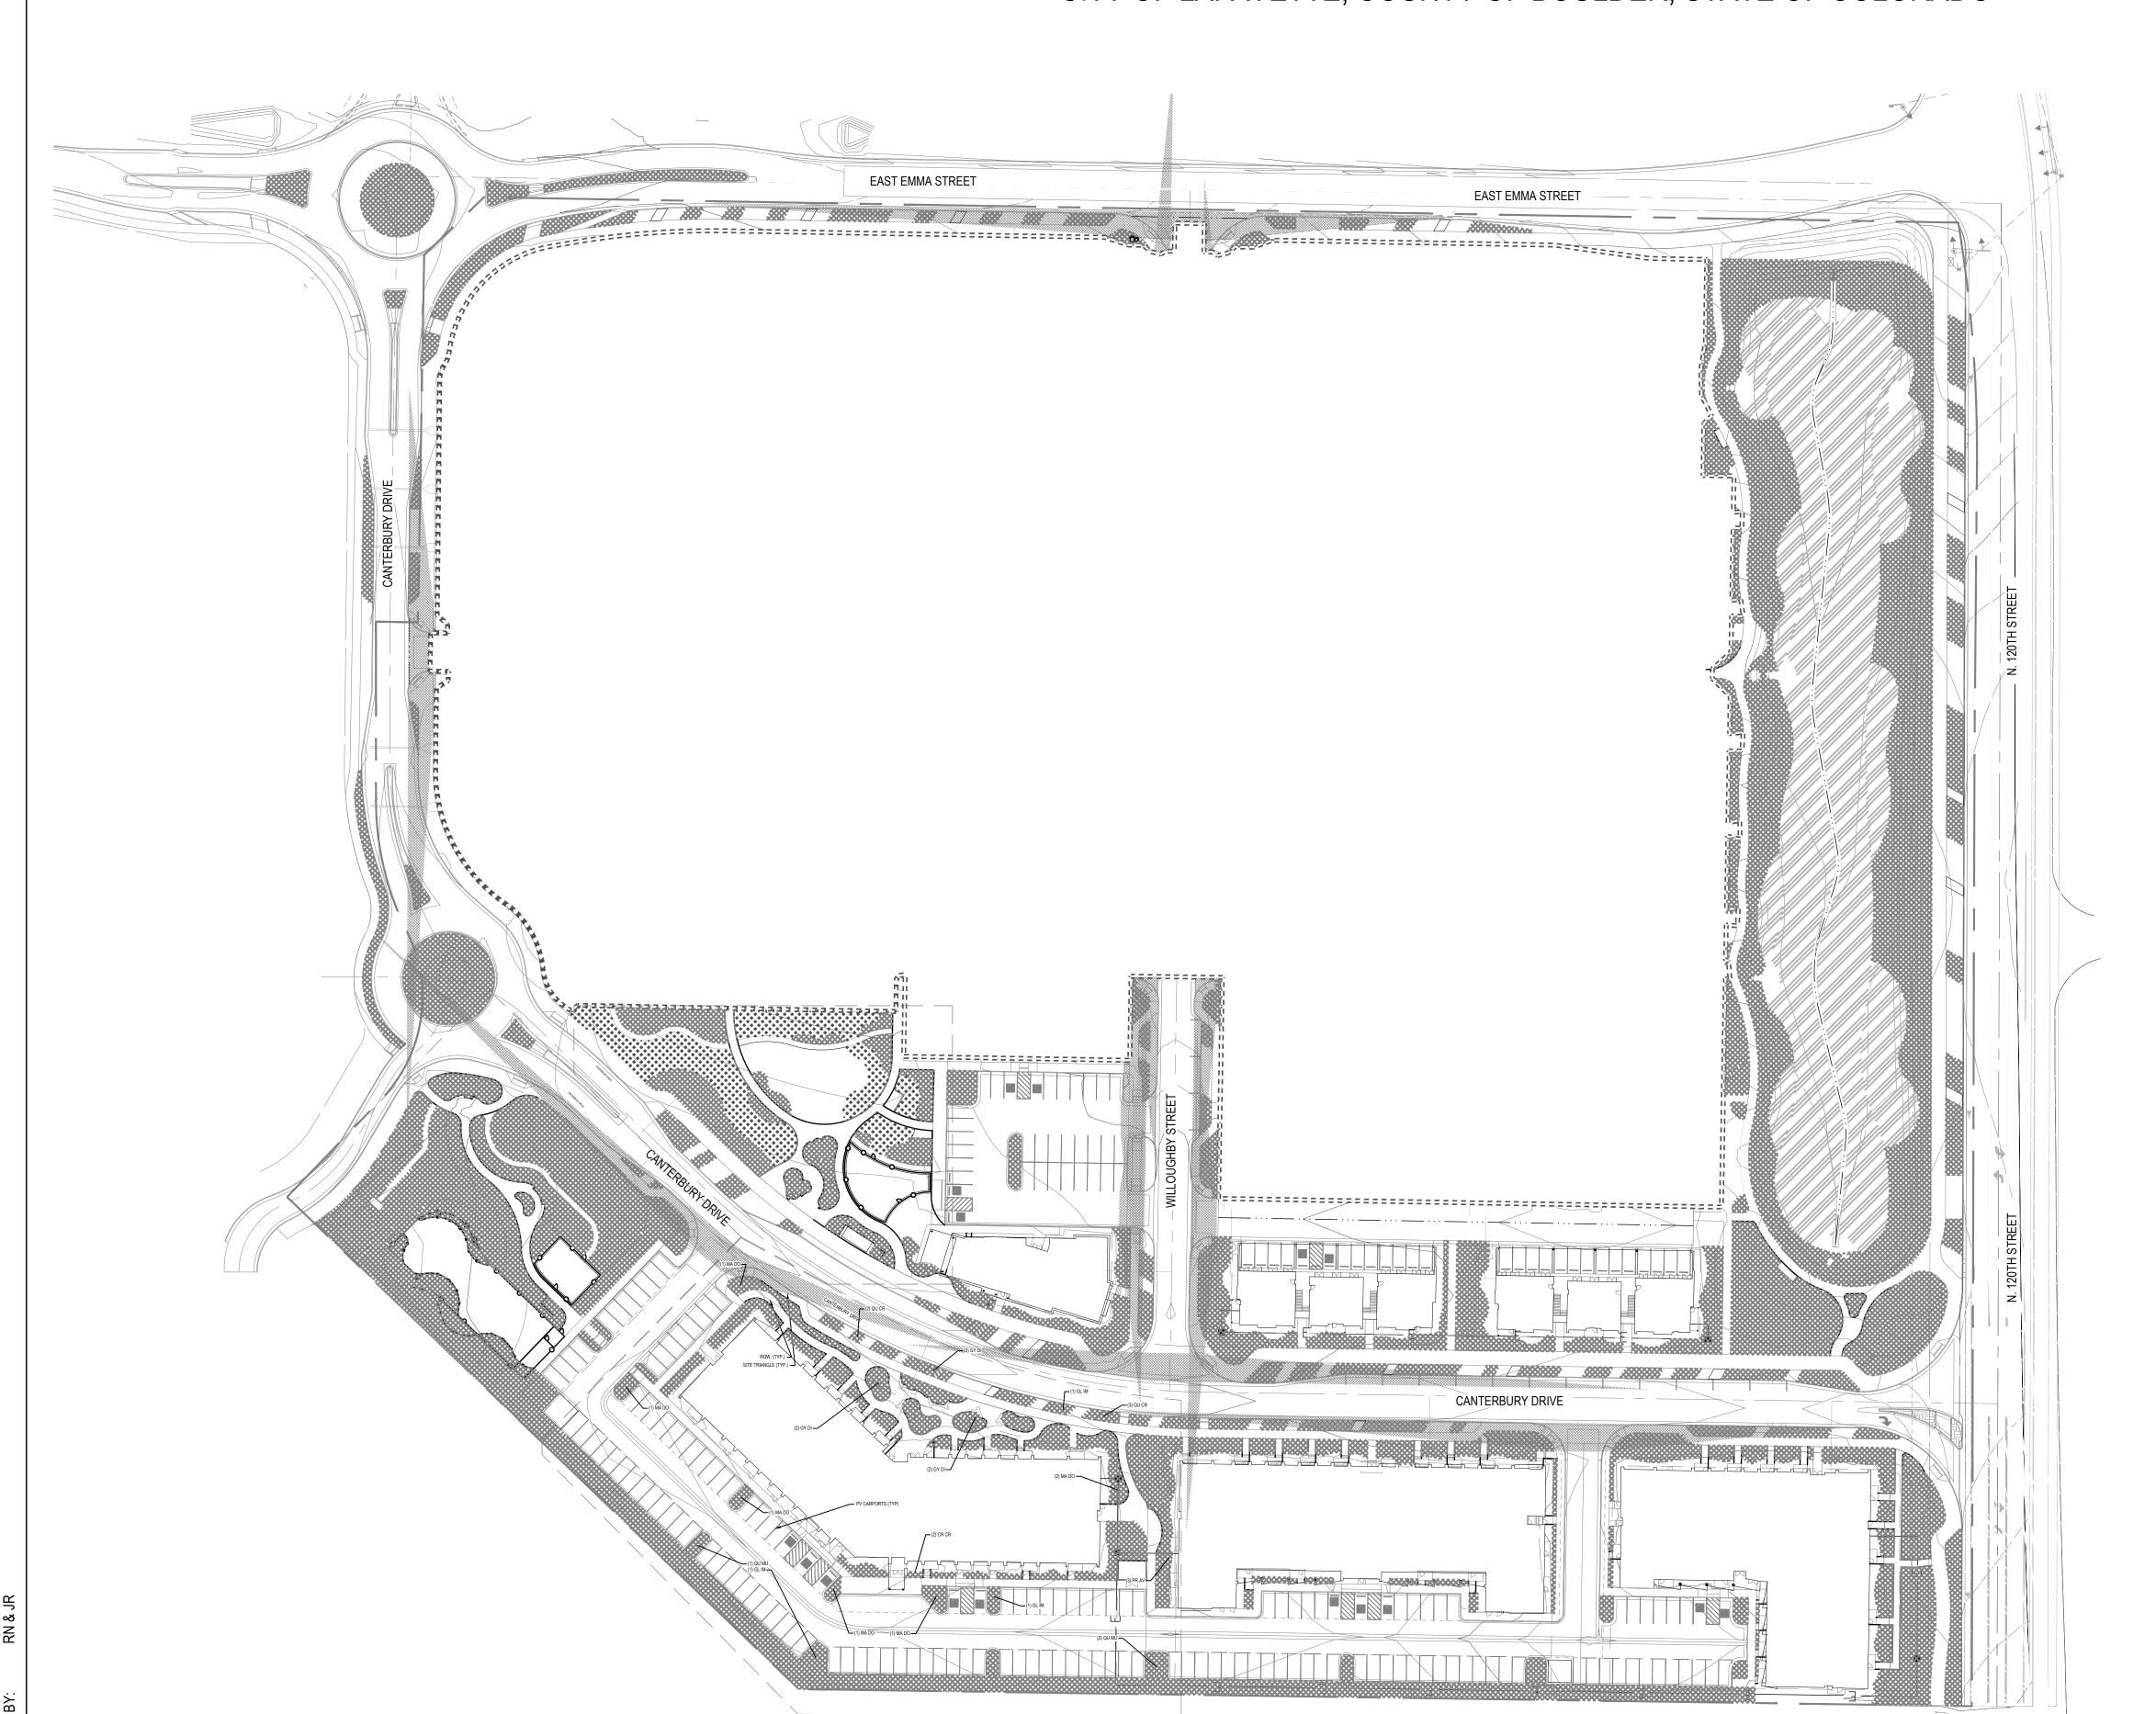
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WATER USE PLAN


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WILLOUGHBY CORNER SITE PLAN - PHASE 1

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LEGEND



WATER USE CHARTS

Water Required by Phase				
	dwelling	acre-		CBT (.7/
	units	feet/unit	acre-feet	acre-feet)
Phase 1 Dwelling Units	192	0.25	48	68.57143
Phase 1 Community building	1	0.83	0.83	1.185714
Phase 1 Landscaping	1	5.5	5.5	7.857143
Phase 1 Total Water Required			54.33	77.61429

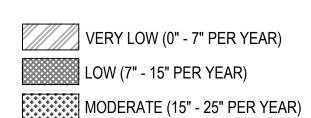Water Required by Residentail Buil				
	dwelling			CBT (.7/
Phase 1 Dwelling Units	units	feet/unit	acre-feet	acre-feet)
Senior Building	63	0.25	15.75	22.5
Multifamily 1	60	0.25	15	21.42857
Multifamily 2	51	0.25	12.75	18.21429
9-Plex Flats	18	0.25	4.5	6.428571
Phase 1 subtotal	192		48	68.57143

DETAIL

AND SHEET

SHEET TITLE: **IRRIGATION** SCHEDULE

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IRRIGATION POINT OF CONNECTION NOTES

- POINT OF CONNECTION: THERE IS TWO (2) POINTS OF CONNECTION ON THIS PROJECT
- POC #1: X" DEDICATED IRRIGATION WATER METER LOCATED AT (EDIT LOCATION HERE).
- CONTRACTOR IS TO LOCATE AND CONNECT DOWNSTREAM OF THE DEDICATED POTABLE IRRIGATION WATER METER (PROVIDED BY OTHERS) WITH TYPE K COPPER AT A DEPTH OF 48" OR PER LOCAL CODE, WHICHEVER IS GREATER. EXTEND COPPER TO BACKFLOW PREVENTION UNIT. EXTEND COPPER TUBING MINIMUM 30" HORIZONTAL FROM BACKFLOW PREVENTER AND INSTALL ONE MANUAL DRAIN, TRANSITION TO AND EXTEND CLASS 200 PVC MAINLINE TO THE 1" QUICK COUPLER, MASTER VALVE, FLOW SENSOR, GATE VALVE, AND EXTEND MAINLINE TO VALVES AS SHOWN.
- ALL PIPING FROM THE DEDICATED IRRIGATION POTABLE METER THROUGH DRAIN VALVE DOWNSTREAM OF THE BACKFLOW PREVENTION UNIT SHALL BE THE SAME SIZE AS THE METER UNLESS OTHERWISE NOTED
- THE CONTRACTOR SHALL CONFORM TO ALL LOCAL CODES, OBTAIN AND PROVIDE PAYMENT FOR ALL PERMITS ASSOCIATED WITH THIS WORK. FINAL LOCATION OF BACKFLOW PREVENTION UNIT SHALL BE APPROVED BY THE OWNER'S REPRESENTATIVE PRIOR TO INSTALLATION.
- 2. CONTROLLER LOCATION: THERE IS TWO (2) CONTROLLERS ON THIS PROJECT
 - CONTROLLER A: PEDESTAL MOUNTED CONTROLLER LOCATED (EDIT LOCATION HERE).
 - CONTROLLER SHALL BE PROGRAMMED TO RUN MULTIPLE VALVES AT ONE TIME WITH A MAXIMUM TOTAL OF TBD GPM
 - CONTROLLER, TO BE MOUNTED PER DETAILS AND MANUFACTURER'S SPECIFICATIONS
 - CONTRACTOR TO COORDINATE WITH OWNER'S REPRESENTATIVE AND ELECTRICAL PLANS FOR POWER SERVICE. ALL ELECTRICAL EQUIPMENT AND POWER CONNECTION INSTALLATION SHALL CONFORM TO ALL LOCAL CODES. INSTALL A LINE VOLTAGE SURGE DEVICE (INTERMATIC AG2401C3/ OR SQUARE D SDSA1175) FOR 120V IN A JUNCTION BOX PRIOR TO CONTROLLER.
 - RAIN/FREEZE SENSOR: MOUNT THE RAIN SENSOR ON BUILDING EAVE / POLE IN PROXIMITY TO THE CONTROLLER. THE SENSOR SHALL BE MOUNTED IN A LOCATION IN FULL SUN AND OPEN TO RAINFALL. SENSOR SHALL BE NO MORE THAN 200' FROM WIRELESS RECEIVER. MOUNT WIRELESS RECEIVER ON OR ADJACENT TO THE IRRIGATION CONTROLLER.
 - CONTROLLER B: PEDESTAL MOUNTED CONTROLLER LOCATED (EDIT LOCATION HERE).
 - CONTROLLER SHALL BE PROGRAMMED TO RUN MULTIPLE VALVES AT ONE TIME WITH A MAXIMUM TOTAL OF TBD GPM
 - CONTROLLER, TO BE MOUNTED PER DETAILS AND MANUFACTURER'S SPECIFICATIONS.
 - CONTRACTOR TO COORDINATE WITH OWNER'S REPRESENTATIVE AND ELECTRICAL PLANS FOR POWER SERVICE. ALL ELECTRICAL EQUIPMENT AND POWER CONNECTION INSTALLATION SHALL CONFORM TO ALL LOCAL CODES. INSTALL A LINE VOLTAGE SURGE DEVICE (INTERMATIC AG2401C3/ OR SQUARE D SDSA1175) FOR 120V IN A JUNCTION BOX PRIOR TO CONTROLLER.
 - RAIN/FREEZE SENSOR: MOUNT THE RAIN SENSOR ON BUILDING EAVE / POLE IN PROXIMITY TO THE CONTROLLER. THE SENSOR SHALL BE MOUNTED IN A LOCATION IN FULL SUN AND OPEN TO RAINFALL. SENSOR SHALL BE NO MORE THAN 200' FROM WIRELESS RECEIVER. MOUNT WIRELESS RECEIVER ON OR ADJACENT TO THE IRRIGATION CONTROLLER
- SYSTEM PRESSURE: THE SYSTEM HAS BEEN DESIGNED PER THE FOLLOWING SPECIFICATIONS: REQUIRED MINIMUM STATIC
- PRESSURE OF TBD PSI AND MAXIMUM SAFE VELOCITY OF 5 FPS IN ANY PVC PIPE AND 7.5 FPS IN ANY COPPER PIPE PER (WATER PURVEYOR/CITY WATER) THE STATIC PRESSURE ON SITE IS APPROXIMATELY XX PSI
- PRESSURE OF THE SYSTEM AND THE MEASURED PRESSURE IN THE FIELD. IF THE CONTRACTOR FAILS TO NOTIFY OWNER'S REPRESENTATIVE OF SUCH DISCREPANCIES, THEN THE CONTRACTOR ASSUMES ALL LIABILITY AND COSTS ASSOCIATED WITH SYSTEM MODIFICATIONS TO ACCOMMODATE THE ACTUAL PRESSURE
- FLOW SENSOR: SENSOR REQUIRES A MINIMUM FLOW FOR PROPER READINGS. MULTIPLE ZONES MAY BE REQUIRED TO RUN SIMULTANEOUSLY TO ACHIEVE THE MINIMUM FLOWS REQUIRED. CONTRACTOR TO SET 'K' VALUES PER MANUFACTURER.
- 4. FLOW SENSOR TBD REQUIRES A MINIMUM FLOW OF TBD GPM.
- 5. COMMUNICATION: IT IS RECOMMENDED THAT THE IRRIGATION CONTROLLER BE CONNECTED TO A WATER MANAGEMENT CONTROL SOFTWARE FOR OPTIMUM FUNCTION OF THE IRRIGATION SYSTEM. COORDINATE WITH OWNER'S REPRESENTATIVE AND CONTACT THE LOCAL CONTROLLER MANUFACTURER REPRESENTATIVE OR AUTHORIZED VENDOR PRIOR TO ORDERING CONTROLLER FOR COMMUNICATION AND CONNECTIVITY OPTIONS.

TWO WIRE NOTES

- 1. GROUNDING FOR THE IRRIGATION CONTROLLER AND DECODERS ARE TO BE INSTALLED PER THE MANUFACTURER'S SPECIFICATIONS AND PER THE AMERICAN SOCIETY OF IRRIGATION CONSULTANTS GUIDELINE 100-2002 FOR EARTH GROUNDING ELECTRONIC EQUIPMENT IN IRRIGATION SYSTEMS FOUND AT WWW.ASIC.ORG. FOR ADDITIONAL TECHNICAL SUPPORT REGARDING THE IRRIGATION CONTROLLER OR GROUNDING PLEASE CONTACT THE MANUFACTURER.
- DO NOT LOOP TWO WIRE PATH. STAR PATTERN FROM CONTROLLER FOR EACH BRANCH OF MAINLINE.
- 3. CONTRACTOR IS RESPONSIBLE FOR GROUNDING THE TWO-WIRE PATH AT THE FOLLOWING LOCATIONS, BUT ARE NOT LIMITED TO:
- CONTROLLER TO BE GROUNDED INDEPENDENTLY FROM BUILDING.
- GROUND 1ST DECODER ON WIRE PATH FROM CONTROLLER.
- GROUND EVERY 8TH DECODER OR EVERY 500 FEET BETWEEN DECODERS. WHICH EVER LENGTH IS SMALLER.
- GROUND EVERY END OF WIRE PATH.
- 4. THE TWO-WIRE CONTROLLER REQUIRES EACH CONTROL VALVE AND SENSOR TO HAVE A DECODER. IT IS THE RESPONSIBILITY OF THE CONTRACTOR TO PROVIDE THE PROPER DECODERS, SURGE SUPPRESSION AND GROUNDING. THE RAIN SENSOR AND FLOW SENSOR REQUIRE A SENSOR DECODER.
- 5. QTY OF STATIONS (VALVES) PER MANIFOLD REQUIRED DECODER
- SINGLE STATION ICD-100 (HUNTER)
- FLOW SENSOR ICD-SEN (HUNTER)
- 6. CONTROLLER TWO-WIRE PATH SHALL BE MANUFACTURER'S APPROVED WIRE OR APPROVED EQUAL.
- 7. CONTRACTOR SHALL USE UL APPROVED WIRE STRIPPER AND WATERPROOF CONNECTIONS (DBR/Y OR APPROVED EQUAL) AT ALL SPLICES AND CONNECTIONS POINTS.
- 8. PROVIDE 30" MINIMUM TWO WIRE PATH IN EACH VALVE BOX FOR MAINTENANCE.
- CONTRACTOR SHALL INCLUDE TWO-WIRE RUN PATHS ON AS-BUILT DRAWINGS.

SLEEVING COORDINATION NOTES

- INSTALLATION OF IRRIGATION SLEEVING IS THE RESPONSIBILITY OF THE GENERAL CONTRACTOR. THE GENERAL CONTRACTOR SHALL COORDINATE WITH THE IRRIGATION CONTRACTOR FOR LOCATION AND SIZING OF SLEEVES PRIOR TO THE START OF CONSTRUCTION.
- SLEEVES SHALL BE INSTALLED PRIOR TO THE START OF PAVING OPERATIONS.
- THE CONTRACTOR SHALL SLEEVE ALL IRRIGATION DISTRIBUTION LINES, VALVE CONTROL WIRES AND COMMUNICATION WIRES UNDER ALL PAVED SURFACES, WALL FOOTERS, DRAINAGE CHANNELS, INLETS, CATCH BASINS. ETC.
- ALL SLEEVES SHALL EXTEND A MINIMUM OF 12" BEYOND EDGE OF ALL OBSTRUCTIONS. NO TEES, ELLS OR OTHER TURNS IN PIPING SHALL BE LOCATED UNDER ANY OBSTRUCTIONS.
- EACH PIPE SHALL BE IN A SEPARATE SLEEVE. WIRES SHALL BE IN A SEPARATE PIPE UNDER ALL PAVED SURFACES.

X" CLASS 200 PVC

SLEEVING SHALL BE INSTALLED PER THE SIZES AND QUANTITIES SHOWN ON THE PLANS BASED ON THE CHART BELOW PIPING REQUIRED SLEEVE SIZE

MAINLINE PIPING LATERAL PIPING CONTROL WIRES

CHECKED BY:

2X NOMINAL DIAMETER OF LATERAL 2" CLASS 200 PVC

- IRRIGATION GENERAL NOTES
- THE CONTRACTOR SHALL PROVIDE ALL LABOR. MATERIALS AND EQUIPMENT NECESSARY TO INSTALL THE IMPROVEMENTS SHOWN ON
- THE CONTRACTOR SHALL COORDINATE AS NECESSARY WITH THE GENERAL CONTRACTOR AND OWNER'S REPRESENTATIVE FOR SUCCESSFUL COMPLETION OF THIS WORK
- ALL IRRIGATION EQUIPMENT IS TO BE AS SPECIFIED OR APPROVED EQUAL PER THE DISCRETION OF THE OWNER'S REPRESENTATIVE THE CONTRACTOR ASSUMES ALL LIABILITY ASSOCIATED WITH THE MODIFICATION OF THE IRRIGATION SYSTEM DESIGN WITHOUT NOTIFYING THE OWNER'S REPRESENTATIVE.
- 4. IT IS THE CONTRACTOR'S RESPONSIBILITY TO CONDUCT A THOROUGH SITE INSPECTION AND REVIEW OF THE PROJECT CONSTRUCTION DOCUMENTS INCLUDING BUT NOT LIMITED TO THE FOLLOWING: LANDSCAPE PLAN, UTILITY PLAN, CIVIL UTILITY PLAN, ARCHITECTURE PLAN, GRADING AND DRAINAGE PLAN AND ALL OTHER ASSOCIATED PLANS AND SPECIFICATIONS THAT AFFECT THIS WORK PRIOR TO START OF WORK. IF THE AND CONTRACTOR OBSERVES ANY DISCREPANCIES AMONG THE CONSTRUCTION DOCUMENTS AND THE EXISTING CONDITIONS ON SITE. IT IS THEIR RESPONSIBILITY TO CONTACT THE OWNER'S REPRESENTATIVE
- THE CONTRACTOR MUST VERIFY THE LOCATION OF ALL PUBLIC AND PRIVATE UNDERGROUND UTILITIES PRIOR TO CONSTRUCTION. I THE CONTRACTOR FAILS TO DO SO AND DAMAGES ANY UNDERGROUND UTILITIES. THE CONTRACTOR SHALL PAY FOR ANY REPAIR WORK ASSOCIATED WITH SAID DAMAGES.
- 6. IT IS THE CONTRACTOR'S RESPONSIBILITY TO ENSURE ADEQUATE VERTICAL AND HORIZONTAL SEPARATION BETWEEN ALL IRRIGATION DISTRIBUTION LINES AND ALL UTILITIES (EXISTING OR PROPOSED), CONDUIT, STORM WATER COMPONENTS, DRAINS, ETC.
- THE CONTRACTOR SHALL CONFORM TO ALL LOCAL AND STATE REGULATIONS AND INSTALL THE IRRIGATION SYSTEM AND ITS COMPONENTS PER MANUFACTURER'S SPECIFICATIONS. THE CONTRACTOR SHALL OBTAIN AND PROVIDE PAYMENT FOR ALL PERMITS REQUIRED BY ANY LOCAL AND STATE AGENCIES AND UTILITY COMPANIES HAVING JURISDICTION OVER THIS SITE
- THE CONTRACTOR IS RESPONSIBLE FOR SCHEDULING AND PAYING FOR CERTIFICATION OF THE BACKFLOW PREVENTER BY A STATE **ACCEPTANCE**
- 9. IT IS THE INTENT OF THIS DESIGN THAT ALL IRRIGATION EQUIPMENT BE INSTALLED WITHIN LANDSCAPE AREAS AND WITHIN THE PROJECT LIMITS. EQUIPMENT SHOWN OUTSIDE OF THESE LIMITS IS SHOWN FOR GRAPHIC CLARITY ONLY. IF THERE IS A QUESTION REGARDING THE LOCATION OF ANY COMPONENT OF THE IRRIGATION SYSTEM, IT IS THE CONTRACTOR'S RESPONSIBILITY TO CONTACT THE OWNER'S REPRESENTATIVE. IF THE CONTRACTOR NEGLECTS TO NOTIFY THE NECESSARY PARTIES, THE CONTRACTOR SHALL PAY FOR ANY REPLACEMENT OR MODIFICATION TO ENSURE PROPER LOCATION AND OPERATION OF THE IRRIGATION SYSTEM AND ITS COMPONENTS
- ALL IRRIGATION DISTRIBUTION LINES AND EQUIPMENT INCLUDING BUT NOT LIMITED TO, MAINLINE, LATERALS, SPRAY HEADS, DRIP EMITTERS SHALL BE KEPT A MINIMUM DISTANCE OF 6' AWAY FROM ALL BUILDING AND WALL FOUNDATIONS. OR AS STIPULATED IN THE GEOTECHNICAL REPORT, WHICHEVER IS GREATER. EQUIPMENT MAY BE SHOWN IN THIS AREA FOR GRAPHIC CLARITY. COORDINATE ALL REQUIRED SETBACKS WITH OWNER'S REPRESENTATIVE PRIOR TO START OF WORK.
- 11. EACH VALVE SHALL BE INSTALLED IN A SEPARATE VALVE BOX AS DETAILED. ALL VALVE BOXES AND LIDS SHALL BE COMMERCIAL GRADE, PLASTIC WITH SELF LOCKING COVERS. LID COLOR TO BE GREEN. INSTALL FLUSH TO FINISH GRADE AND PER CONSTRUCTION DETAILS. DO NOT INSTALL IN PAVED AREAS OR IN BOTTOMS OF DRAINAGE SWALES/BASINS.
- 12. CONTRACTOR SHALL INSTALL DETECTABLE MARKING TAPE OR #14g DIRECT BURY TRACER WIRE IN ALL PRESSURE MAINLINE TRENCHES. SEE IRRIGATION DETAILS FOR MORE INFORMATION.
- 13. PLANT MATERIAL LOCATIONS TAKE PRECEDENCE OVER ROUTING OF IRRIGATION PIPING. COORDINATE INSTALLATION OF IRRIGATION EQUIPMENT SO THAT IT DOES NOT INTERFERE WITH THE PLANTING OF TREES OR OTHER LANDSCAPE MATERIAL
- 14. THE CONTRACTOR SHALL MARK THE LOCATION OF THE MAINLINE, CONTROL VALVES, GATE VALVES AND HEAD LAYOUT OF A REPRESENTATIVE SPRAY ZONE. SCHEDULE A REVIEW WITH THE OWNER'S REPRESENTATIVE PRIOR TO INSTALLATION. 15. INSTALL SCH. 40 BALL WITH OPERATIONAL INDICATOR AT ENDS OF ALL DRIP LATERALS AS DETAILED. FLUSH ALL LATERALS
- THOROUGHLY BEFORE INSTALLING EMITTERS AND BUBBLERS. 16. CONTRACTOR SHALL FINE TUNE AND ADJUST NOZZLE DIRECTION AND RADIUS TO REDUCE OVERSPRAY ONTO PAVING OR HARD
- 17. CONTRACTOR SHALL INSTALL A QUICK COUPLER IN 10" VALVE BOX AT THE END OF ALL BRANCHES OF THE MAINLINE, OR AS SHOWN
- ON PLANS. FOR WINTERIZATION AND FLUSHING OF MAINLINE. 18. THE CONTRACTOR SHALL PERFORM A PRESSURE TEST ON ALL MAINLINES. CONTRACTOR SHALL PRESSURIZE MAINLINES TO 120 PSI AND MAINTAIN PRESSURE AT 120 PSI FOR A MINIMUM CONTINUOUS PERIOD OF TWO (2) HOURS TO ACHIEVE FINAL ACCEPTANCE.
- 19. THIS IRRIGATION SYSTEM HAS BEEN DESIGNED TO OPERATE DURING A THREE(3) NIGHT PER WEEK, SIXTEEN(16) HOURS PER NIGHT WATERING WINDOW. DRIP IRRIGATION ZONES MAY BE ALLOWED TO RUN ON A SEPARATE SCHEDULE FROM THIS WATER WINDOW DEPENDING JURISDICTION. LANDSCAPE ESTABLISHMENT WILL REQUIRE INCREASED IRRIGATION WATER FOR DURATION OF THE ESTABLISHMENT PERIOD AND MAY REQUIRE TWICE THE AMOUNT OF WATER AS ESTABLISHED PLANT MATERIAL. THE CONTRACTOR SHALL COORDINATE WATERING SCHEDULES AND APPLICATION RATES WITH THE OWNER'S REPRESENTATIVE PRIOR TO FINAL
- ACCEPTANCE. 20. THE DESIGN IS BASED ON THE FOLLOWING PROJECTED PEAK SEASON WEEKLY APPLICATION RATES AFTER ESTABLISHMENT. THESE FIGURES WILL NEED TO BE ADJUSTED DUE TO SEASONAL CHANGES AND VARIABLE WEATHER CONDITIONS.
- FESCUE/BLUEGRASS BLEND TURF 1.75" PER WEEK PEAK SEASON
- TREE, SHRUB, AND PERENNIAL PLANT MATERIAL 1.00" PER WEEK PEAK SEASON
- NATIVE DRAUGHT TOLERANT SEED MIX 0.75" PER WEEK PEAK SEASON
- 21. THE CONTRACTOR SHALL PROVIDE A SEASONAL MAINTENANCE SCHEDULE WHICH SHALL BEGIN ON APRIL 15TH AND END ON OCTOBER 15TH TO ENSURE THE EFFICIENCY AND LONGEVITY OF THE IRRIGATION SYSTEM. THE MAINTENANCE SCHEDULE SHALL INCLUDE BUT IS NOT LIMITED TO THE FOLLOWING LIST OF BEST MANAGEMENT PRACTICES:
- CHECK HEADS FOR COVERAGE AND LEAKAGE.
- CHECK CONTROLLER PROGRAMMING AND ADJUST FOR SEASONAL CHANGES AS NECESSARY.
- VERIFY THAT THE WATER SUPPLY AND PRESSURE ARE AS STATED IN THE DESIGN.
- CERTIFY THE BACKFLOW PREVENTION DEVICE AND SUBMIT TEST RESULTS TO THE PROPERTY MANAGER.
- PERIODICALLY VERIFY THE THE SENSORS IN THE IRRIGATION SYSTEM ARE OPERATING CORRECTLY. WINTERIZATION AND SPRING START UP PROCEDURES.

		DEGOINI HON			11 / 11 11	
M	IRRIGATION METER	TBD" DEDICATED IRRIGATION ME REFER TO CIVIL, UTILITY, AND WA			NA	NA
C	IRRIGATION CONTROLLER	TBD MODEL	BD MODEL 20VAC POWER REQUIRED - SEE PLANS FOR LOCATION(S)			TBC
€\$	RAIN SENSOR	HUNTER WSS-SEN OR SOLAR-SY	NC-SEN REFER TO C	ONTROLLER NOTES	TBD	TBC
	BACKFLOW	EBCO TBD" 825YA			TBD	TBD
NOT	PREVENTER SECURITY ENCLOSURE		SEE ENCLOSURE SPECIFICATIONS BELOW GUARD SHACK GS-TBD LIFT OFF ENCLOSURE			TBC
SHOWN		WITH FROSTGUARD BLANKET, POMATCO-NORCA 3/4" 201X	OWDER COATED FOR	EST GREEN	TBD	
◎	MANUAL DRAIN VALVE	INSTALLED IN AEP 910L-1G2G VAL	LVE BOX		TBD	TBD
0	QUICK COUPLER	RAIN BIRD 44LRC INSTALLED IN AEP 910L-1G2G VAL	VE BOX		TBD	TBD
₩	MASTER VALVE	HUNTER IBV-TBD SERIES INSTALLED IN AEP 1015-1G2G VAL	_VE BOX		TBD	TBD
FS	FLOW SENSOR	FLOWMEC QS-200-XX WITH COMMUNICATION CABLE BA DECODER, INSTALLED IN AEP 10	ACK TO CONTROLLER	R OR ICD-SEN SENSOR	TBD	TBE
H	ISOLATION GATE VALVE	MATCO-NORCA 514TX (2.5" AND S	SMALLER)	E ROY	TBD	TBI
•	TURF VALVE ASSEMBLY	HUNTER ICV-G SERIES WITH SCH 40 BALL VALVE, AND IC 1015-1G2G VALVE BOX, SIZED PEI	CD-100 / EZ-1 DECODE		TBD	TBI
0	DRIP VALVE ASSEMBLY	HUNTER ICZ-101-LF WITH SCH 40 BALL VALVE, AND IC 1320-1G2G VALVE BOX, SIZED PEI	CD-100 / EZ-1 DECODE	ER INSTALLED IN AEP	TBD	TBI
\$	GROUNDING / LINE SURGE SUPRESSION	COPPER-CLAD GROUNDING ROD WITH WATERPROOF WIRE CONNI DECODER, INSTALLED IN AEP 910	ECTORS AND ICD-100	SURGE ARRESTING	TBD	ТВІ
MP1000	TURF ROTARY	HUNTER PROS-06-PRS40-CV WITH NOZZLE PER PLAN	H HUNTER MP SERIES	S NOZZLE	TBD	ТВІ
STRIP (2) (4) (5) (8) (9) (9) (9) (9) (9) (9) (9) (9) (9) (9	TURF ROTARY (SPECIALTY)	HUNTER PROS-06-PRS40-CV WITH NOZZLE PER PLAN	HUNTER MP SERIES	S NOZZLE	TBD	ТВІ
0 0 0 0 0 0 0 0 0 0 0 0	TURF SPRAY (FIXED)	HUNTER PROS-06-PRS30-CV WITH PRO-SPRAY FIXED SERIES NOZZLE NOZZLE PER PLAN			TBD	TBI
8 (0) (2) (5)	TURF SPRAY (ADJUSTABLE)	HUNTER PROS-06-PRS30-CV W/ PRO ADJUSTABLE SERIES NOZZLE NOZZLE PER PLAN			TBD	ТВІ
3 20 23 30 0 50 60 80 CORNER T	NATIVE ROTOR	HUNTER I-20-12 NOZZLE PER PLAN			TBD	TBI
1000 M L O 2000 K G R 3000 B Y A	NATIVE SEED ROTARY	HUNTER PROS-12-PRS40-CV WITH HUNTER MP SERIES NOZZLE NOZZLE PER PLAN			TBD	TBI
STRIP (2) (2) (3) (8) (9) (9) (9) (9) (9) (9) (9) (9) (9) (9	NATIVE SEED ROTARY (SPECIALTY)	HUNTER PROS-12-PRS40-CV WITH NOZZLE PER PLAN	HUNTER MP SERIES	S NOZZLE	TBD	TBI
B	TREES IN NATIVE	(2) HUNTER PROS-04-PRS30-CV V ASSEMBLIES PER TREE	VITH PCN-XX BUBBLE	ER OR RZWS-18-XX-CB	TBD	TBI
一	MAINLINE CAP	FUTURE CONNECTION SCH 40 PVC CAP AND 5-FT OF CO VALVE BOX	NTROL WIRE INSTAL	LED IN AEP 910L-1G2G	TBD	TBI
	SLEEVING	CLASS 200 PVC REFER TO SLEEVING NOTES			TBD	TBI
	SERVICE LINE	TYPE K COPPER SIZE: MATCH POC UNLESS OTHER	RWISE NOTED		TBD	TBI
	PVC	CLASS 200 PVC BE/RT			TBD	TBI
	MAINLINE PVC TURF	SIZE: TBD" UNLESS OTHERWISE I	NOTED			
	LATERAL	SIZE: 1" MINIMUM UNLESS OTHER	RWISE NOTED		TBD	TBI
	PVC TREE LATERAL	CLASS 200 PVC SIZE: 1" UNLESS OTHERWISE NO	ΓED		TBD	TBI
	DRIP	UV RESISTANT POLYETHYLENE			TBD	TBI
	LATERAL FLUSH END	SIZE: 3/4" MINIMUM UNLESS OTHE HOSE END FLUSH CAP & OPERAT			TBD	TBI
_ — •	CAP	INSTALLED IN AEP 910L-1G2G VAL		JEDI II E	IDU	ıDl
	ALVE CALLOUT - VALVE/STATION NUMBE	R PLANT TYPE	EMITTER SCH EMITTER	QTY.	TOTAL	CDU
//	ZONE DESIGNATION:	PERENNIAL / GRASSES	0.5 GPH	TWO EACH	1.0 G	
	T (TREES), S (SHRUBS),	DECIDUOUS SHRUBS	1.0 GPH	TWO EACH	2.0 0	
X'- X'	G (TURF), N (NATIVE), X (MISC)	EVERGREEN SHRUBS	1.0 GPH	TWO EACH	2.0 0	
X" XX		DECIDUOUS TREE	1.0 GPH	EIGHT EACH	8.0 0	
	~ VALVE FLOW: (GPM)	EVERGREEN TREE	1.0 GPH	EIGHT EACH	8.0 (
		TREES IN NATIVE	ROOT ZONE \	NATERING / TREE RING /	ASSEMBL	.Υ
	- VALVE SIZE		KUUT ZUNE !	MATERING / TREE KING /	へいひにIVIDL	. 1

IRRIGATION SCHEDULE

SYMBOL

DESCRIPTION

MODEL NO.

DESCRIPTION

4. RAIN BIRD DBC-025 DIFFUSER BUG CAP AND TS-025 STAKE ON ALL 1/4" DISTRIBUTION TUBING EMISSION POINTS 5. REFER TO DRIP IRRIGATION DETAILS X-X. SHEET LI-XXX

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CONTACT: MOLLY CHIANG

DATE: 06.17.22 - SITE PLAN 01 09.15.22 - SITE PLAN 02


SHEET TITLE: OVERALL IRRIGATION PLAN





WILLOUGHBY CORNER SITE PLAN - PHASE 1

LOTS 161, 164, 165, 166 & 167, & OUTLOTS F, I, J, K, L & N OF THE WILLOUGHBY CORNER SUBDIVISION, CITY OF LAFAYETTE, COUNTY OF BOULDER, STATE OF COLORADO

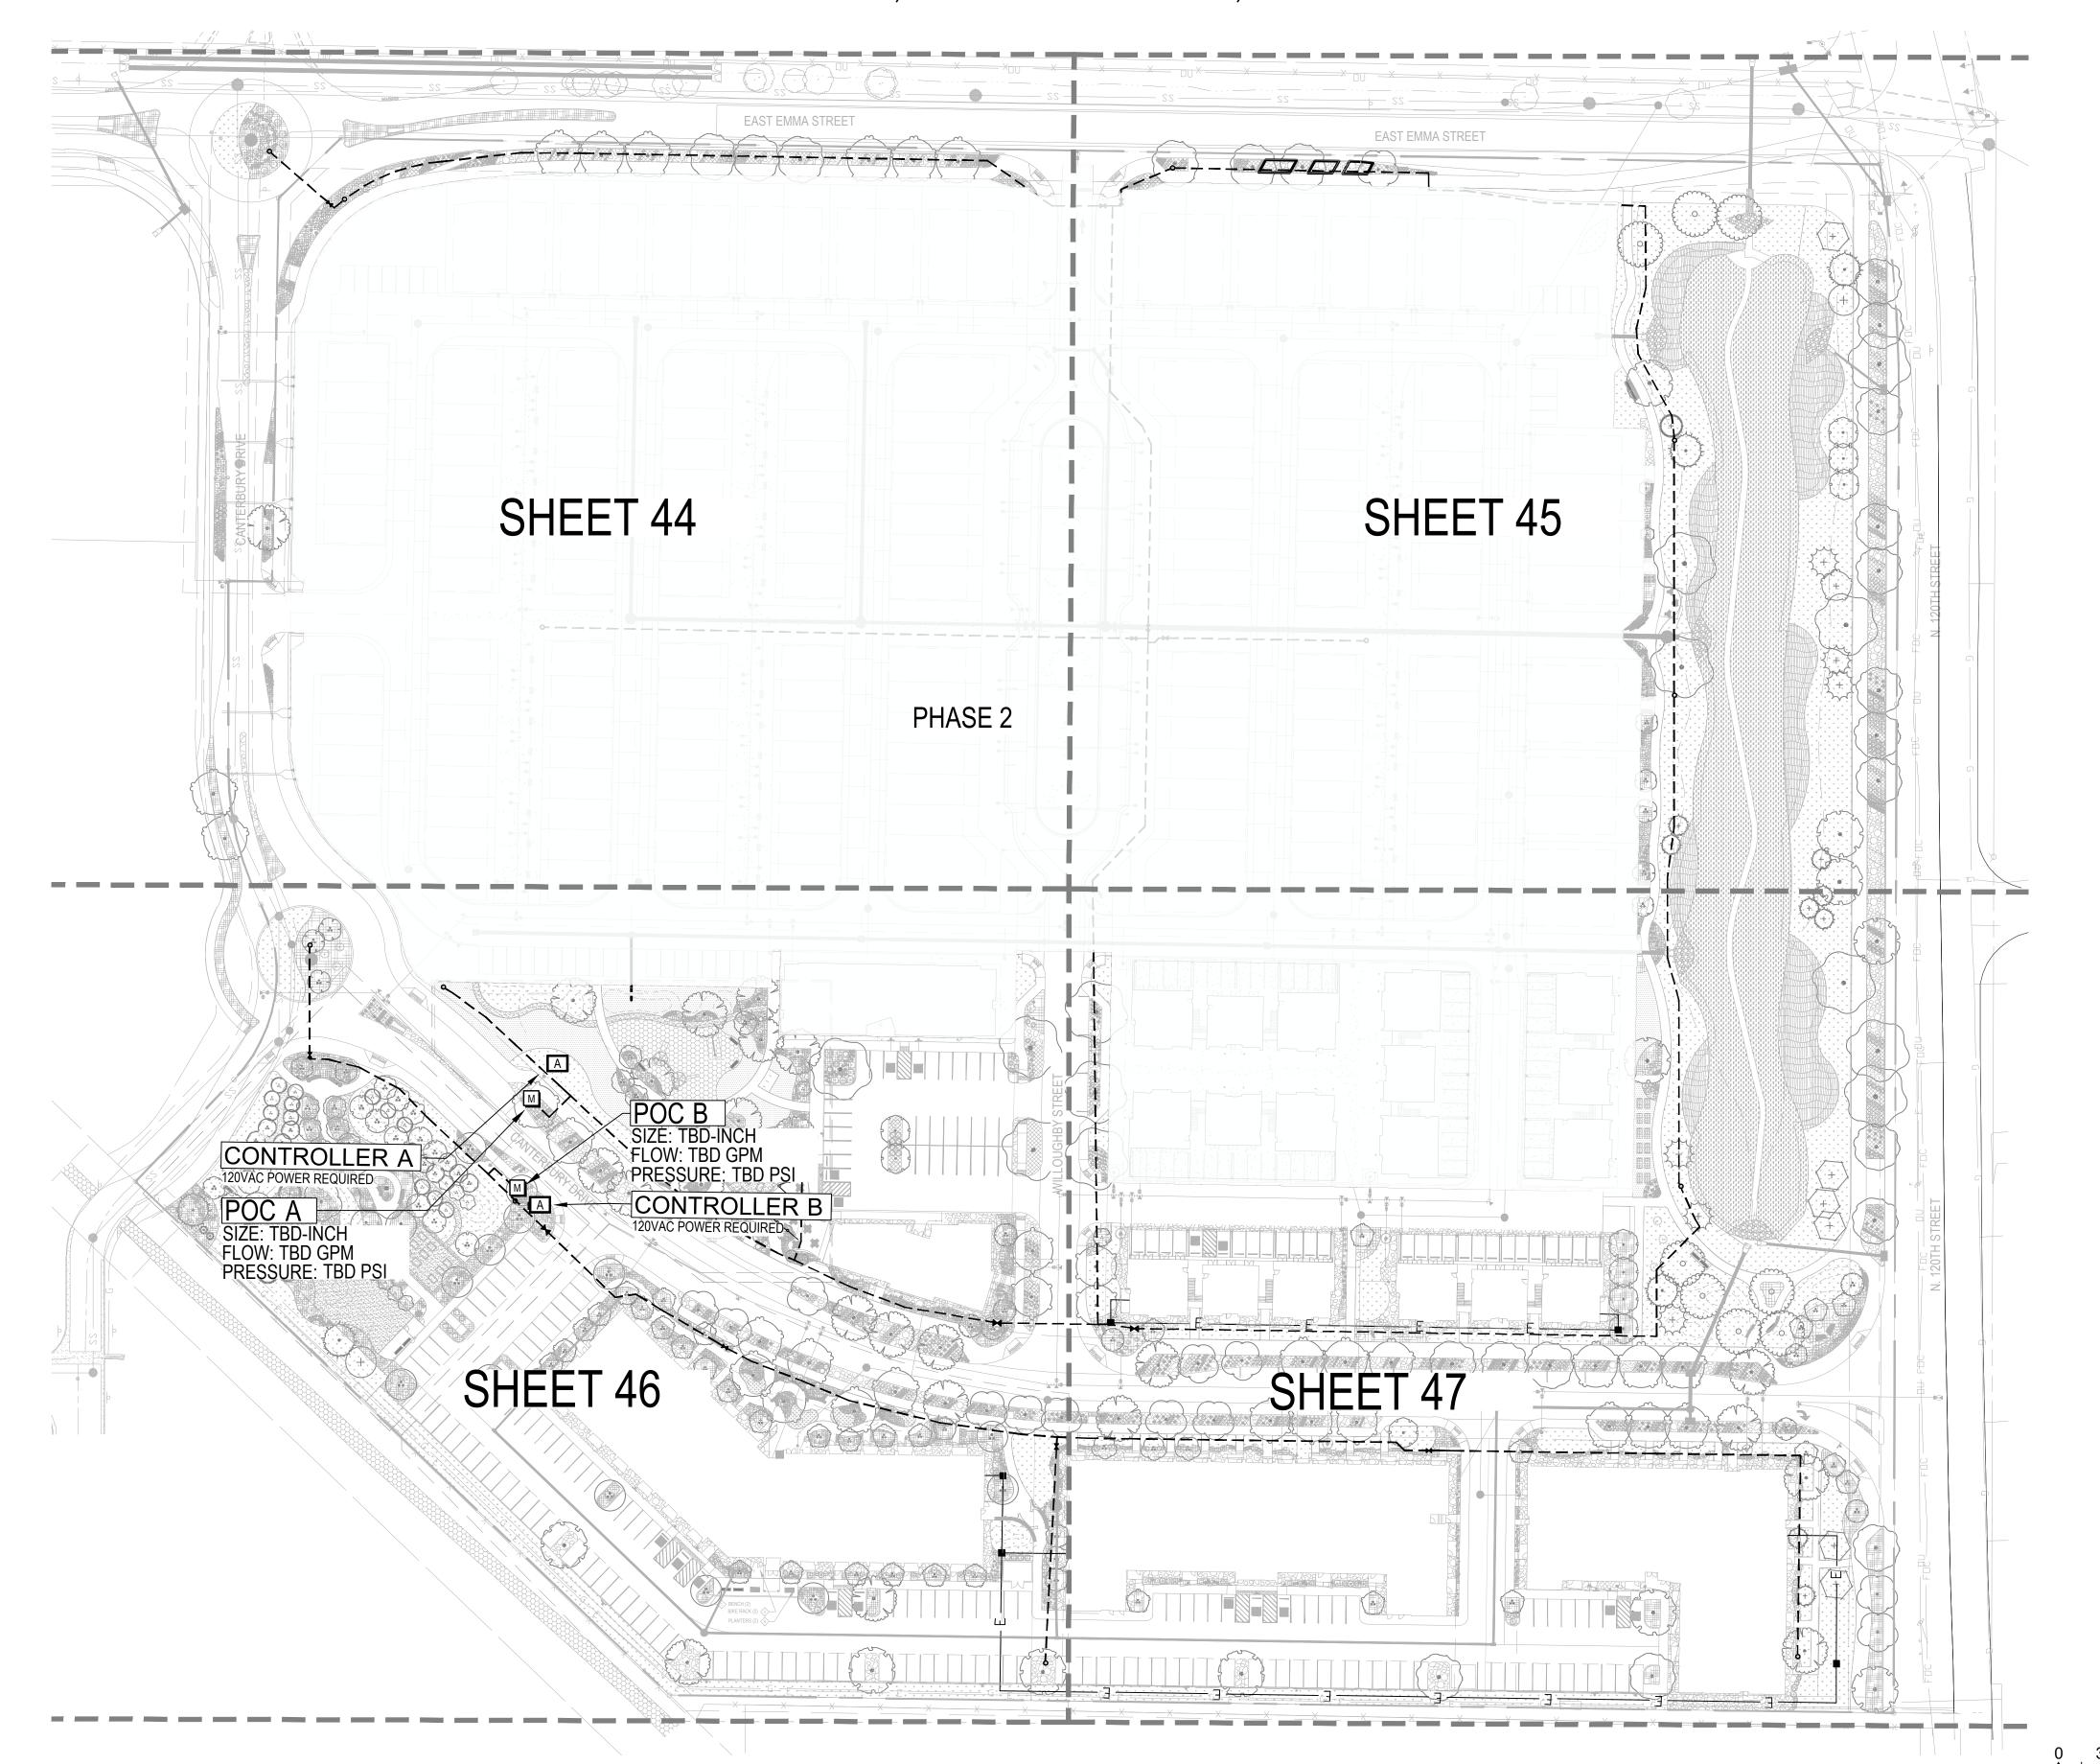

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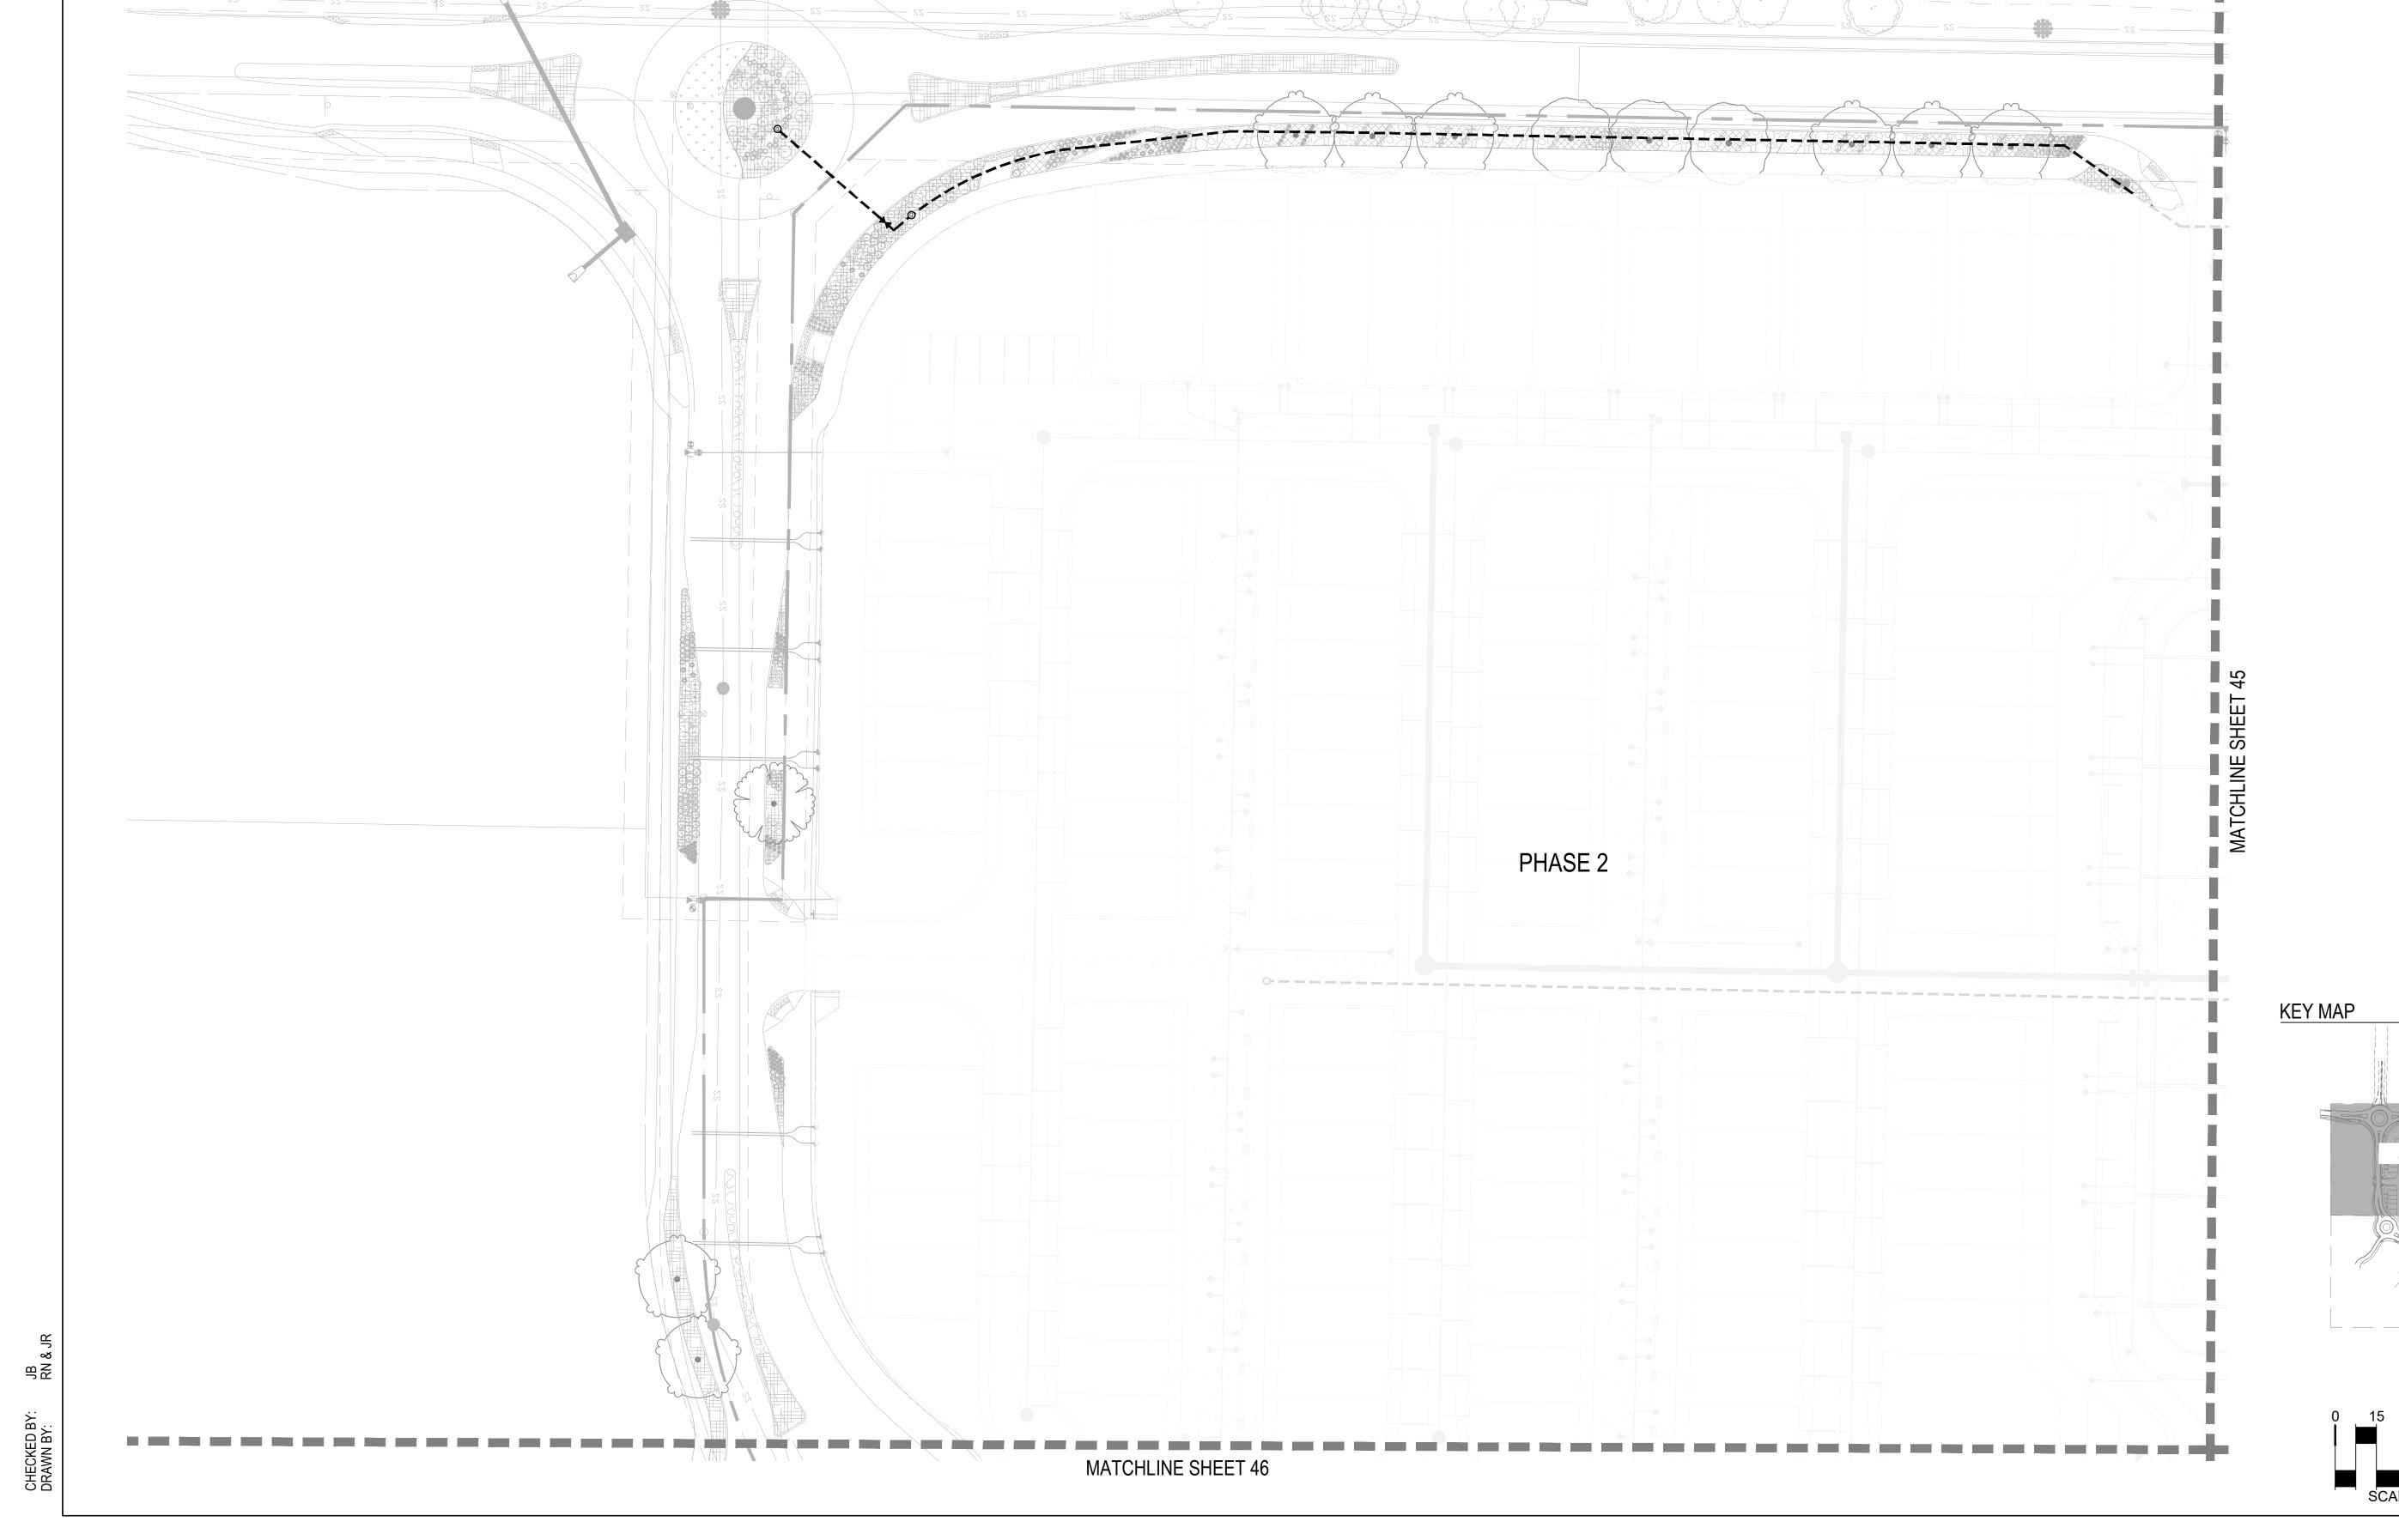
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BOULDER, CO - 80304
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CONTACT: MOLLY CHIANG

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SHEET TITLE:
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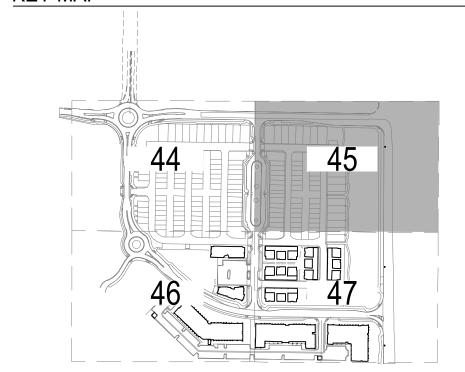
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SHEET TITLE:

KEY MAP



IRRIGATION PLAN

JB RN & CHECKED BY: DRAWN BY: PHASE 2

MATCHLINE SHEET 47

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3Y CORNER

VVILLOOGITO
SITE PLAN- PHASE 1
LAFAYETTE, COLORADO


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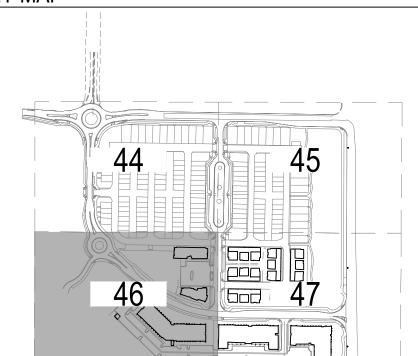
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PLAN


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MATCHLINE SHEET 44

KEY MAP





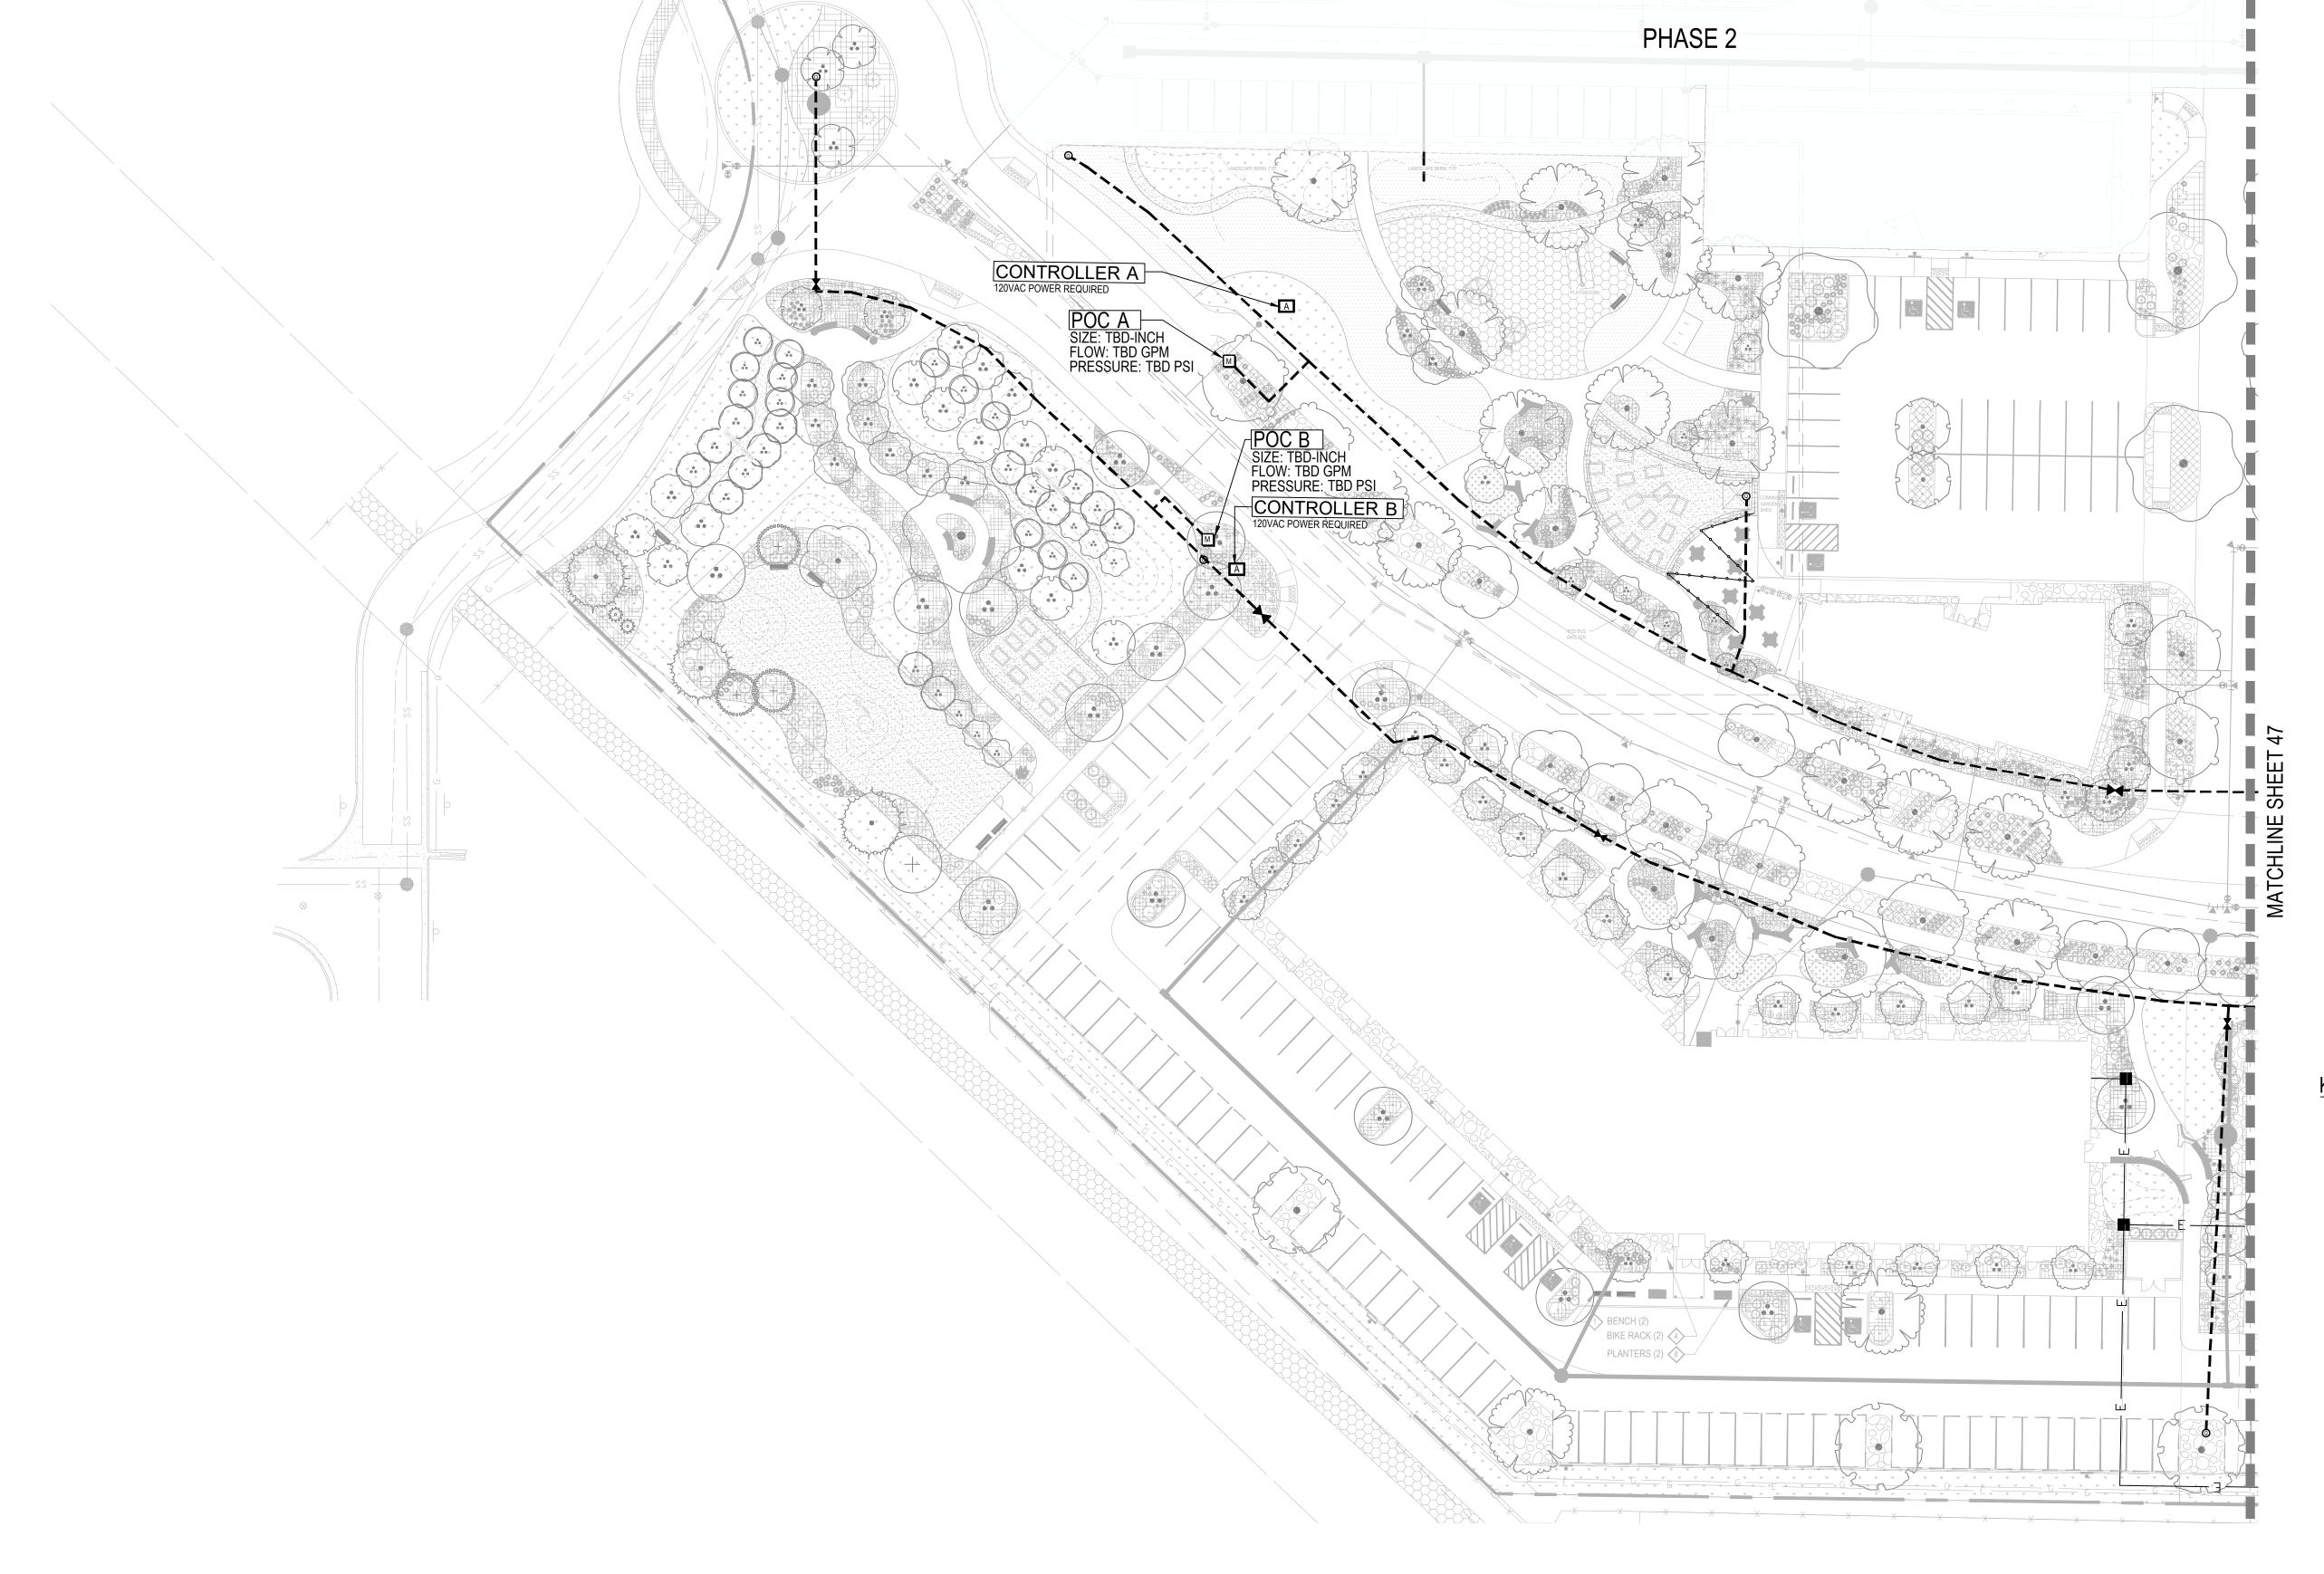

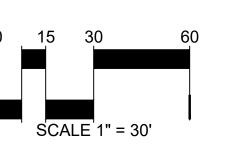

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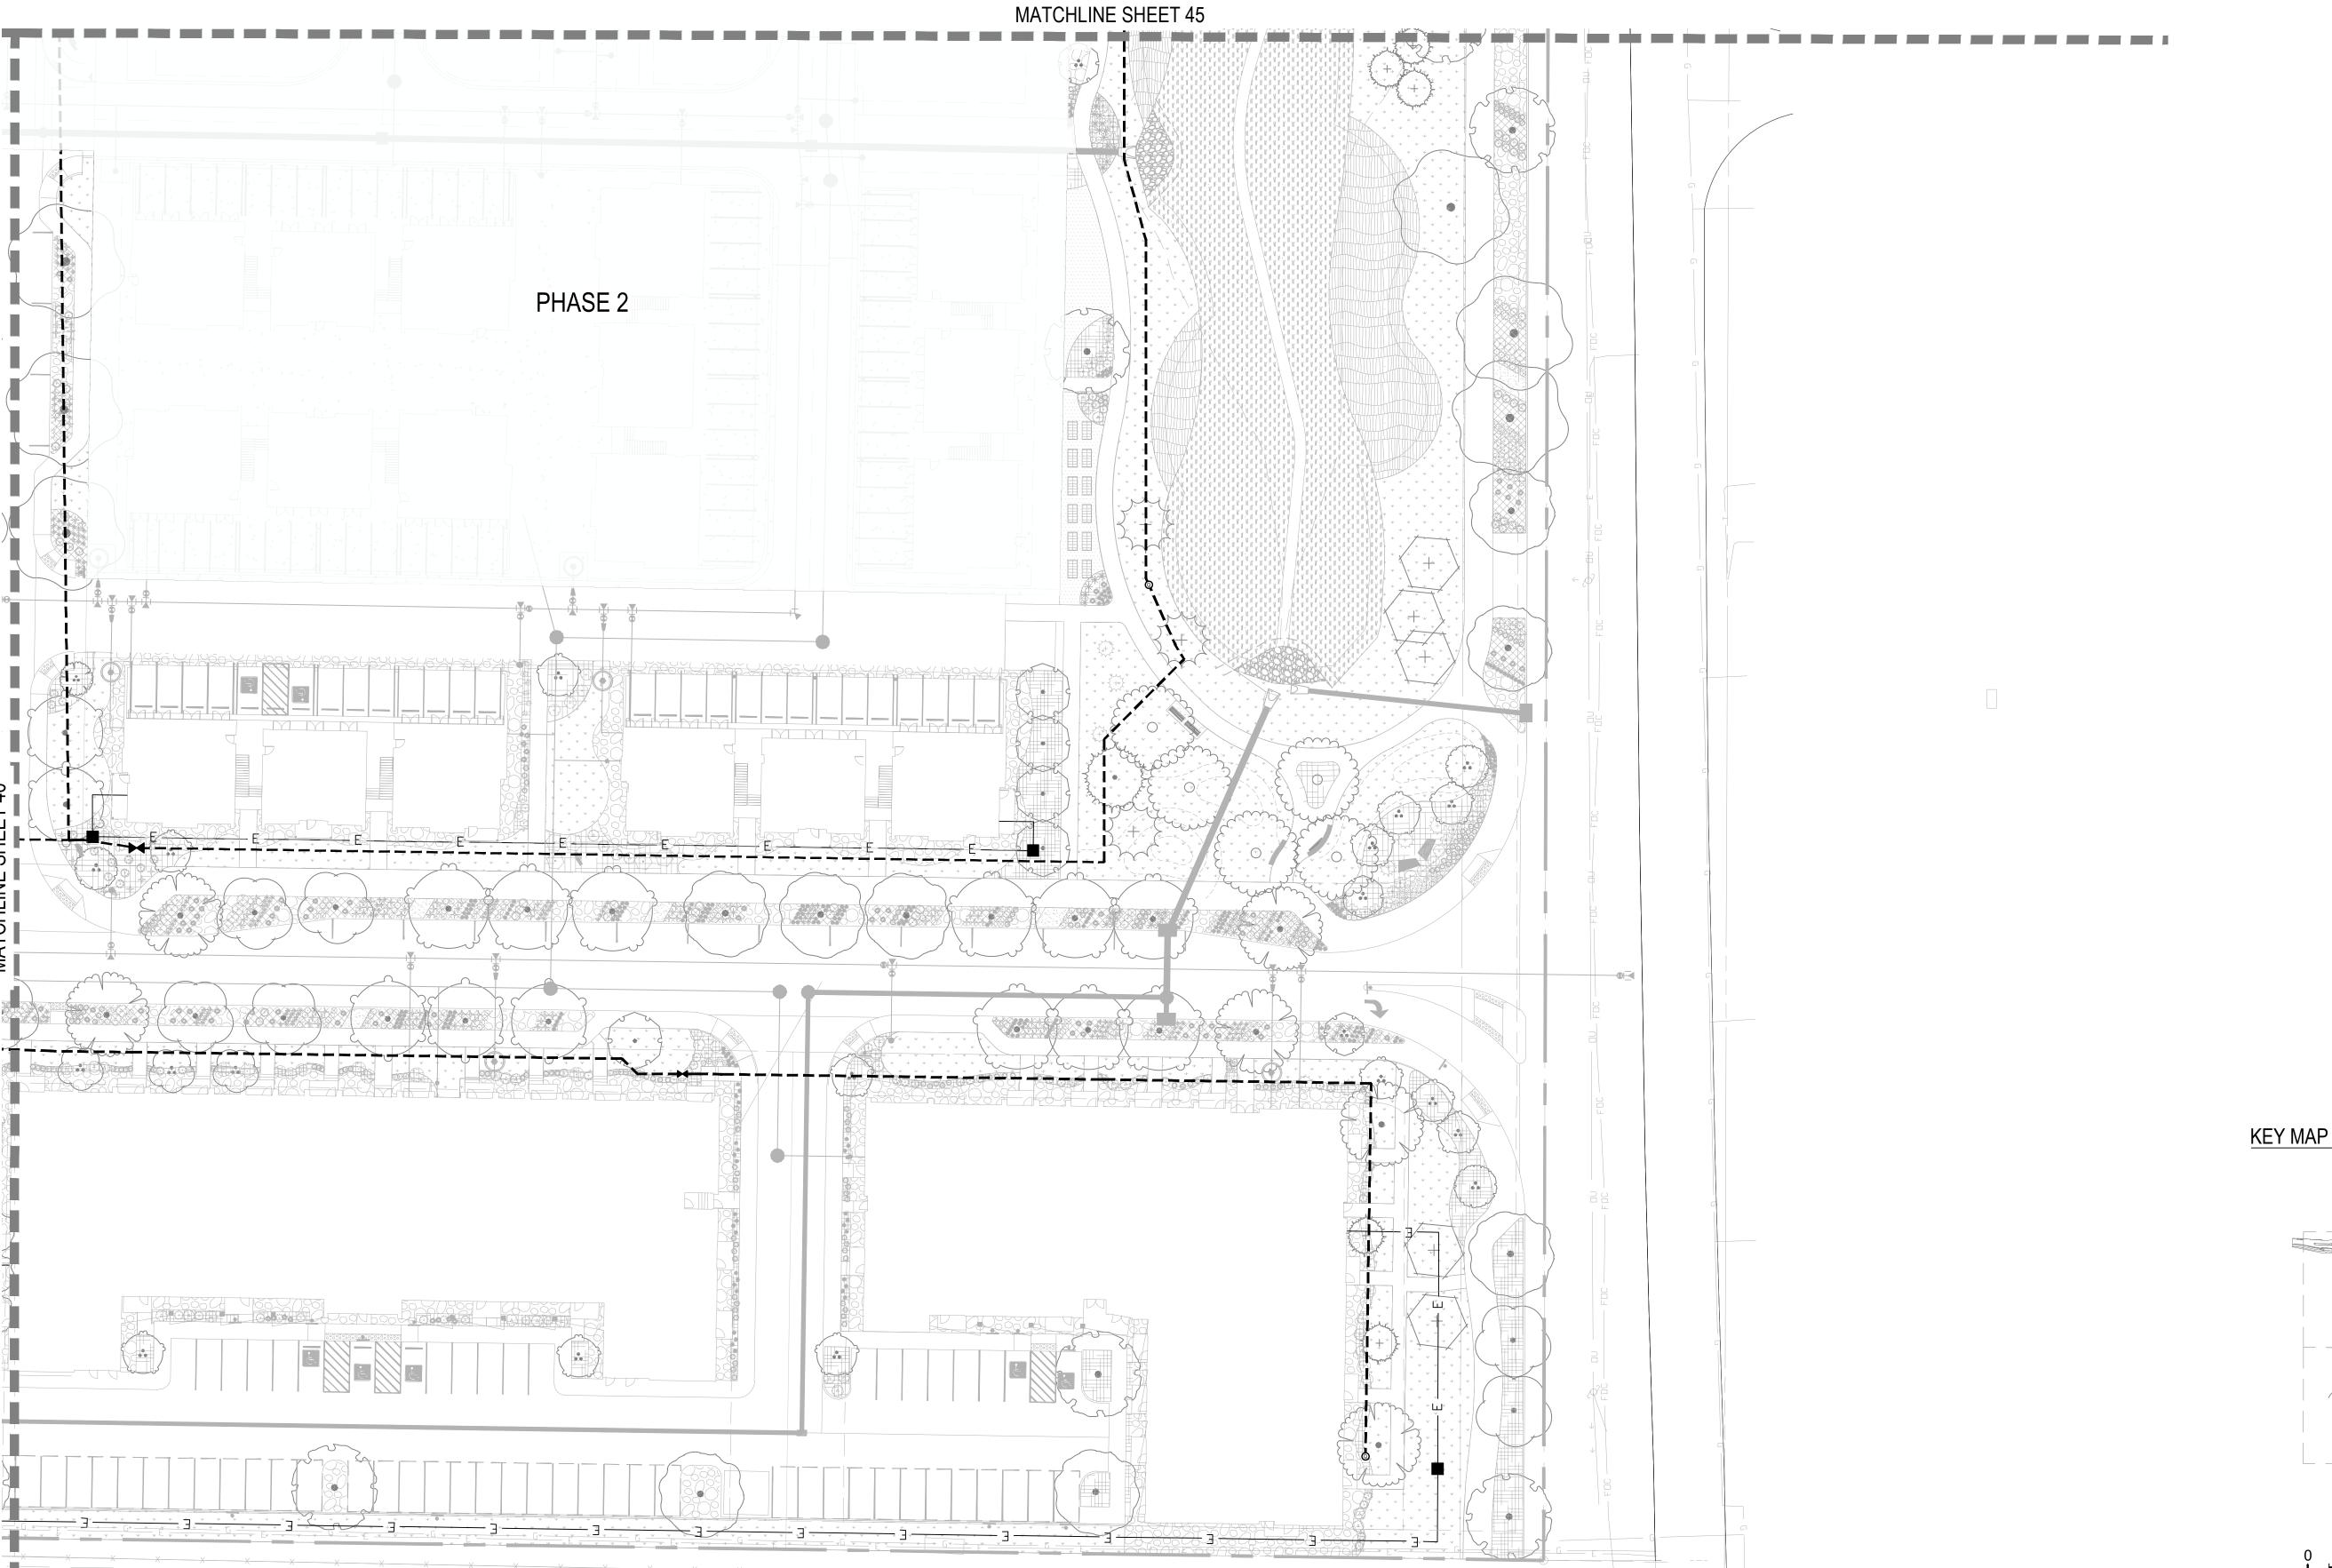
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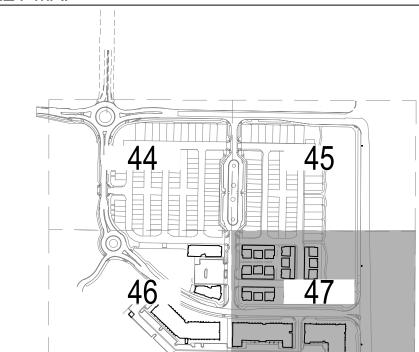
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(4) GATE VALVE W/ CROSS HANDLE AND SOLID WEDGE DISC PER

(5) 3/4" GRAVEL SUMP FILL IN AND AROUND BOX AS REQUIRED.

1 BACKFLOW ENCLOSURE

4 TYPE K COPPER PIPE

5 COMPACTED SUBGRADE

(6) PVC ADAPTOR 30" BEYOND UNIT

8 REDUCED PRESSURE BACKFLOW PREVENTER WITH BALL VALVES

(10) BRASS WYE STRAINER (100 MESH)

2 BALL VALVE

3 BRASS UNION

7 PVC MAINLINE

(9) BRASS RISER

(11) COPPER ADAPTER

1 PVC MAINLINE

(4) FINISH GRADE

(5) LOCKING VALVE BOX

6 SCH. 80 PVC NIPPLE

(8) WATERPROOF ELECTRICAL

(10) WIRES TO CONTROLLER

(11) BRICK SUPPORTS 2 MIN.

(13) COMPACTED SUBGRADE

(12) 3/4" GRAVEL SUMP - 8" DEPTH

(14) SCH. 80 PVC UNION (THREADED)

(1) LOCKING ROUND BOX & COVER

8" SCH 40 PVC ACCESS SLEEVE

LENGTH AS REQUIRED.

PER SCHEDULE. TOP OF BOX TO BE FLUSH WITH FINISH GRADE

SCALE: NTS

(THREADED)

CONNECTIONS

7 MASTER VALVE

9 DECODER

(2) SCH. 80 PVC MALE ADAPTER

(3) SCH. 80 PVC BALL VALVE

(12) FINISH GRADE

FLOW FROM

BEYOND EDGE OF BOX

(8) COMPACTED SUBGRADE

(7) PVC MAINLINE

6 3" DEPTH 3/4: GRAVEL EXTEND 6'

SCHEDULE

2 FINISH GRADE

IRRIGATION DETAILS

SHEET TITLE:

LOTS 161, 164, 165, 166 & 167, & OUTLOTS F, I, J, K, L & N OF THE WILLOUGHBY CORNER SUBDIVISION,

1) CONTROLLER MOUNT AT EYE-LEVEL PER MANUFACTURER'S

RECOMMENDATIONS (2) DISCONNECT SWITCH

(3) 120 POWER SOURCE IN STEEL CONDUIT

4 WIRELESS SENSOR RECEIVER

(5) BUILDING EXTERIOR WALL (6) RIGID STEEL CONDUIT W/

CONTROL WIRES TO VALVES (7) FINISH GRADE

(8) CONDUIT TO EXTEND 5 FT. BEYOND WALL

(9) UF DIRECT BURIAL WIRE TO CONTROL VALVES

(10) UF DIRECT BURIAL WIRE TO **GROUNDING PER ASIC GUIDELINES**

1 LIFT-OFF GUARDSHACK

3 CONCRETE PAD - PAD TO BE 9" LARGER ON ALL SIDES FROM

INTERIOR DIMENSIONS OF

GUARDSHACK ENCLOSURE

CONCRETE HOLE OPENING

DIMENSION PER CHART

ENCLOSURE

2 LOCK SHIELD

(4) FINISH GRADE

STANDARD LIFT-OFF

GUARDSHACK INTERNAL

DIMENSIONS

GS-.5 | 10"W x 18"H x 12"L

10"W x 24"H x 22"L

10"W x 24"H x 30"L

GS-1

1. INSTALL GUARDSHACK LIFT-OFF UNIT 51 POWDER COATED STEEL GUARD SHACK PER MANUFACTURER'S SPECIFICATIONS.

4. PROVIDE KEYED PADLOCK, MASTER LOCK MODEL #957 W/ (2) TWO KEYS FOR LOCKING SECURITY ENCLOSURE.

3. PRODUCT AVAILABLE FROM GUARDSHACK 3831 E. GROVE ST. PHOENIX, AZ 85040, PH: (602) 426-1002 EXT. 422 FX: (602) 426-1005

5 3/4" CRUSHED GRAVEL,

CONCRETE HOLE

OPENING

8"W x 21"L

8"W x 21"L

8"W x 29"L

1 WIRES TO CONTROLLER

WATERPROOF ELECTRICAL CONNECTIONS

(5) FLOW SENSOR PER SCHEDULE

2 LOCKING VALVE BOX

(4) SENSOR DECODER

6 DOWNSIZED MAINLINE

SCH. 80 PVC ECCENTRIC

COUPLING (S x S) - SIZE & QTY TO BE DETERMINED IN FIELD

9 SCH. 80 PVC NIPPLE (MPT x S)

(10) SCH. 80 PVC UNION (THREADED)

(12) SCH. 80 PVC MALE ADAPTER

(16) COMPACTED SUB-GRADE

SCALE: NTS

(13) TO EARTH GROUND, INSTALLED

(7) FINISH GRADE

(11) PVC MAINLINE

SCLAE: NTS

PROVIDE WATERPROOF SEALANT FOR ALL CONDUIT AND WIRE ACCESS POINTS

RAIN SENSOR SURFACE MOUNT

2. FINAL LOCATION AND MOUNTING SYSTEM TO BE DETERMINED BY OWNER. 3. SENSOR SHOULD NOT BE MOUNTED UNDER TREES, IN AREAS AFFECTED BY SPRINKLER SYSTEM OR UNDER EAVE OF HOUSE.

(3) SECURE MOUNTING BRACKET TO **EXTERIOR WALL WITH SCREWS** PER LOCAL CODES

GUTTER MOUNT. MOUNT IN

(2) WIRELESS RAIN SENSOR, LOCATE

TO RAINFALL

CONTROLLER.

WITHIN 500' OF THE

LOCATION WHERE SENSOR CAN

RECEIVE FULL SUN AND IS OPEN

INSTALL PER LOCAL CODES AND MANUFACTURER'S SPECIFICATIONS.

2. PROVIDE PVC PIPE PROTECTION AROUND COPPER SUPPLY LINES AS THEY GO THROUGH THE 3. BACKFLOW PREVENTION DEVICES SHALL BE PLACED A MINIMUM OF TWO (2') FEET FROM THE

WATER METER AND BE THE SAME SIZE AS THE METER SERVICE LINE. 4. PROVIDE THRUST BLOCKS FOR LINES 2-1/2" OR LARGER.

(12) (13)

1. INSTALL MASTER VALVE AND DECODER PER MANUFACTURER'S SPECIFICATIONS FOR WIRING

1. COMPACT SOIL AROUND GATE VALVE ASSEMBLY TO THE SAME DENSITY AS ADJACENT

2. DO NOT REST VALVE BOX OR ACCESS SLEEVES ON MAINLINE OR LATERAL LINE.

BACKFLOW FEBCO 825YA

FLOW TO VALVES

4 5 6 7 8

2 2" VALVE MARKER (3) 2" CL160 PVC ACCESS SLEEVE LENGTH AS REQUIRED.

10" LOCKING ROUND BOX & COVER PER

FINISH GRADE.

SCHEDULE. TOP OF

BOX TO BE FLUSH WITH

(4) 3" DEPTH 3/4" CRUSHED GRAVEL

5 PVC PRESSURE MAIN LINE

6) SCH. 80 TEE PER MAINLINE SIZE. ALIGN IN A DOWNWARD POSITION

7 SCH. 80 PVC NIPPLE

8 FINISH GRADE 9 1" BRONZE STOP VALVE WITH

SLOTTED KEY OPERATOR 10 SCH. 80 PVC ELL

11) SCH. 80 PVC NIPPLE

(12) 3/4" GRAVEL SUMP - 1 CU. FT. MIN

(2) 10" ROUND BOX & COVER PER

SCHEDULE. TOP OF BOX TO

FLUSH WITH FINISH GRADE

(3) QUICK COUPLING VALVE W/

LOCKING COVER PER

(4) SCH. 80 PVC RISER (T x T)

 \bigcirc 3" DEPTH $\frac{3}{4}$ " GRAVEL BASE

EXTEND 6" BEYOND EDGE OF

(8) 24" LONG #4 REBAR TO HOLD

QUICK COUPLER IN PLACE W/

(2) STAINLESS STEEL CLAMPS

SCALE: NTS

2. LOCATE DRAIN VALVE AT POINT OF CONNECTION AND AT ALL LOW POINT(S) ALONG THE (13) SOIL BLANKET ENCLOSING SUMP AMOCO ENG. FABRIC 4545 - 4.5 OZ. OR EQUAL

1 FINISH GRADE

SCHEDULE

(6) PVC SWING JOINT

7 PVC MAINLINE

MANUAL DRAIN VALVE

IRRIGATION MAINLINE AS NEEDED.

ALL THREADED CONNECTIONS SHALL BE COATED WITH TEFLON TAPE.

EACH QUICK COUPLER SHALL BE IN A SEPARATE VALVE BOX PROVIDE (1) QUICK COUPLER KEY FOR EACH QUICK COUPLER VALVE. QUICK COUPLER SHALL HAVE YELLOW LOCKING RUBBER COVER.

AS ADJACENT UNDISTURBED SUB-GRADE.

COMPACT SOIL AROUND GATE VALVE ASSEMBLY TO THE SAME DENSITY

5. ALL THREADED CONNECTIONS SHALL BE COATED WITH TEFLON TAPE.

QUICK COUPLER

GATE VALVE 3" AND SMALLER

3. PROVIDE GATE VALVE KEY - LENGTH AS REQUIRED.

SCALE: NTS

MASTER VALVE

SCALE: NTS

MINIMUM UPSTREAM MINIMUM DOWNSTREAM DISTANCE 10x DISTANCE 5x FLOW METER SIZE FLOW METER SIZE OF CLEAN STRAIGHT PIPE OF CLEAN STRAIGHT PIPE

2. ALL BOLTS FOR MOUNTING BRACKETS SHALL BE ZINC PLATED TAMPER PROOF

VARIES

. ALL ELECTRICAL AND CONTROLLER WIRE TO BE INSTALLED PER LOCAL CODE AND

2. GROUND CONTROLLER PER LOCAL CODE AND MANUFACTURER'S SPECIFICATIONS.

3. PROVIDE WATERPROOF SEALANT FOR ALL CONDUIT AND WIRE ACCESS POINTS.

CONTROLLER WALL MOUNT EXTERIOR

PLANVIEW

BACKFLOW ENCLOSURE LIFT-OFF

MANUFACTURER'S SPECIFICATIONS.

4. PROVIDE LOCK FOR ENCLOSURE.

PER ASIC GUIDELINES (14) 3/4" GRAVEL SUMP 8" DEPTH 1. INSTALL FLOW SENSOR AND SENSOR DECODER PER MANUFACTURER'S SPECIFICATIONS FOR WIRING AND GROUNDING. (15) BRICK SUPPORTS 2 MIN. FLOW SENSOR DECODER

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CITY OF LAFAYETTE, COUNTY OF BOULDER, STATE OF COLORADO

SECTION

2. ALL PVC PIPING TO BE SNAKED IN TRENCHES AS SHOWN IN PLAN VIEW ABOVE.

4. ALL ELECTRICAL WIRE CONNECTIONS TO VALVES AND SPLICES TO BE INSTALLED WITHIN A

7. BEDDING MATERIAL SHALL BE 1/4" MINUS SAND, AND SHALL BE 3" BELOW LOWEST PIPE OR

10. EXCAVATED COVER MATERIAL SHALL BE FREE FROM DEBRIS AND ROCKS 1/2" OR GREATER

11. PIPE BEDDING MATERIAL TO BE ROCK AND DEBRIS FREE, BACKFILL IN 6" LIFTS, PUDDLE WITH

Drip valve to pvc connection

Refer to legend for type of

connection required

VALVE BOX AND MADE WITH DBY WATERPROOF CONNECTORS. OR APPROVED EQUAL

5. VALVE WIRES TO BE INSTALLED WITHIN MAINLINE TRENCH WHEREVER POSSIBLE

FLOW

1. AFTER FLUSHING HEADS, REGRADE AND COMPACT AS NEEDED TO RETURN TO FINISH GRADE.

5. COMPACT SOIL AROUND HEAD TO THE SAME DENSITY AS ADJACENT UNDISTURBED SUBGRADE.

3. ADJUST ALL SPRINKLERS HEADS SO THAT NO OVERSPRAY OCCURS ON ANY WALLS, WALKS, COURTS, ETC.

2. SPRINKLERS HEAD SHALL BE LEVEL WITH SURROUNDING FINISHED GRADE.

4. ALL THREADED CONNECTIONS SHALL BE COATED WITH TEFLON TAPE.

2 INCH POP-UP SPRAY

BUNDLE & TAPE WIRE EVERY 10 FT. SEAL

WIRE ENDS w/ WATERPROOF SPLICING

COILED AND PLACED IN BOX AT WATER

DRIP CONTROL ZONE KIT

6" MIN. OR PER

LOCAL CODE

INSTALL DECODERS PER MANUFACTURER'S

2. 30" MINIMUM LENGTH OF CONTROL WIRE

PROOF CONNECTION TO SOLENOID

SPECIFICATIONS FOR WIRING AND

MATERIAL

GROUNDING.

3. ALL 120 VOLT WIRING IN CONDUIT TO BE INSTALLED AS PER LOCAL CODES.

WIRE AND 3" ABOVE HIGHEST PIPE OR WEIR WITHIN TRENCH.

BEDDING IS NOT REQUIRED IN POLYETHYLENE TUBING TRENCHES.

BEDDING MATERIAL SHALL BE IN MAINLINE TRENCH ONLY.

5. BUNDLE AND TAPE WIRING AT 10' INTERVALS

WATER, BETWEEN LIFTS.

PIPE TRENCH

I. ALL MAINLINES TO BE INSTALLED IN ACCORDANCE WITH MANUFACTURER' SPECIFICATIONS. (6) IRRIGATION LATERAL PIPE

Drip valve to poly connection

Refer to legend for type of connection required

LPVC TO POLY

FITTING

PIPE IN TRENCH

(SEE NOTES)

RECLAIMED)

(3) FINISH GRADE

(2) EXCAVATED COVER MATERIAL

(4) MAINLINE MARKING TAPE

(PURPLE MARKING TAPE IF

POLYEHTELENE DRIP LATERAL

DRIP PVC LATERAL PIPE (6" MIN.

COVERAGE, 18" MIN. COVERAGE

BELOW PEDESTRIAN WALKS.)

(9) BEDDING MATERIAL (SEE NOTES)

(8) ① WATERPROOF CONNECTORS

9 2 30" COIL OF WIRE MINIMUM

4) PVC COUPLING (FPTxFPT)

6 BRICK SUPPORT (4 MIN)

(7) 4" DEPTH GRAVEL SUMP

(8) VALVE BOX PER LEGEND,

① SCH. 80 PVC BALL VALVE

(11) CONTROL AND COMMON

2 12" POP-UP SPRAY HEAD PER SCHEDULE

3 PVC LATERAL PIPE PER

4 SWING JOINT ASSEMBLY

5 PVC SCH. 40 TEE OR ELL, (S x T)

6 WALLS, WALKS, COURTS, CURB,

12 SCH. 80 TEE (SxSxT)

13 PVC MAINLINE

1) FINISH GRADE

SCHEDULE

FLUSH TOP OF BOX W/ GRADE

(9) CONTROL VALVE PER LEGEND

WIRES FROM CONTROLLER

SCALE: NTS

PLACED IN BOX

(10) (3) (2) SCH. 80 PVC UNION

(THREADED)

5 PVC LATERAL

SCALE: NTS

(7) IRRIGATION MAINLINE PIPE

8 VALVE WIRING

4

SHORTER AND AT THE END OF EACH WIRE RUN.

THE TWO-WIRE PATHS, WHEN POSSIBLE

SPECIFICATIONS FOR INSTALLATION.

4. INSTALL GROUNDING PER ASIC'S GUIDELINES.

LINE SURGE PROTECTION

6" MIN. OR PER

LOCAL CODE

SET TOP OF HEAD FLUSH WITH FINISH GRADE.

18" MIN.

24" MAX.

ROTOR POP-UP

POP-UP BUBBLER

INSTALL A LINE SURGE PROTECTOR EVERY 8th DECODER OR EVERY 500 FT. WHICHEVER IS

INSTALL THE GROUNDING WIRE AND EACH GROUNDING HARDWARE AT RIGHT ANGLES FRO

EACH GROUND SYSTEM SHALL MAINTAIN A MAXIMUM GROUND RESISTANCE OF 10 OHMS OR

ADJUSTABLE ARC NOZZLES SHALL BE USED ON CURVED OR NON-STANDARD ANGLED EDGES

3. ROTORS SHALL BE INSTALLED 6" MININUM FROM ANY WALLS, WALKS, COURTS, ETC. PER LOCAL

. AFTER FLUSHING HEADS, REGRADE AND COMPACT AS NEEDED TO RETURN TO FINISH GRADE

SPRINKLERS SHALL BE MIN. 6" FROM ANY WALLS, WALKS, COURTS, AND 24" FROM ROOT BALL

5. COMPACT SOIL AROUND HEAD TO THE SAME DENSITY AS ADJACENT UNDISTURBED SUB-GRADE.

3. ADJUST ALL SPRINKLERS BODIES SO THAT NO FLODDING OCCURS ON ANY WALLS, WALKS,

4. ALL THREADED CONNECTIONS SHALL BE COATED WITH TEFLON TAPE.

4. ADJUST ALL ROTOR HEADS SO THAT NO OVERSPRAY OCCURS ON ANY WALLS, WALKS,

5. ALL THREADED CONNECTIONS SHALL BE COATED WITH TEFLON TAPE.

LESS. REFER TO TWO-WIRE COMPONENTS MANUFACTURER'S RECOMMENDATIONS AND

1 PAVING

18" MIN. DEPTH

24" MIN. DEPTH

FOR MAINLINE

1. ALL SLEEVES SHALL BE INSPECTED PRIOR TO BACKFILLING

4. IRRIGATION PIPE AND WIRE SHALL NOT SHARE THE SAME SLEEVE.

5. MARK / STAMP - 'X' AND/OR INSTALL PLACARD AT BACK OF CURB.

3. MULTIPLE SLEEVES REQUIRE 4" HORIZONTAL SEPARATION WITHIN SAME SLEEVE TRENCH.

8 9 1011

1. BUNDLE & TAPE WIRE EVERY 10 FT. SEAL WIRE ENDS WITH WATERPROOF SPLICING

2. 30" MINIMUM LENGTH OF CONTROL WIRE, COILED AND PLACED IN BOX AT WATERPROOF

3. INSTALL DECODER PER MANUFACTURE'S SPECIFICATIONS FOR WIRING AND GROUNDING

AFTER FLUSHING HEADS, REGRADE AND COMPACT AS NEEDED TO RETURN TO FINISH GRADE

SPRINKLERS SHALL BE MIN. 6" FROM ANY WALLS, WALKS, COURTS, AND 12" FROM TURF EDGE

5. COMPACT SOIL AROUND HEAD TO THE SAME DENSITY AS ADJACENT UNDISTURBED SUBGRADE.

3. ADJUST ALL SPRINKLERS HEADS SO THAT NO OVERSPRAY OCCURS ON ANY WALLS, WALKS,

4. ALL THREADED CONNECTIONS SHALL BE COATED WITH TEFLON TAPE.

SPRAY POP-UP

CHECKED BY:

2. CAP SLEEVES UNTIL USE

PIPE SLEEVE

CONNECTION TO SOLENOID.

CONTROL VALVE DECODER

6" MIN. OR PER

LOCAL CODE

② WRAP 12 GAUGE GALVANIZED

LOCATING DEVICE

UNDISTURBED SOIL

CONDITIONS

(3) FINISH GRADE / TOP OF DG

(4) COMPACT SOIL AROUND SLEEVE

WASHED AND GRADED MORTAR

(6) PVC SLEEVE PER SCHEDULE,

7) EXTEND SLEEVES 6" BEYOND

THE PIPES/ WIRES

EDGES OF PAVING

1)PVC MAINLINE

(3) CONTROL WIRE

VALVE(S)

(2) BRICK SUPPORT (4 MIN.)

(4) COMMON WIRE TO NEXT

(5) PVC LATERAL W/ MALE ADAPTER

(6) SCH. 80 PVC UNION (THREADED)

7 WATERPROOF CONNECTORS

(4) SCH. 80 PVC NIPPLE/ RISER (LENGTH & SIZE VARY)

15) 3/4" GRAVEL SUMP - 4" DEPTH

SCALE: NTS

SCALE: NTS

(11) SCH. 80 PVC BALL VALVE

12 LOCKING VALVE BOX

13 FINISH GRADE

14)PVC ELBOW (TxT)

16)PVC TEE (SxSxT)

2 POP-UP SPRAY HEAD PER

4 SWING JOINT ASSEMBLY

5 PVC SCH. 40 TEE OR ELL, (S x T)

6 WALLS, WALKS, COURTS, CURB,

1 FINISH GRADE

SCHEDULE

3 PVC LATERAL PIPE

8 TWO-WIRE DECODER

9 CONTROL VALVE

SAND BACKFILL IN ROCKY SOIL

TWICE DIAMETER OF THE SUM OF

SCALE: NTS

O SAME DENSITY AS ADJACENT

WIRE AROUND EACH END OF

SLEEVE (10 WRAPS MIN.) AND EXTEND TO SURFACE AS A

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CONTACT: MOLLY CHIANG

09.15.22 - SITE PLAN 02

1) VALVE BOX WITH COVER PER

(3) WIRE FROM LINE SURGE

PROTECTOR TO GROUNDING

ROD BRASS CLAMPS (1 OF 2)

(4) GROUNDING ROD: 10 OHMS OR

5 3 INCH MINIMUM DEPTH OF 3

INCH WASHED GRAVEL

(6) LINE SURGE ARRESTOR:

(9) BRICK (2 MINIMUM)

CONTROLLER

(2) ROTOR - SIZE PER PLAN

(4) SWING JOINT ASSEMBLY

5 PVC SCH. 40 TEE OR ELL (S x T)

(6) WALLS, WALKS, COURTS, CURB,

3 PVC LATERAL PIPE

10 TWO-WIRE

1) FINISH GRADE

BUILT-IT ON DECODERS

(7) WATERPROOF CONNECTORS

(8) WIRE FROM DECODER TO WIRE

CABLE/COMMUNICATION WIRE

DECODER, SENSOR DECODER,

LINE SURGE PROTECTOR OR

SCALE: NTS

TO NEXT DEVICE (FIELD

LEGEND

(2) FINISH GRADE

7 FULL CIRCLE BUBBLER (MODEL PER LEGEND)

1 FINISH GRADE

6 TREE ROOT BALL

5 PVC SCH. 40 TEE OR ELL, (S x T)

SCALE: NTS

(4) SWING JOINT ASSEMBLY

3 PVC LATERAL PIPE

2 POP-UP SPRAY HEAD PER SCHEDULE

DATE:

06.17.22 - SITE PLAN 01

SHEET TITLE: **IRRIGATION**

DETAILS

SCALE: NTS

SCALE: NTS

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LOCKING ROUND BOX & COVER PER SCHEDULE. TOP OF BOX TO

(2) HOSE END SELF FLUSH CAP

5 POLYETHYLENE LATERAL

(6) ELBOW COMPRESSION FITTING

SCALE: NTS

7) 3/4" GRAVEL SUMP- 4" DEPTH

8 BRICK (2 REQUIRED MIN.)

(3) FINISH GRADE

BE FLUSH WITH FINISH GRADE

4 24" #4 REBAR TO HOLD END CAP IN PLACE W/ (2) STAINLESS STEEL

ORNER

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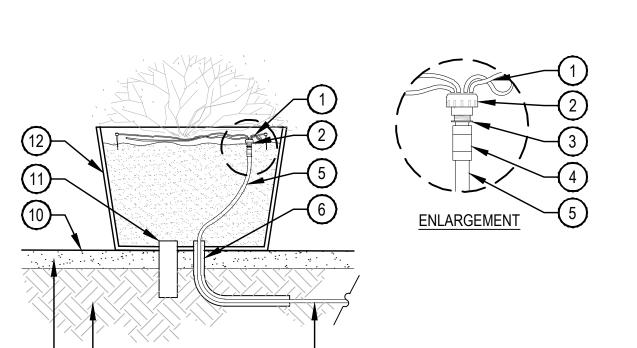
303.441.3861 **CONTACT: MOLLY CHIANG**

DATE: 06.17.22 - SITE PLAN 01 09.15.22 - SITE PLAN 02

> SHEET TITLE: **IRRIGATION**

DETAILS

LOTS 161, 164, 165, 166 & 167, & OUTLOTS F, I, J, K, L & N OF THE WILLOUGHBY CORNER SUBDIVISION, CITY OF LAFAYETTE, COUNTY OF BOULDER, STATE OF COLORADO



1) 1/4" DISTRIBUTION TUBING W/ STAKE (RAIN BIRD TS-025)

2 MULTI-OUTLET EMITTER

3 1/2" RAIN BIRD MDCF-50MPT DRIP MALE ADAPTER FITTING

(4) RAIN BIRD MDCF-COUP DRIP COUPLING FITTING

(5) 1/2" RAIN BIRD XF SERIES **BLANK TUBING**

(6) 1-1/2" CONDUIT SLEEVING -CONTRACTOR TO SEAL POT OPENING AROUND SLEEVING

(7) BLANK TUBING TO VALVE

8 COMPACTED SUB GRADE

9 PAVING PER LANDSCAPE

OR 10 FINISH GRADE CONTRACTOR SHALL ALLOCATE ADDITIONAL LENGTH IN BLANK TUBING WITHIN PLANTER

2 PLANT CENTER

(3) PLANT ROOTBALL


(4) SINGLE OUTLET EMITTER

6 1/4" DISTRIBUTION TUBING (LENGTH NOT TO EXCEED 8')

(5) 3/4" POLYETHYLENE DRIP TUBING

(11) DRAINAGE PER LANDSCAPE

(12) PLANTER PER LANDSCAPE

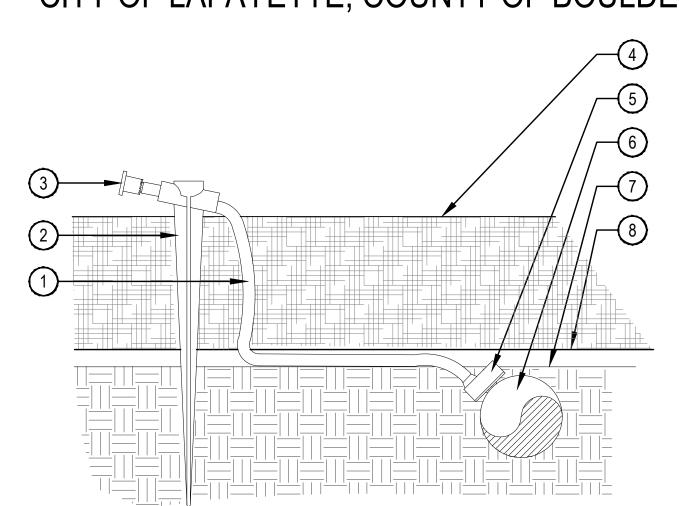

1/4" DISTRIBUTION TUBING. RUN TUBING UNDER WEED BARRIER FABRIC TO PLANT. LENGTH NOT TO EXCEED 8'

2 UNIVERSAL 1/4" STAKE

3 DIFFUSER CAP


(4) TOP OF MULCH

(5) PRESSURE COMPENSATING EMITTER PER EMITTER SCHEDULE. INSTALL EMITTER AT 45° TO 60° ANGLE

(6) 3/4" POLYETHYLENE TUBING SET WITH TOP OF TUBING FLUSH WITH FINISH GRADE OF SOIL

(7) FINISH GRADE OF SOIL

8 WEED BARRIER FABRIC

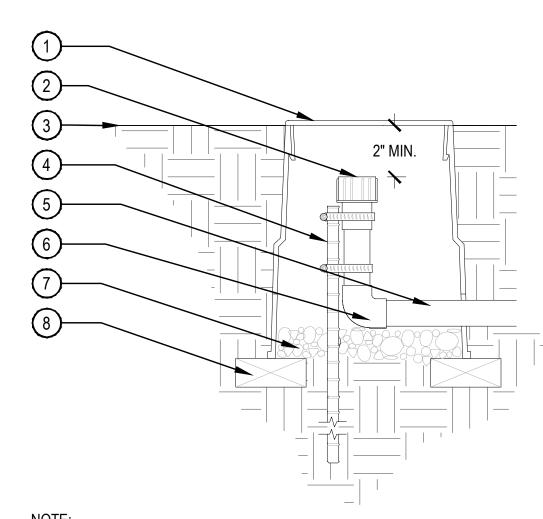


1. COMPACT SOIL AROUND VALVE BOX TO THE SAME DENSITY AS ADJACENT UNDISTURBED

2. SECURE STAKE TO FLUSH END CAP WITH A MIN. OF TWO S.S. CLAMPS.

DRIP FLUSH END CAP

MULTI-OUTLET EMITTER IN RAISED PLANTERS

2. CONDUIT SLEEVING TO EXTEND 2 FEET FROM PLANTER BOX.

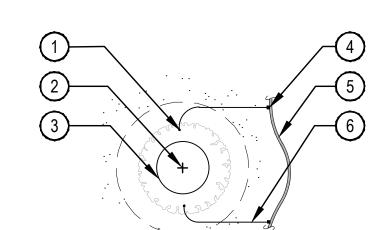

1. EMITTERS SHALL BE EQUALLY SPACED AROUND ROOTBALL


2. FLUSH ALL LINES THOROUGHLY PRIOR TO EMITTER INSTALLATION.

2. IF PLANTING ON A 4:1 SLOPE OR STEEPER, INSTALL EMITTERS ON THE UPHILL SIDE OF PLANT. 3. EMITTERS SHALL BE SELF-FLUSHING PRESSURE COMPENSATING-TYPE UNLESS NOTED

4. DRIP VALVE ZONES (HYDROZONES) ARE DESIGNED TO ACCOUNT FOR DIFFERENCES IN PLANT

REQUIREMENTS AND SUN EXPOSURE. 5. CONTRACTOR SHALL ENSURE HYDROZONES ARE VALVED SEPARATELY AS SHOWN ON PLAN. SINGLE OUTLET EMITTER

(1) EMISSION POINT. DIFFUSER CAP W/ DRIP STAKE (TYP.) 1) DIFFUSER CAP W/ DRIP STAKE

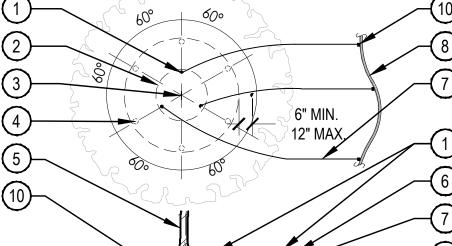

1. MAXIMUM LENGTH OF ONE DISTRIBUTION TUBE SHALL BE 8'

(3) PLANT CENTER (TYP.) 4 SECOND EMISSION POINTS SEE NOTE 3 BELOW

(2) PLANT ROOT BALL (TYP.)

SCALE: NTS

5 TREE TRUNK

6 MULCH LAYER

(7) 1/4" DISTRIBUTION TUBING (LENGTH NOT TO EXCEED 8')

(8) 3/4" POLYETHYLENE DRIP TUBING

SCALE: NTS

9 SINGLE OUTLET EMITTER

10) ROOTBALL

POINTS SHALL BE WITHIN PLANT PIT PERIMETER AS DIRECTED IN THE EMITTER SCHEDULE. 3. SECOND EMISSION POINTS (IF NEEDED) AS PER THE EMITTER SCHEDULE FOR TREES WITH 3" CALIPER OR GREATER OR CONIFEROUS TREES 10' OR GREATER IN HEIGHT.

2. ALL EMISSION POINTS SHALL BE LOCATED ON UPHILL SIDE OF PLANT MATERIAL. ONE

EMISSION POINT SHALL BE DIRECTLY TO PLANT BALL AS INDICATED. ADDITIONAL EMISSION

4. THIS IS A WATERING GUIDE ONLY. SITE, SOIL AND PLANT CONDITIONS VARY GREATLY. CONTRACTOR MUST OBSERVE THE PLANT MATERIAL AND MAKE ADJUSTMENTS AS

NECESSARY FOR PROPER PLANT WATER REQUIREMENT.

TREE EMITTER PLACEMENT

SINGLE OUTLET EMITTER PLACEMENT

CHECKED BY: DRAWN BY:

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CORNER

OWNER: BOULDER COUNTY HOUSING AUTHORITY 3400 BROADWAY BOULDER, CO - 80304

303.441.3861 CONTACT: MOLLY CHIANG

FIRST FLOOR 100' - 0"

DATE: 06.17.22 - SITE PLAN 01 09.15.22 - SITE PLAN 02

SHEET TITLE:

SENIOR BLDG **ELEVATIONS**

51


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P-6

P-3

8



17

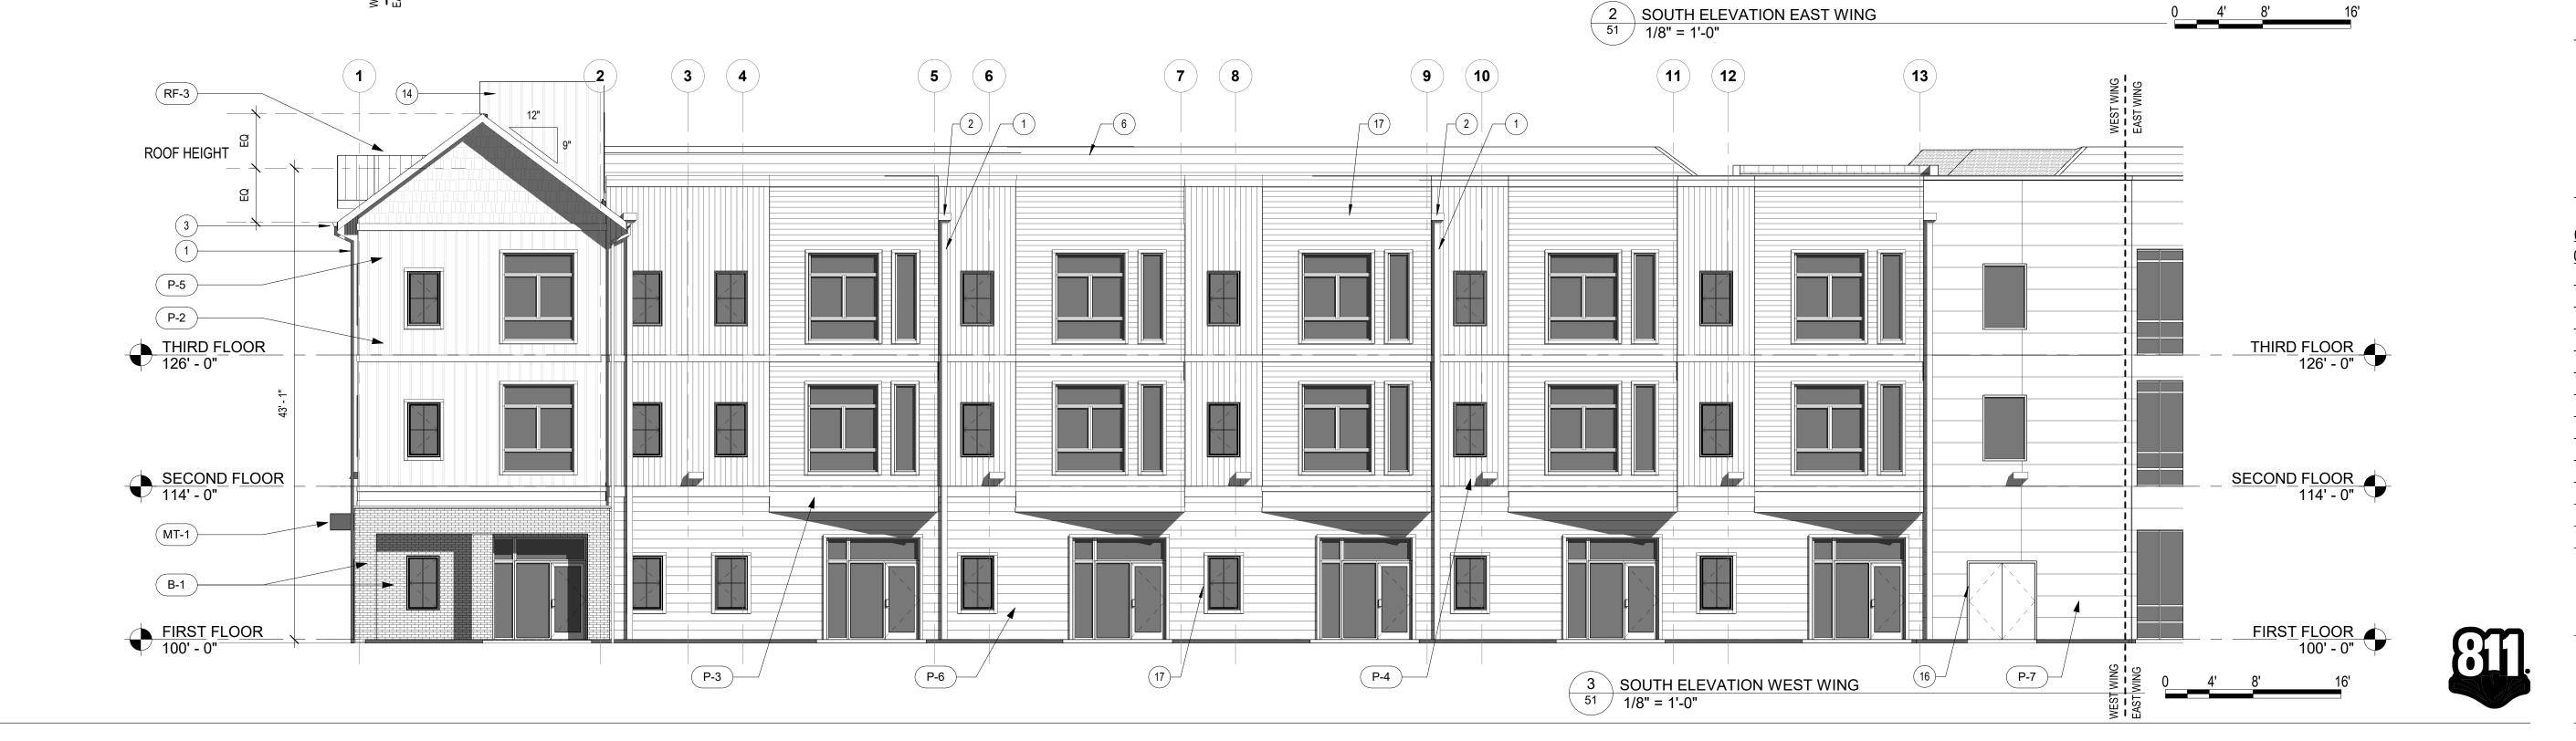P-4

DESCRIPTION

FIBER CEMENT PANEL BOARD SIDING, ACCENT COLOR

FIRST FLOOR

BRICK VENEER, LIGHT COLORED

BRICK VENEER, DARK COLORED

FIBER CEMENT BOARD & BATTEN SIDING

BRICK VENEER, CHARCOAL METAL PANEL, CHARCOAL

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B-2

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P-7

OWNER:

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DATE:

THIRD FLOOR

SECOND FLOOR

FIRST FLOOR 100' - 0"

CITY OF LAFAYETTE, COUNTY OF BOULDER, STATE OF COLORADO	
1 NORTH ELEVATION OVERALL	




RF-1

P-4

NORTH ELEVATION WEST WING

| 1/8" = 1'-0"

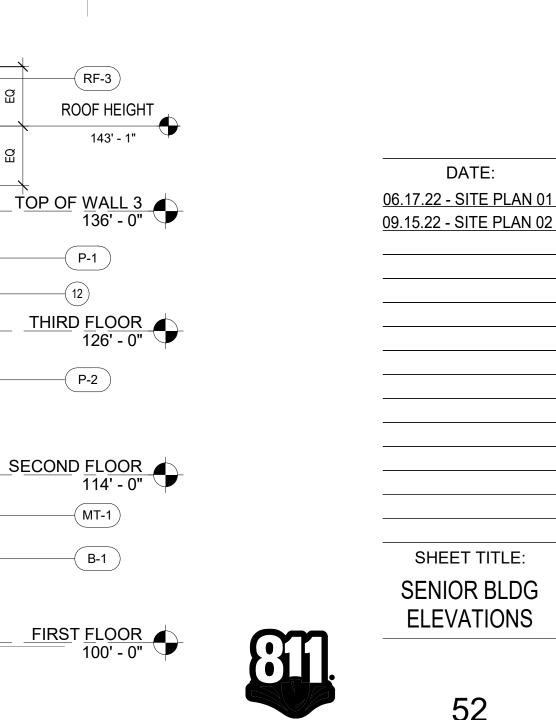

—(P-2)

MT-1

B-1

MATERIAL DESCRIPTION BRICK VENEER, LIGHT COLORED BRICK VENEER, DARK COLORED BRICK VENEER, CHARCOAL METAL PANEL, CHARCOAL FIBER CEMENT PANEL BOARD SIDING, ACCENT COLOR FIBER CEMENT BOARD & BATTEN SIDING FIBER CEMENT 6" LAP SIDING FIBER CEMENT VERTICAL WOOD GRAIN FIBER CEMENT SHINGLE WALL PANEL FIBER CEMENT 10" LAP SIDING BOARD FIBER CEMENT PANEL BOARD SIDING FIBER CEMENT VERTICAL SIDING RF-1 ASPHALT SHINGLE ROOF MEMBRANE ROOF STANDING SEAM ROOF X NOTES LEGEND ELEVATIONS

DOWNSPOUT, CHARCOAL, TYP. SCUPPER, CHARCOAL, TYP.

GUTTER, CHARCOAL, TYP.

4 STOREFRONT WINDOWS BALCONY

FLAT ROOF BEYOND

METAL CANOPY, CHARCOAL LIGHT WALL PACK

FIBERGLASS WINDOWS, TYP 10 UTILITY METER

11 FIRE ALARM STROBE/HORN 12 PATIO AREA

14 ROOFTOP ACCESS 15 GLULAM COLUMN

16 HM DOOR, PAINTED, DARK BRONZE, CHARCOAL, TYP.

17 WINDOW TRIM, CHARCOAL, TYP. 18 WINDOW TRIM, WHITE, TYP.

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TOP OF WALL 3

THIRD FLOOR

DATE: 06.17.22 - SITE PLAN 01 09.15.22 - SITE PLAN 02

SHEET TITLE: SENIOR BLDG **ELEVATIONS**

WILLOUGHBY CORNER SITE PLAN - PHASE 1

LOTS 161, 164, 165, 166 & 167, & OUTLOTS F, I, J, K, L & N OF THE WILLOUGHBY CORNER SUBDIVISION, CITY OF LAFAYETTE, COUNTY OF BOULDER, STATE OF COLORADO

TOP OF WALL 3 136' - 0"

THIRD FLOOR 126' - 0"

BRICK VENEER, LIGHT COLORED BRICK VENEER, DARK COLORED BRICK VENEER, CHARCOAL METAL PANEL, CHARCOAL FIBER CEMENT PANEL BOARD SIDING, ACCENT COLOR FIBER CEMENT BOARD & BATTEN SIDING FIBER CEMENT 6" LAP SIDING FIBER CEMENT VERTICAL WOOD GRAIN FIBER CEMENT SHINGLE WALL PANEL FIBER CEMENT 10" LAP SIDING BOARD FIBER CEMENT PANEL BOARD SIDING FIBER CEMENT VERTICAL SIDING ASPHALT SHINGLE ROOF MEMBRANE ROOF

STANDING SEAM ROOF


DESCRIPTION


MATERIAL

(X) NOTES LEGEND ELEVATIONS

- DOWNSPOUT, CHARCOAL, TYP
- SCUPPER, CHARCOAL, TYP.
- STOREFRONT WINDOWS
- FLAT ROOF BEYOND
- METAL CANOPY, CHARCOAL LIGHT WALL PACK
- FIBERGLASS WINDOWS, TYP
- 10 UTILITY METER 11 FIRE ALARM STROBE/HORN
- 12 PATIO AREA
- 14 ROOFTOP ACCESS
- 15 GLULAM COLUMN
- 18 WINDOW TRIM, WHITE, TYP.



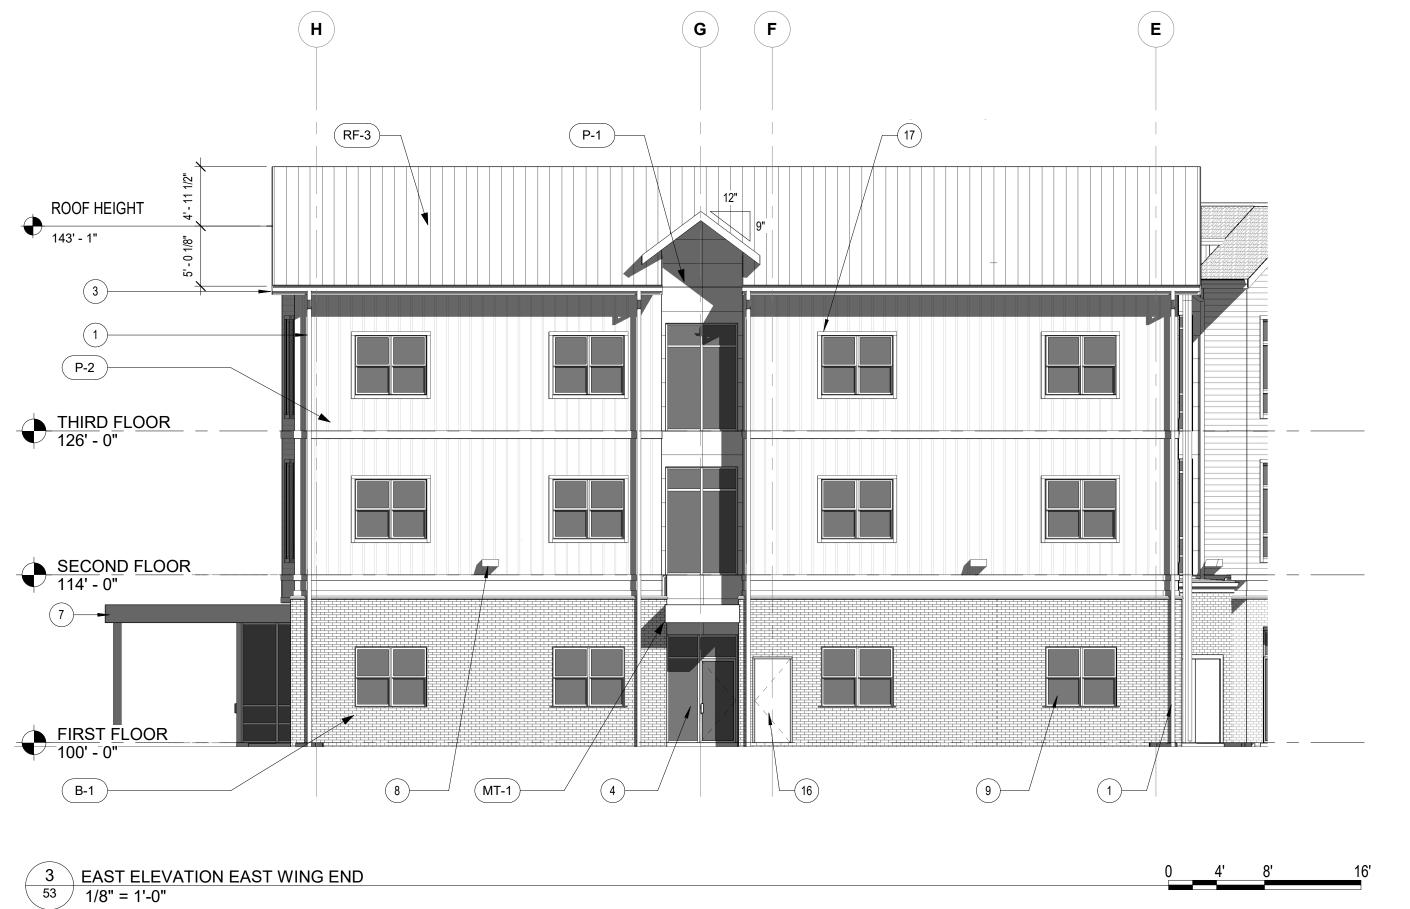

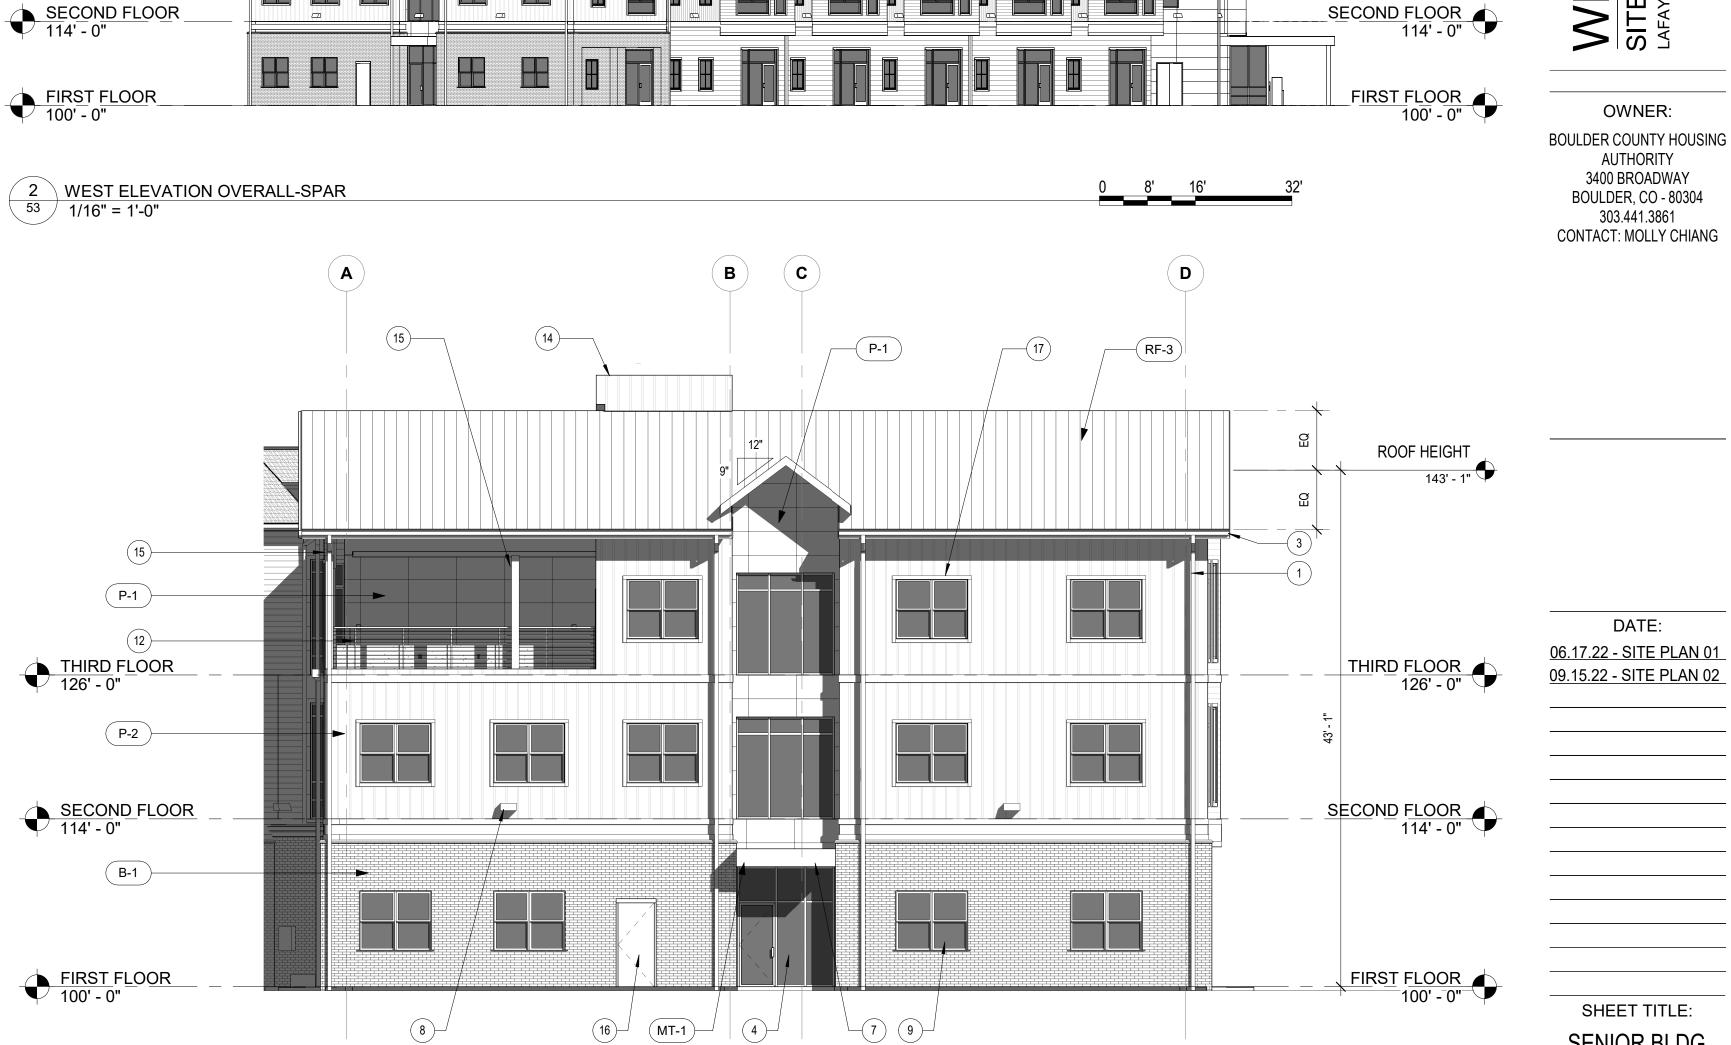

4 NW ELEVATION WEST WING END-SPAR
53 1/8" = 1'-0"

LOTS 161, 164, 165, 166 & 167, & OUTLOTS F, I, J, K, L & N OF THE WILLOUGHBY CORNER SUBDIVISION, CITY OF LAFAYETTE, COUNTY OF BOULDER, STATE OF COLORADO

(\mathbf{x})	NOTES LEGEND ELEVATIONS

DOWNSPOUT, CHARCOAL, TYP.

SCUPPER AND DOWNSPOUT, CHARCOAL, TYP.
GUTTER, CHARCOAL, TYP.

STOREFRONT AT PUBLIC AREAS EXPOSED WOOD TRUSS FLAT ROOF BEYOND METAL CANOPY, CHARCOAL

LIGHT WALL PACK
FIBERGLASS WINDOW, TYP.

WINDOW TRIM, CHARCOAL, TYP
WINDOW TRIM, WHITE, TYP

12 PATIO AREA
13 HM DOOR, PAINTED, CHARCOAL, TYP.
14 ROOFTOP ACCESS

15 GLULAM COLUMN
 17 HSS COLUMN, WRAPPED W FIBER CEMENT TRIM BOARD, CHARCOAL

18 SWING PATIO DOORS19 F.D.C.

1 NORTH ELEVATION - MULTI-FAMILY BUILDING 1 (MF-1)
54 3/32" = 1'-0"

MATERIAL

DESCRIPTION

FIBER CEMENT PANEL BOARD SIDING, ACCENT COLOR

BRICK VENEER, LIGHT COLORED

BRICK VENEER, DARK COLORED

FIBER CEMENT BOARD & BATTEN SIDING

FIBER CEMENT VERTICAL WOOD GRAIN

FIBER CEMENT SHINGLE WALL PANEL

FIBER CEMENT PANEL BOARD SIDING

BRICK VENEER, CHARCOAL

METAL PANEL

FIBER CEMENT 6" LAP SIDING

FIBER CEMENT 6" LAP SIDING

FIBER CEMENT 10" LAP SIDING

ASPHALT SHINGLE ROOF

STANDING SEAM ROOF

MEMBRANE ROOF

FIBER CEMENT VERTICAL SIDING





SHEET TITLE:
MF1 BUILDING
ELEVATIONS

2 SOUTH ELEVATION - MULTI-FAMILY BUILDING 1 (MF-1)

54 3/32" = 1'-0"

54

7)))

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AUTHORITY 3400 BROADWAY

BOULDER, CO - 80304 303.441.3861

CONTACT: MOLLY CHIANG

DATE:

06.17.22 - SITE PLAN 01 09.15.22 - SITE PLAN 02

LOTS 161, 164, 165, 166 & 167, & OUTLOTS F, I, J, K, L & N OF THE WILLOUGHBY CORNER SUBDIVISION, CITY OF LAFAYETTE, COUNTY OF BOULDER, STATE OF COLORADO

(X) NOTES LEGEND ELEVATIONS

DOWNSPOUT, CHARCOAL, TYP.

SCUPPER AND DOWNSPOUT, CHARCOAL, TYP.

GUTTER, CHARCOAL, TYP. STOREFRONT AT PUBLIC AREAS

EXPOSED WOOD TRUSS FLAT ROOF BEYOND

METAL CANOPY, CHARCOAL LIGHT WALL PACK

FIBERGLASS WINDOW, TYP. WINDOW TRIM, CHARCOAL, TYP

WINDOW TRIM, WHITE, TYP 12 PATIO AREA

13 HM DOOR, PAINTED, CHARCOAL, TYP. 14 ROOFTOP ACCESS

15 GLULAM COLUMN


17 HSS COLUMN, WRAPPED W FIBER CEMENT TRIM BOARD, CHARCOAL 18 SWING PATIO DOORS

19 F.D.C.

10 10 —(P-1) 143' - 4" (P-2) (P-2) THIRD FLOOR 126' - 0" SECOND FLOOR 114' - 0" SECOND FLOOR 114' - 0" —(B-1) FIRST FLOOR 100' - 0" 4

2 EAST ELEVATION -MULTI-FAMILY BUILDING 1 (MF-1)
55 3/32" = 1'-0"

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1 WEST ELEVATION - MULTI-FAMILY BUILDING 1 (MF-1)
55 3/32" = 1'-0"

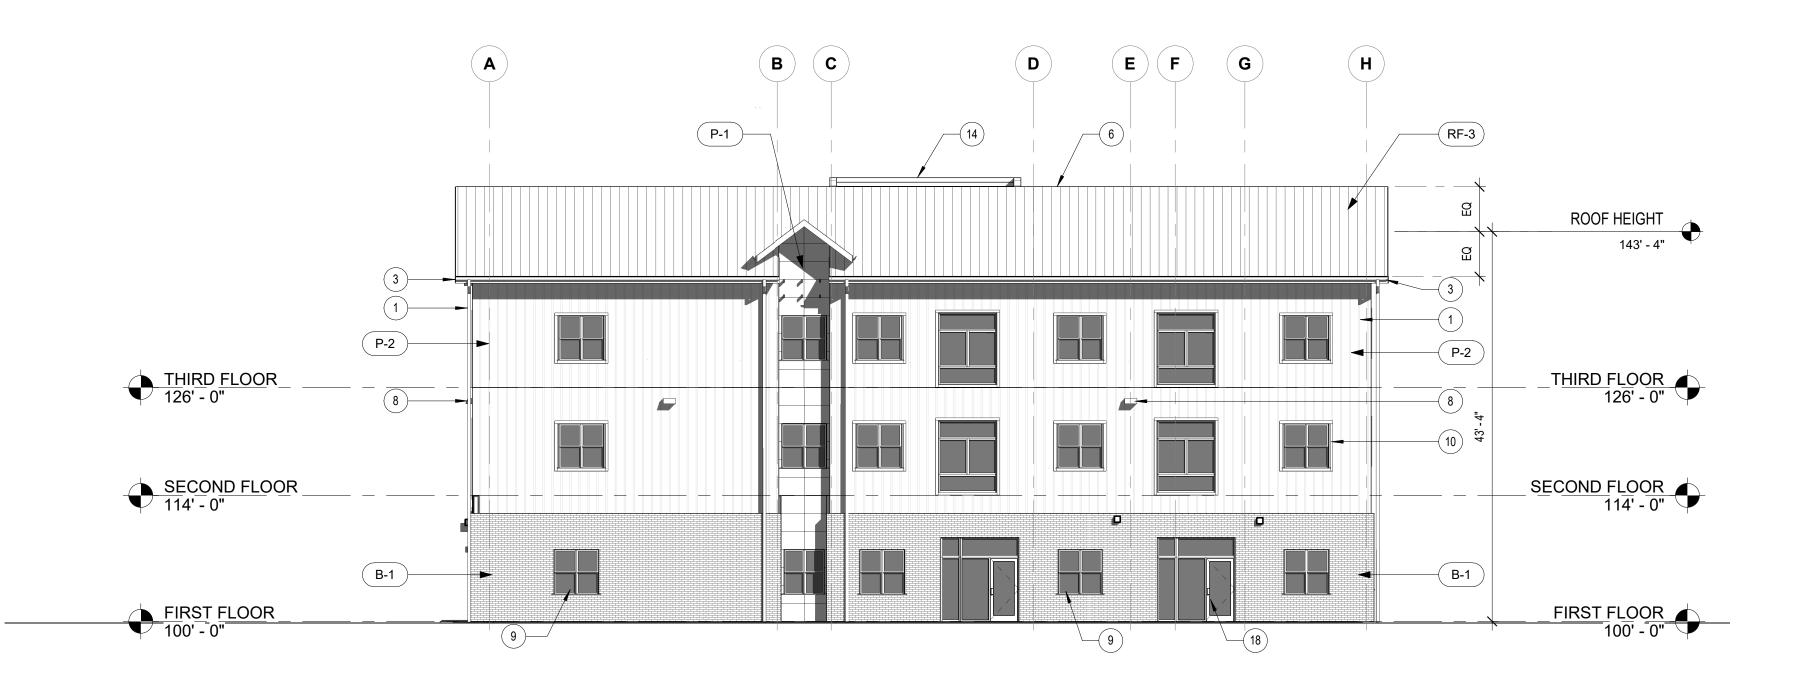MATERIAL

MT-1

DESCRIPTION

FIBER CEMENT PANEL BOARD SIDING, ACCENT COLOR

BRICK VENEER, LIGHT COLORED

BRICK VENEER, DARK COLORED

FIBER CEMENT BOARD & BATTEN SIDING

FIBER CEMENT VERTICAL WOOD GRAIN

FIBER CEMENT SHINGLE WALL PANEL

FIBER CEMENT PANEL BOARD SIDING

BRICK VENEER, CHARCOAL

METAL PANEL

FIBER CEMENT 6" LAP SIDING

FIBER CEMENT 6" LAP SIDING

FIBER CEMENT 10" LAP SIDING

ASPHALT SHINGLE ROOF

STANDING SEAM ROOF

MEMBRANE ROOF

FIBER CEMENT VERTICAL SIDING

55

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SHEET TITLE: MF1 BUILDING **ELEVATIONS**

4

P-6

P-4

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DATE: 06.17.22 - SITE PLAN 01 09.15.22 - SITE PLAN 02

SHEET TITLE:

MF2 BUILDING **ELEVATIONS**

2 SOUTH ELEVATION - MULTIFAMILY BUILDING 2 (MF-2)

56 1/8" = 1'-0"

—(14) P-7

4

P-5

P-2

MT-1

P-3

ROOF HEIGHT

THIRD FLOOR

SECOND FLOOR 114' - 0"

FIRST FLOOR 100' - 0"

126' - 0"

P-2

—(MT-1)

-(B-1)

143' - 7 1/2"

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DATE: 09.15.22 - SITE PLAN 02

SHEET TITLE:


MF2 BUILDING **ELEVATIONS**

303.441.3861 CONTACT: MOLLY CHIANG

06.17.22 - SITE PLAN 01

WILLOUGHBY CORNER SITE PLAN - PHASE 1

LOTS 161, 164, 165, 166 & 167, & OUTLOTS F, I, J, K, L & N OF THE WILLOUGHBY CORNER SUBDIVISION, CITY OF LAFAYETTE, COUNTY OF BOULDER, STATE OF COLORADO

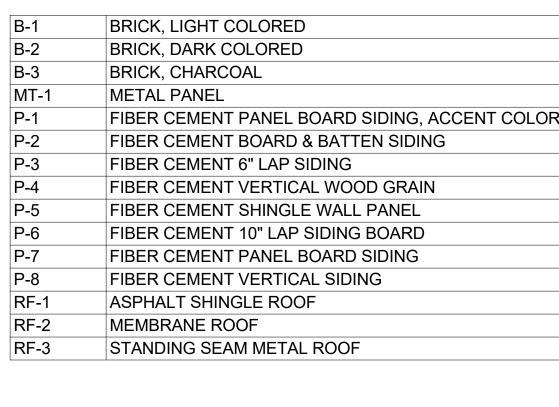

DESCRIPTION

(x) NOTES LEGEND ELEVATIONS

MATERIAL

DOWNSPOUT, CHARCOAL, TYP. SCUPPER AND DOWNSPOUT, CHARCOAL, TYP. GUTTER, CHARCOAL, TYP.

STOREFRONT AT PUBLIC AREAS EXPOSED WOOD TRUSSES FLAT ROOF BEYOND

LIGHT WALL PACK FIBERGLASS WINDOWS, TYP. 10 HM DOOR, PAINTED, CHARCOAL, TYP 11 F.D.C.

METAL CANOPY, CHARCOAL

14 ROOFTOP ACCESS 15 GLULAM COLUMN 16 HSS COLUMN, WRAPPED W CHARCOAL FIBER CEMENT TRIM

17 WINDOW TRIM, CHARCOAL, TYP.

18 WINDOW TRIM, WHITE, TYP.

13 ELECTRICAL EQUIPMENT


12 PATIO AREA



1 EAST ELEVATION - MULTIFAMILY BUILDING2 (MF-2)
1/8" = 1'-0"

2 WEST ELEVATION - MULTIFAMILY BUILDING 2 (MF-2)

1/8" = 1'-0"

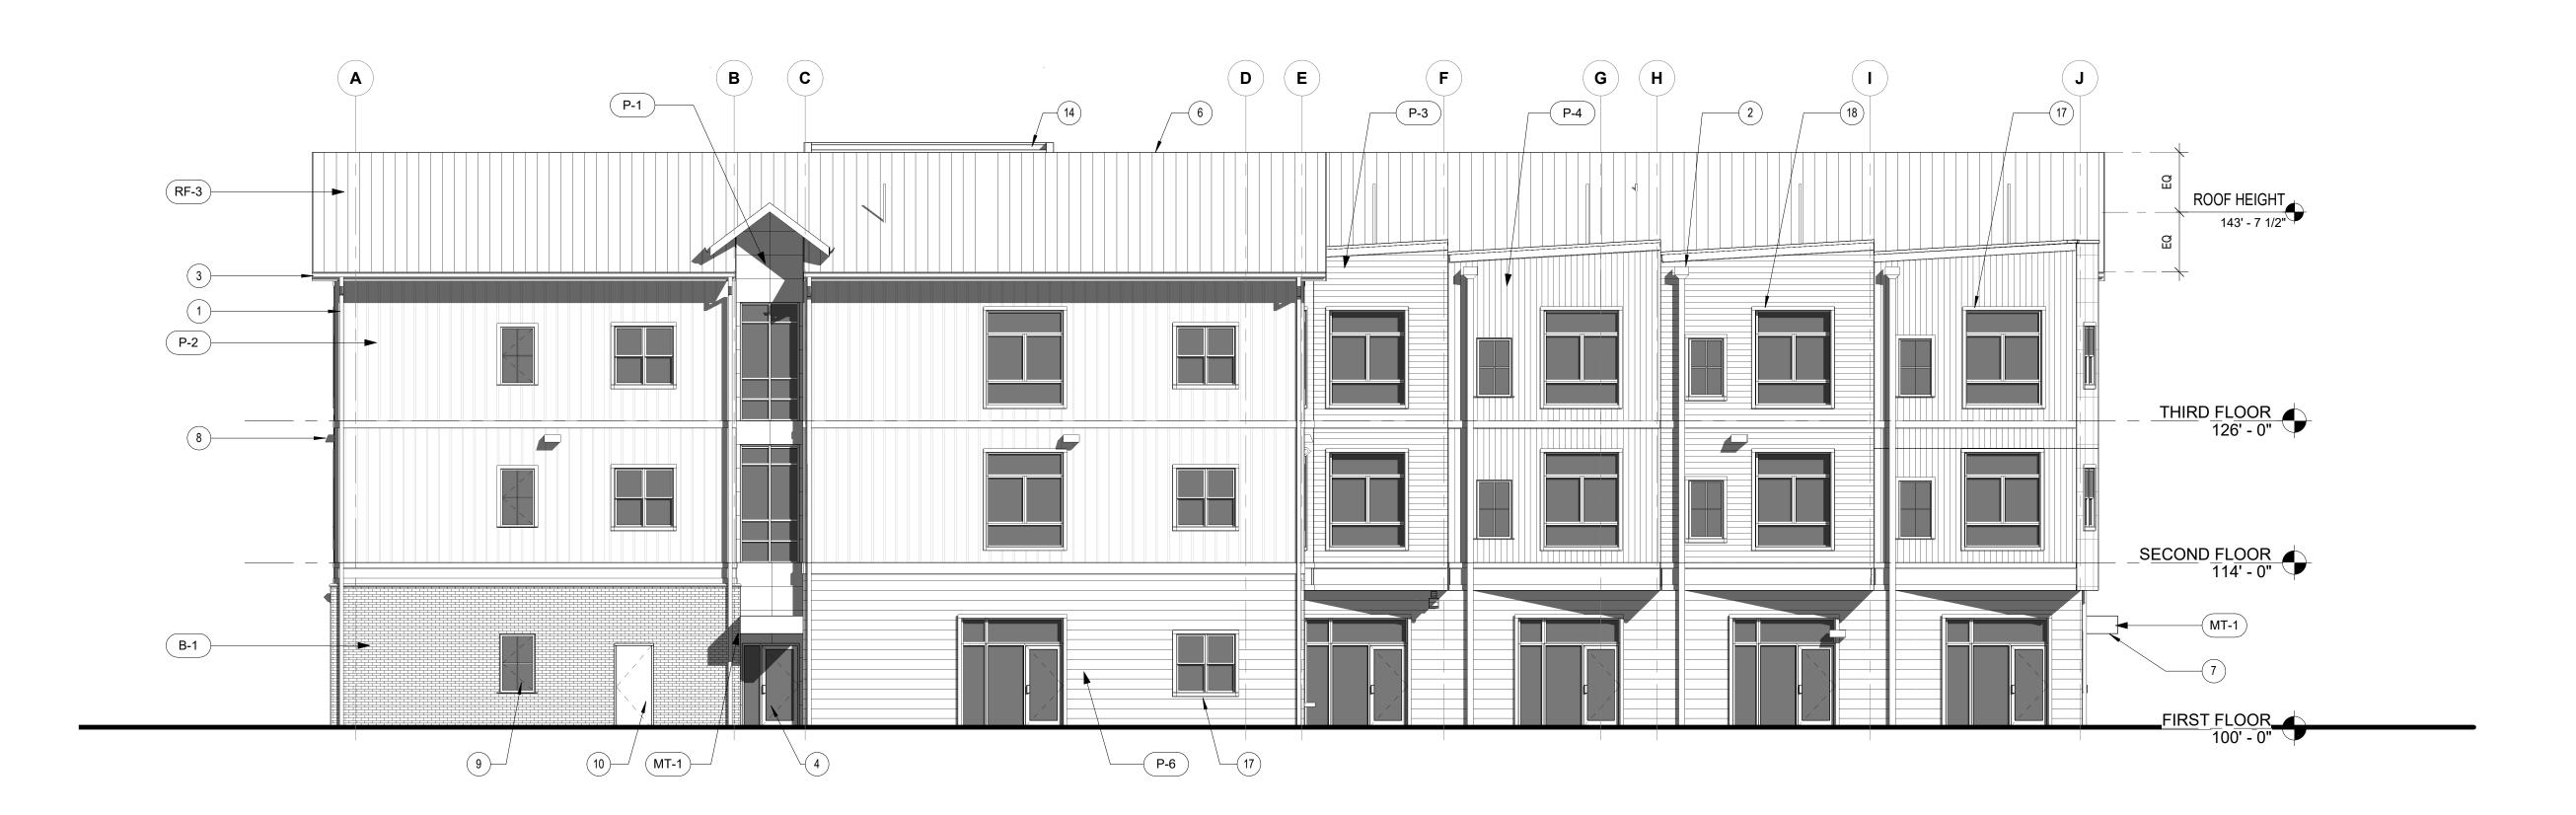

OWNER:

SHEET TITLE: COMM. BLDG **ELEVATIONS**

WILLOUGHBY CORNER SITE PLAN - PHASE 1

LOTS 161, 164, 165, 166 & 167, & OUTLOTS F, I, J, K, L & N OF THE WILLOUGHBY CORNER SUBDIVISION, CITY OF LAFAYETTE, COUNTY OF BOULDER, STATE OF COLORADO



DATE:


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06.17.22 - SITE PLAN 01 09.15.22 - SITE PLAN 02

SH**FEATIS**LE: **BUILDING 1 ELEVATIONS**

WILLOUGHBY CORNER SITE PLAN - PHASE 1


LOTS 161, 164, 165, 166 & 167, & OUTLOTS F, I, J, K & N OF THE WILLOUGHBY CORNER SUBDIVISION, CITY OF LAFAYETTE, COUNTY OF BOULDER, STATE OF COLORADO

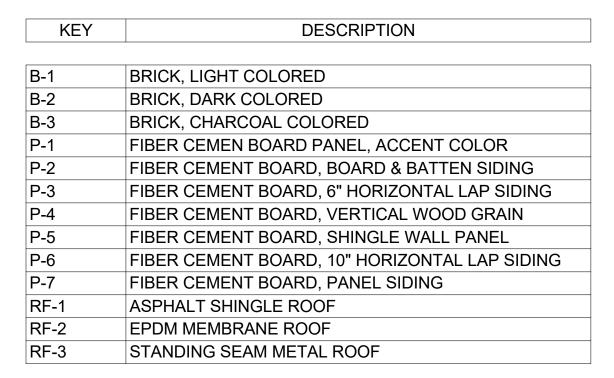



X NOTES LEGEND 1ST ELEVATION

- GUTTER, CHARCOAL, TYP. DOWNSPOUT, CHARCOAL, TYP
- LIGHT WALL PACK EXPOSED ENGINEERED WOOD COLUMN
- FIBERGLASS WINDOW, TYP HM DOOR, PAINTED, CHARCOAL, TYP.
- **EMERGENCY LIGHT**
- 9 WALL SCONCE
- 10 EXPOSED GLULAM WOOD TRUSS & BEAM 11 SLIDING PATIO DOOR
- 12 JULIETTE BALCONY WITH SLIDING GLASS PATIO DOORS. TYP.
- 13 UTILITY METER
- 14 UTILITY STACK
- 16 SLOPED ROOF BEYOND 17 SOLDIER COURSE BRICK



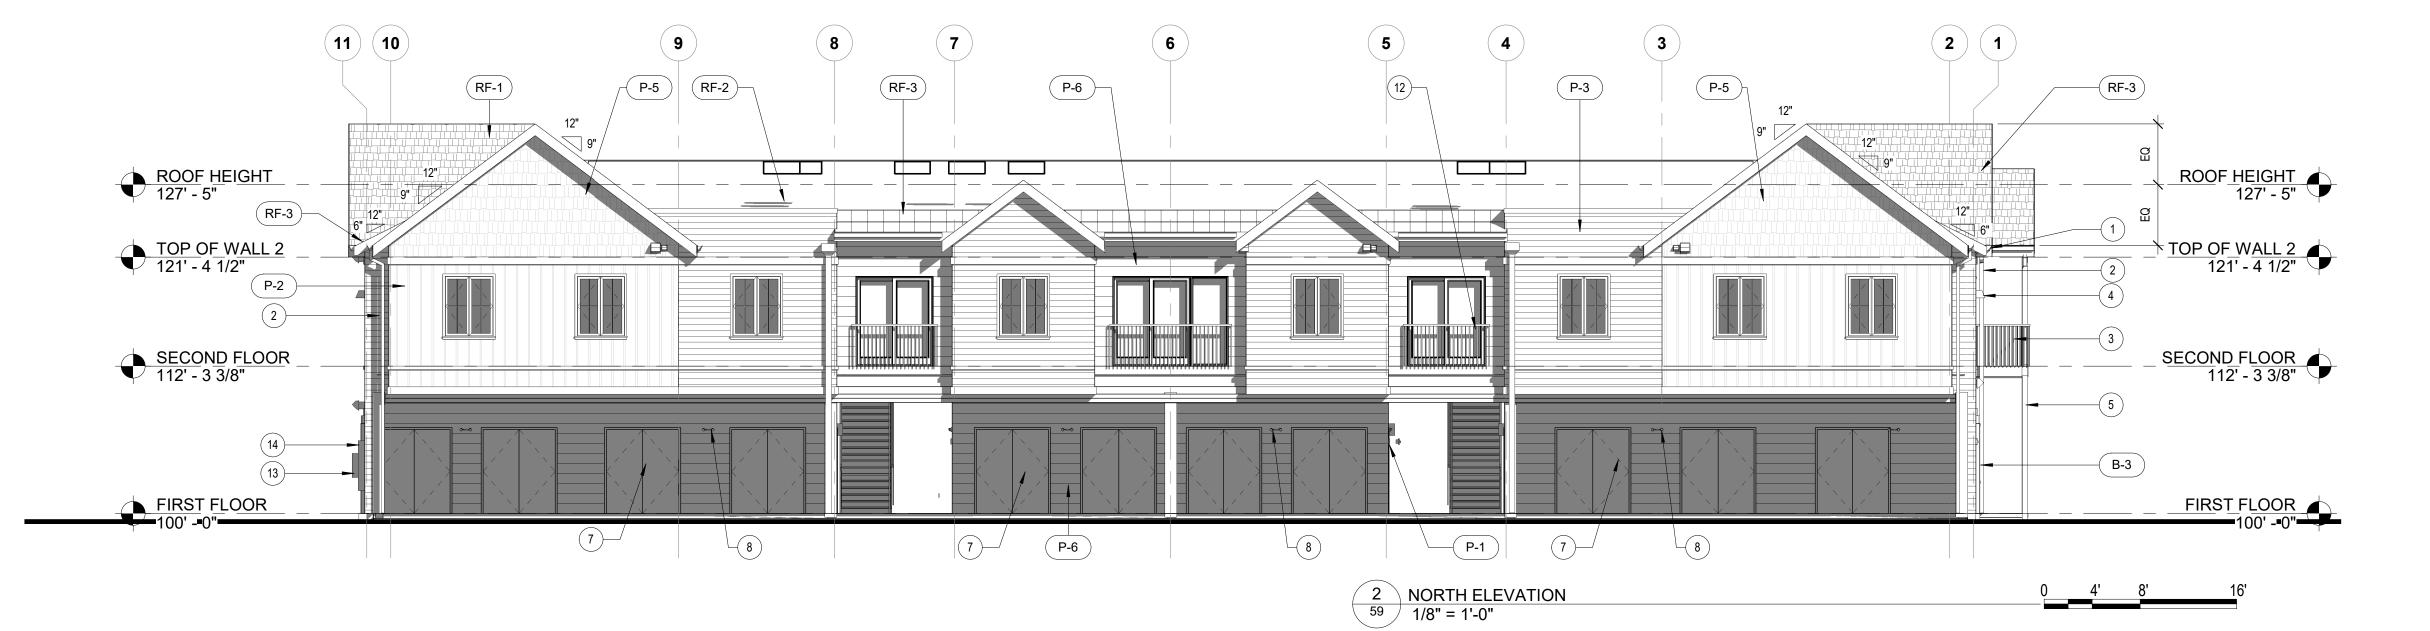

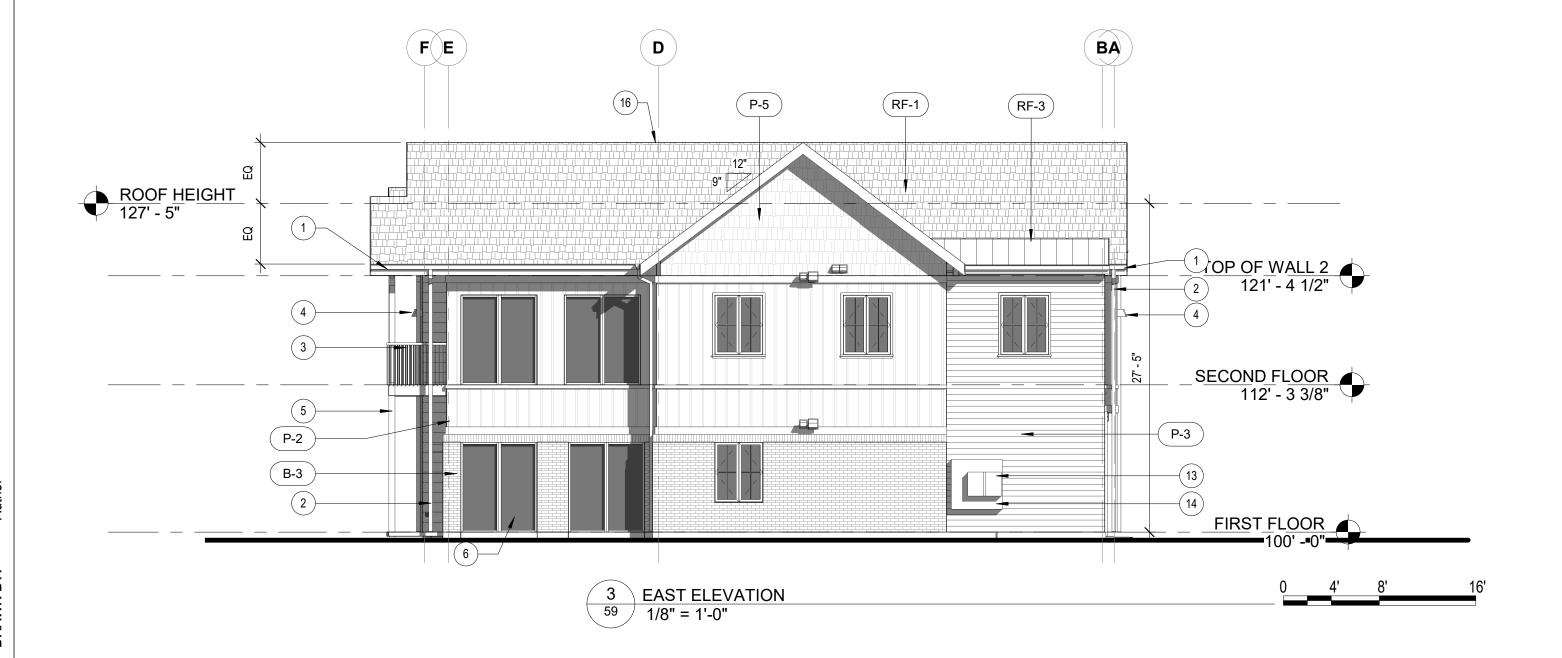

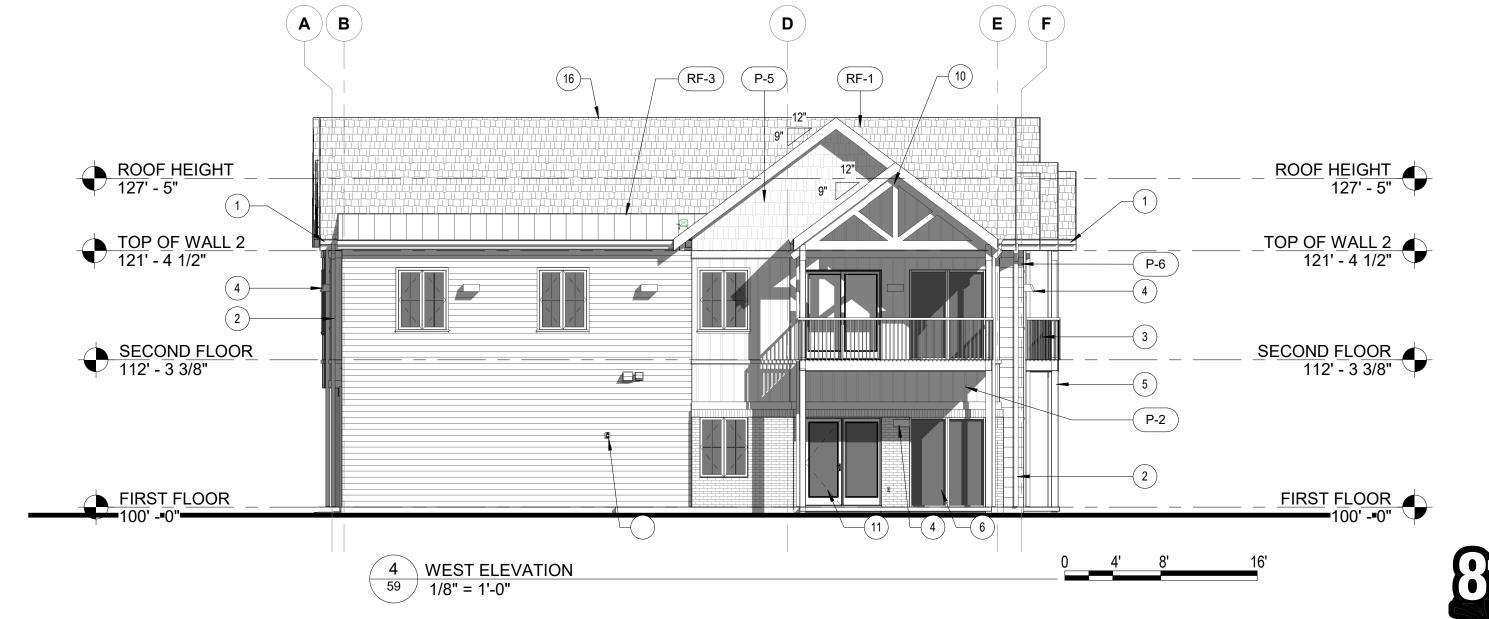

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CONTACT: MOLLY CHIANG


DATE: 06.17.22 - SITE PLAN 01 09.15.22 - SITE PLAN 02

> SH**FEATIS**LE: BUILDING 2

BUILDING 2
ELEVATIONS


WILLOUGHBY CORNER SITE PLAN - PHASE 1

LOTS 161, 164, 165, 166 & 167, & OUTLOTS F, I, J, K & N OF THE WILLOUGHBY CORNER SUBDIVISION, CITY OF LAFAYETTE, COUNTY OF BOULDER, STATE OF COLORADO

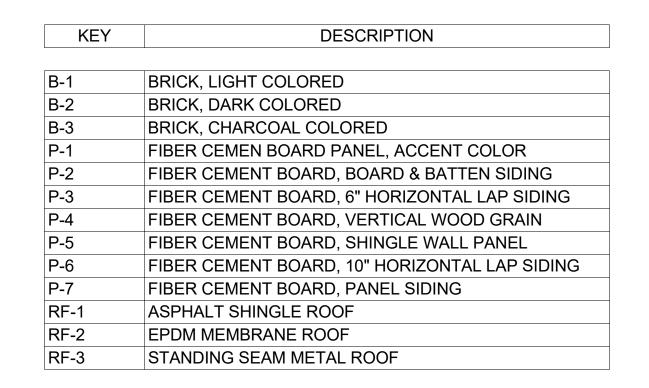


X NOTES LEGEND 1ST ELEVATION


- GUTTER, CHARCOAL, TYP.
- DOWNSPOUT, CHARCOAL, TYP BALCONY
- 4 LIGHT WALL PACK5 EXPOSED ENGINEERED WOOD COLUMN
- FIBERGLASS WINDOW, TYP
 HM DOOR, PAINTED, CHARCOAL, TYP.
- 8 EMERGENCY LIGHT 9 WALL SCONCE
- 10 EXPOSED GLULAM WOOD TRUSS & BEAM
- 11 SLIDING PATIO DOOR12 JULIETTE BALCONY WITH SLIDING GLASS PATIO DOORS. TYP.
- 12 JULIETTE BALCONY W13 UTILITY METER
- 14 UTILITY STACK
- 16 SLOPED ROOF BEYOND17 SOLDIER COURSE BRICK

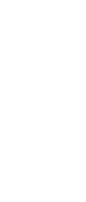



—(P-2)

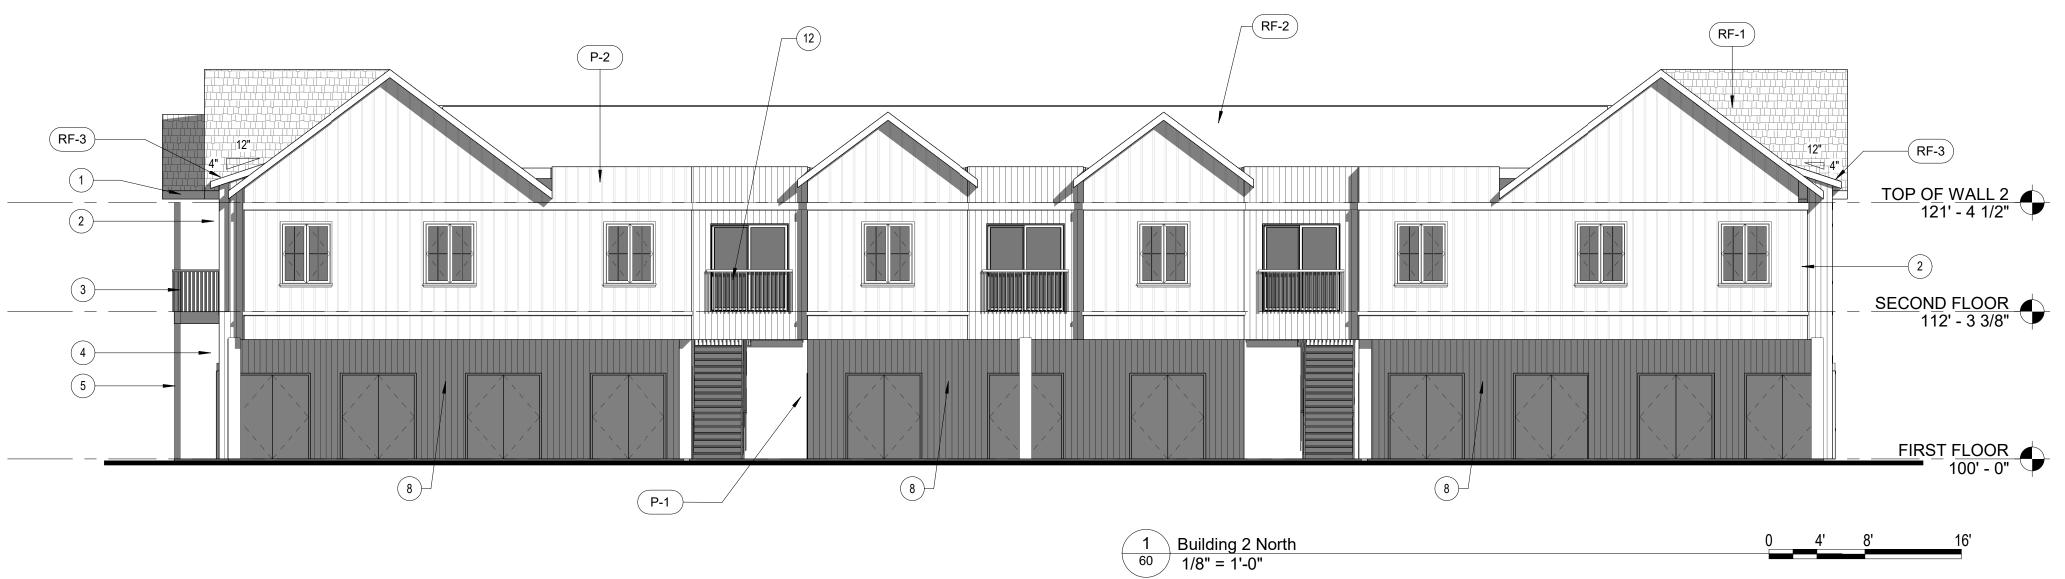

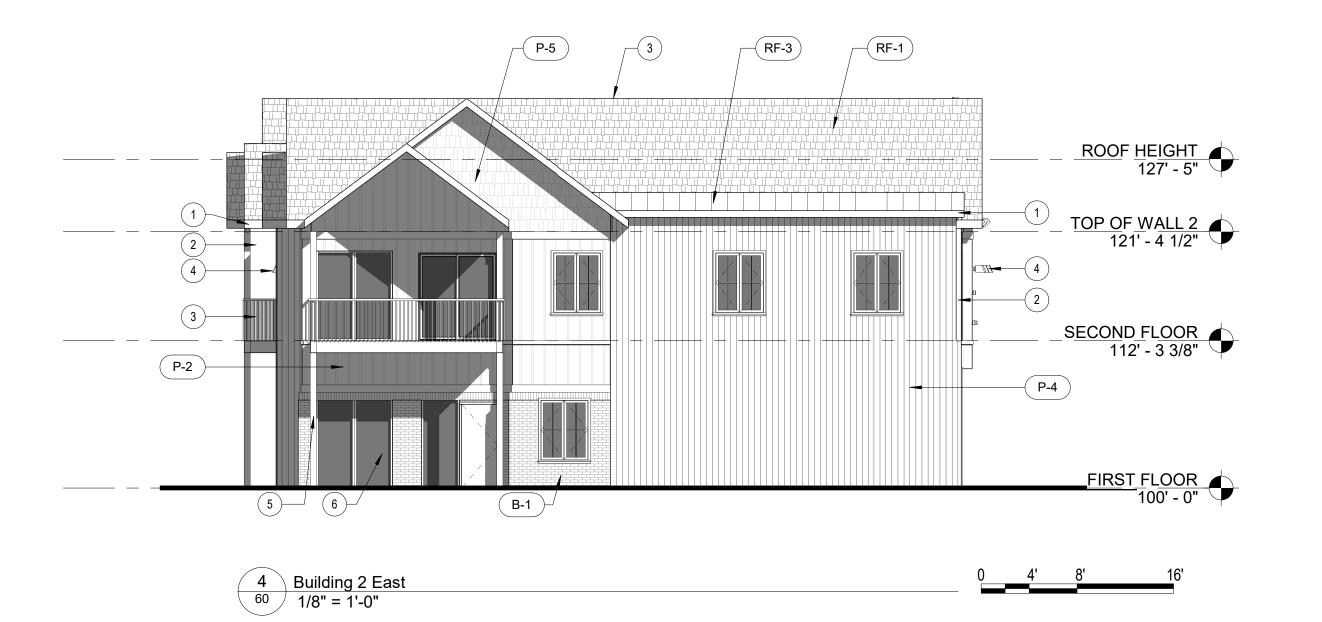



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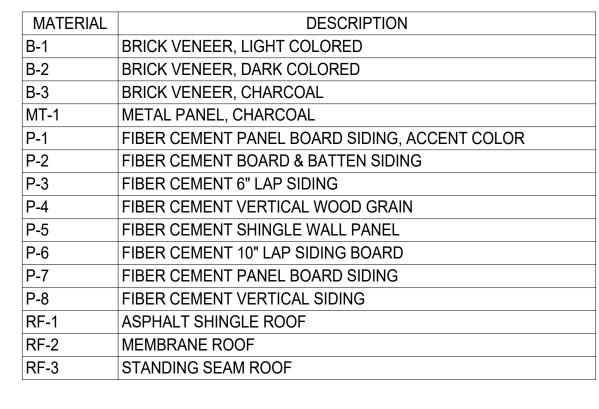
OWNER:


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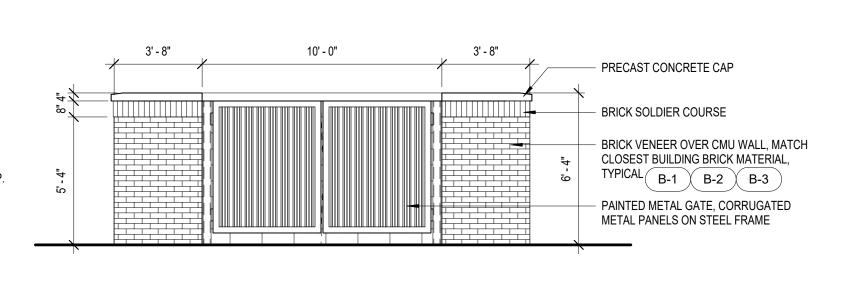
MISC. SITE STRUCTURES


WILLOUGHBY CORNER SITE PLAN - PHASE 1


LOTS 161, 164, 165, 166 & 167, & OUTLOTS F, I, J, K, L & N OF THE WILLOUGHBY CORNER SUBDIVISION, CITY OF LAFAYETTE, COUNTY OF BOULDER, STATE OF COLORADO





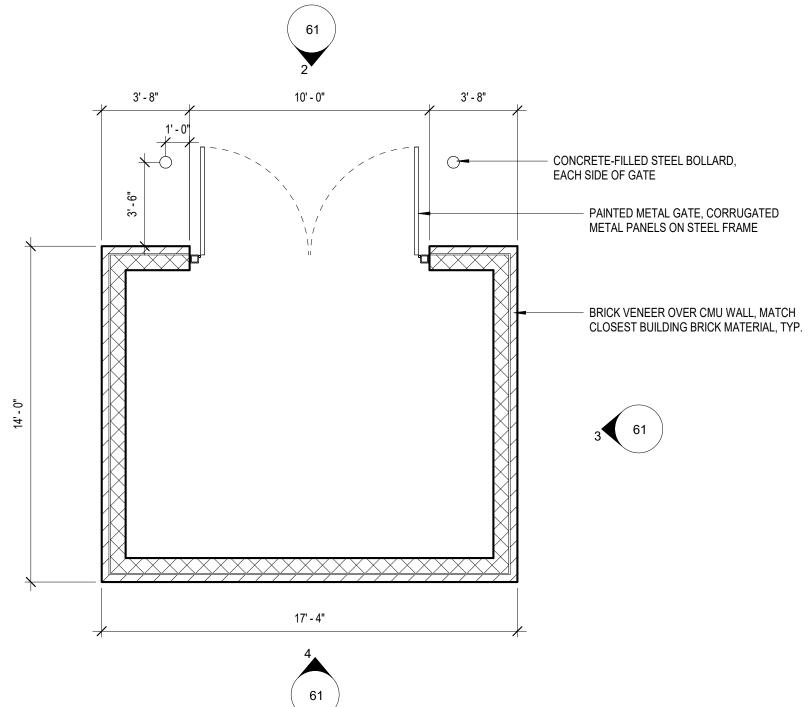

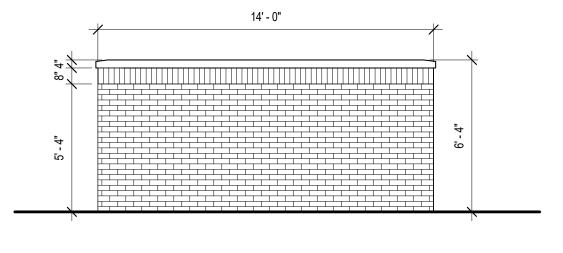

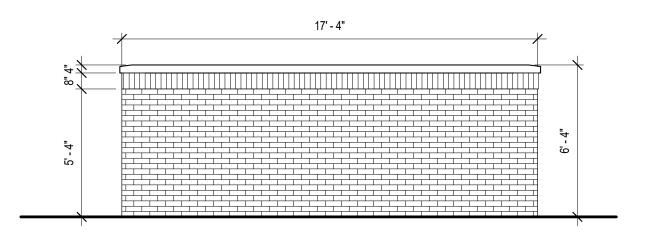



2 SITE - TRASH ENCLOSURE ELEVATION FRONT 61 / 1/4" = 1'-0"

3 SITE - TRASH ENCLOSURE ELEVATION SIDES 61 1/4" = 1'-0"



1 SITE - TRASH ENCLOSURE PLAN
61 1/4" = 1'-0"

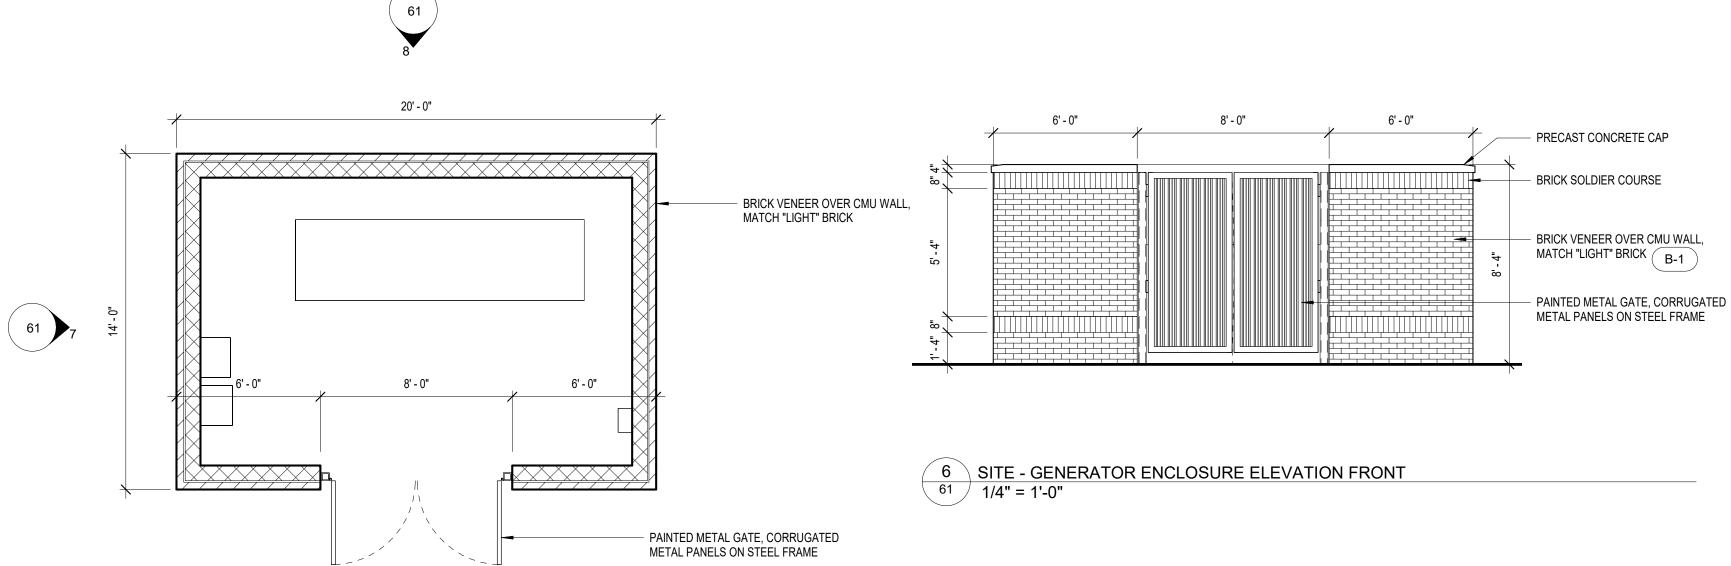

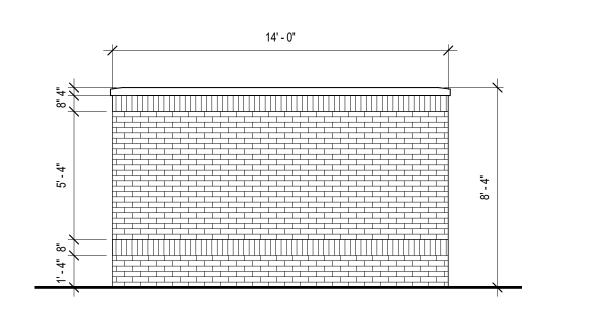

7 SITE - GENERATOR ENCLOSURE ELEVATION SIDES
61 1/4" = 1'-0"



20' - 0"

5 SITE - GENERATOR ENCLOSURE PLAN
1/4" = 1'-0"

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303.441.3861 CONTACT: MOLLY CHIANG

DATE: 06.17.22 - SITE PLAN 01 09.15.22 - SITE PLAN 02


SHEET TITLE:
MISC. SITE
STRUCTURES

WILLOUGHBY CORNER SITE PLAN - PHASE 1


LOTS 161, 164, 165, 166 & 167, & OUTLOTS F, I, J, K, L & N OF THE WILLOUGHBY CORNER SUBDIVISION, CITY OF LAFAYETTE, COUNTY OF BOULDER, STATE OF COLORADO

NOTE: STRUCTURES SHOWN ON THIS SHEET ARE NOTIONAL PLACEHOLDERS. FINAL DESIGN OF BOTH BUS SHELTERS AND CARPORTS TO BE DETERMINED AT A FUTURE TIME. INTENT IS FOR THESE STRUCTURES TO BE DESIGN-BUILD BY A MANUFACTURER SELECTED DURING CONSTRUCTION (BUS SHELTERS) OR UPON FUTURE FUNDING (CARPORTS).



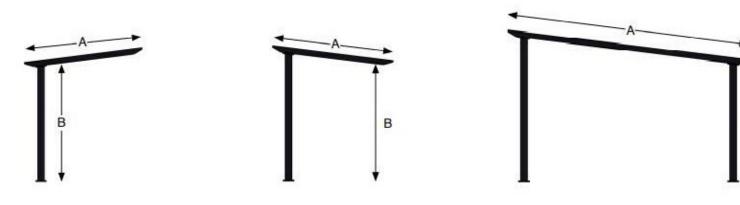

Model	LS	HS	DS
LSX Maximum Modules Deep (A)	4	4	10
GSX Maximum Modules Deep* (A)	3	3	10
Standard Low Side Clearance (B)	8'	8'	8'
Tall Low Side Clearance (B)	14'	14'	14'

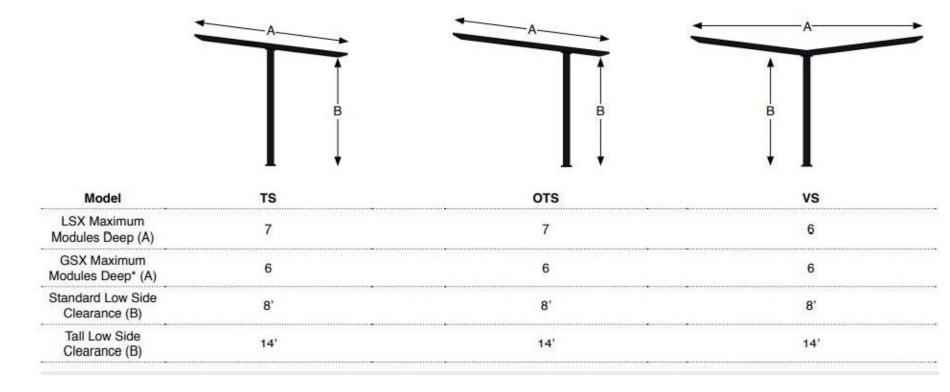


MECHANICAL SPECIFICATIONS

LSX SolarScape Classic

Modules Deep	Array Depth ft - in	Array Width ft - in	LS	нѕ	DS	TS	vs	отѕ
1	5 - 5	Unlimited	X	X	Х	Χ		
2	10 - 10 1/4	Unlimited	Х	Х	Χ	Χ	Х	
3	16 - 3 5/8	Unlimited	Х	Х	Х	Χ		Χ
4	21 - 8 7/8	Unlimited	Х	Х	Х	Х	Х	Х
5	27 - 2 1/8	Unlimited			Х	Х		×
6	32 - 7 3/8	Unlimited			Х	Х	Х	Х
7	38 - 5/8	Unl <mark>i</mark> mited	•		Х	Х		Х
8	43 - 5 7/8	Unlimited			Х			Ī
9	48 - 11 1/4	Unlimited			X			
10	54 - 4 1/2	Unlimited			Χ	İ		

IOTIONAL SOLAR BUS SHELTER



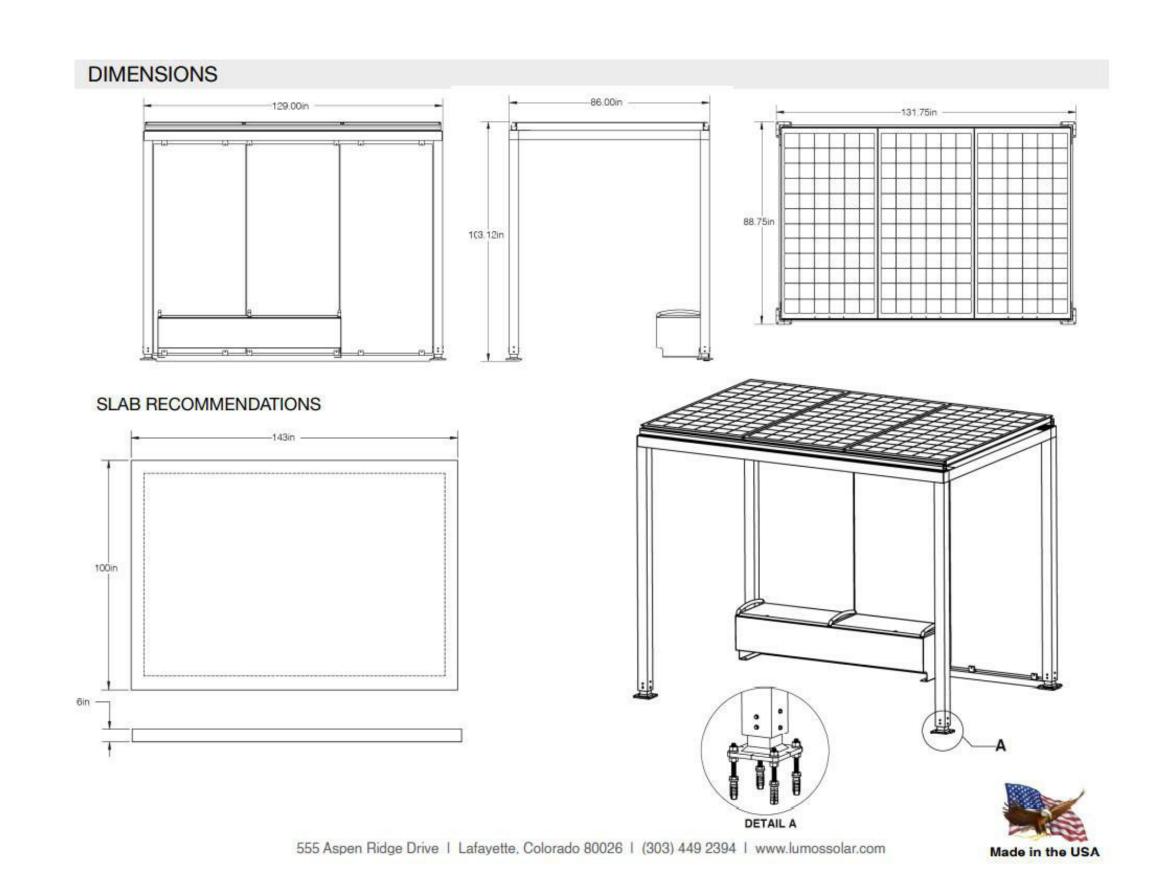

Denver, Colorado 80204


BOULDER COUNTY HOUSING AUTHORITY 3400 BROADWAY BOULDER, CO - 80304 303.441.3861 CONTACT: MOLLY CHIANG

DATE: 06.17.22 - SITE PLAN 01

SHEET TITLE: SITE

PHOTOMETRICS

WILLOUGHBY CORNER PHOTOMETRICS

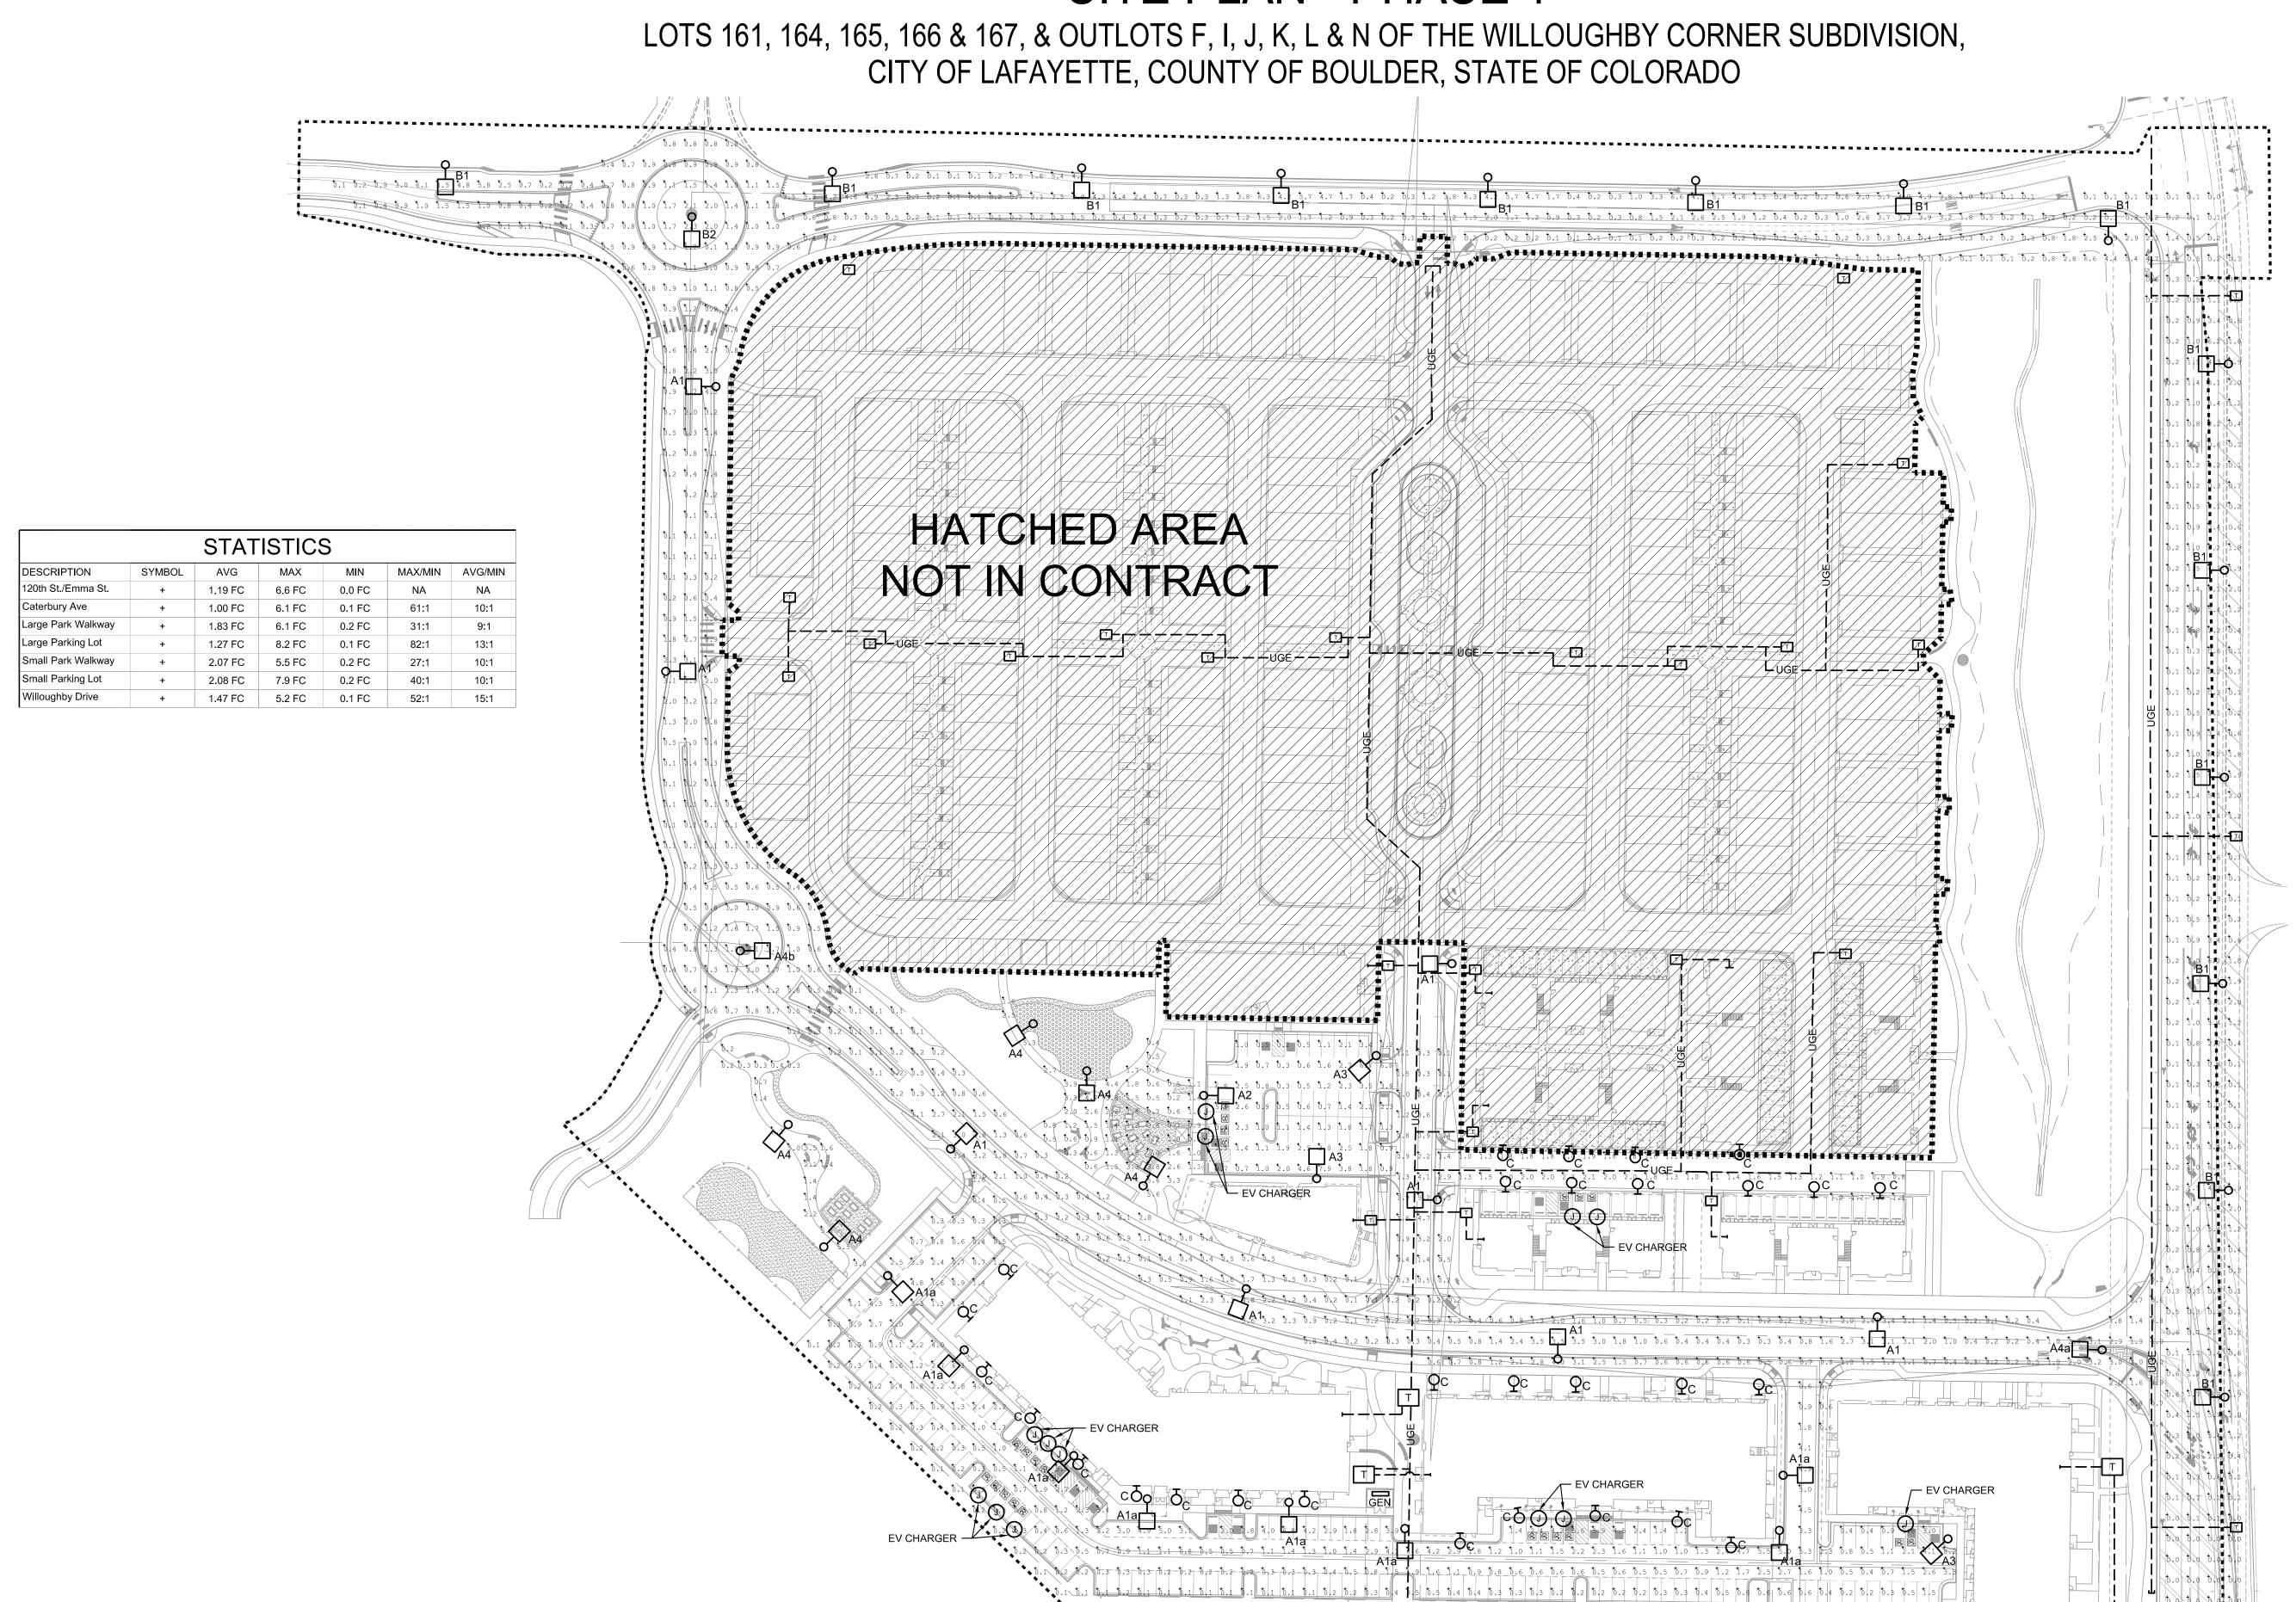


SHEET TITLE: SITE

PHOTOMETRICS (CANOPY ALTERNATE)

SITE PLAN - PHASE 1

LOTS 161, 164, 165, 166 & 167, & OUTLOTS F, I, J, K, L & N OF THE WILLOUGHBY CORNER SUBDIVISION, CITY OF LAFAYETTE, COUNTY OF BOULDER, STATE OF COLORADO

		SITE	LUMINAIRE SCH	EDULE				
TYPE	MANUFACTURER	CATALOG NUMBER	LAMP DESCRIPTION	VOLTAGE	LOAD (VA)	FINISH	MOUNTING	DESCRIPTION
A1	VISIONAIRE LIGHTING	ODEN SERIES (TYPE 2 DISTRIBUTION)	LED, 3000K	MVOLT	105 WATTS	BLACK	25' POLE	SPUN ALUMINUM AREA/ROADWAY LUMINAIRE WITH YOLK MOUNT ARM, 13000 LUMEN LED, TYPE 2 DISTRIBUTION
A1a	VISIONAIRE LIGHTING	ODEN SERIES (TYPE 2 DISTRIBUTION)	LED, 3000K	MVOLT	105 WATTS	BLACK	20' POLE	SPUN ALUMINUM AREA/ROADWAY LUMINAIRE WITH YOLK MOUNT ARM, 13000 LUMEN LED, TYPE 2 DISTRIBUTION
A2	VISIONAIRE LIGHTING	ODEN SERIES (TYPE 3 DISTRIBUTION)	LED, 3000K	MVOLT	140 WATTS	BLACK	20' POLE	SPUN ALUMINUM AREA/ROADWAY LUMINAIRE WITH YOLK MOUNT ARM, 16700 LUMEN LED, TYPE 3 DISTRIBUTION
А3	VISIONAIRE LIGHTING	ODEN SERIES (TYPE 4 DISTRIBUTION)	LED, 3000K	MVOLT	177 WATTS	BLACK	20' POLE	SPUN ALUMINUM AREA/ROADWAY LUMINAIRE WITH YOLK MOUNT ARM, 20000 LUMEN LED, TYPE 4 DISTRIBUTION
A4	VISIONAIRE LIGHTING	ODEN SERIES (TYPE 5W DISTRIBUTION)	LED, 3000K	MVOLT	177 WATTS	BLACK	15' POLE	SPUN ALUMINUM AREA/ROADWAY LUMINAIRE WITH YOLK MOUNT ARM, 20000 LUMEN LED, TYPE 4 DISTRIBUTION
A4a	VISIONAIRE LIGHTING	ODEN SERIES (TYPE 5W DISTRIBUTION)	LED, 3000K	MVOLT	177 WATTS	BLACK	25' POLE	SPUN ALUMINUM AREA/ROADWAY LUMINAIRE WITH YOLK MOUNT ARM, 20000 LUMEN LED, TYPE 4 DISTRIBUTION
A4b	VISIONAIRE LIGHTING	ODEN SERIES (TYPE 5W DISTRIBUTION)	LED, 3000K	MVOLT	177 WATTS	BLACK	20' POLE	SPUN ALUMINUM AREA/ROADWAY LUMINAIRE WITH YOLK MOUNT ARM, 20000 LUMEN LED, TYPE 4 DISTRIBUTION
B1	VISIONAIRE LIGHTING	RLX-1 SERIES (TYPE 4A DISTRIBUTION)	LED, 3000K	MVOLT	140 WATTS	BLACK	25' POLE	DIE CAST ALUMINUM LED COBRA HEAD LUMIANIRE WITH TYPE 4A DISTRIBUTION, 16700 LUMEN LED
B2	VISIONAIRE LIGHTING	RLX-1 SERIES (TYPE 5W DISTRIBUTION)	LED, 3000K	MVOLT	177 WATTS	BLACK	25' POLE	DIE CAST ALUMINUM LED COBRA HEAD LUMIANIRE WITH TYPE 5W DISTRIBUTION, 20000 LUMEN LED
С	MCGRAW EDISON	IMPACT ELITE LED SERIES	LED, 3000K	MVOLT	20 WATTS	BLACK	WALL MOUNTED	LED WALL PACK WITH BLACK FINISH, TRAPAZOIDAL PROFILE, TYPE 3 DISTRIBUTION, 2500 LUMEN LED
D	FAILE-SAFE	HVL8 LED SERIES (ALTERNATE PLAN ONLY)	LED, 3000K	MVOLT	5.8 WATTS	WHITE	SURFACE	12"X8" VANDAL RESISTANT LED CANOPY LUMINAIRE WITH OPAL POLYCARBONATE LENS, HEAVY DUTY EXTRUDED ALUMINUM HOUSING

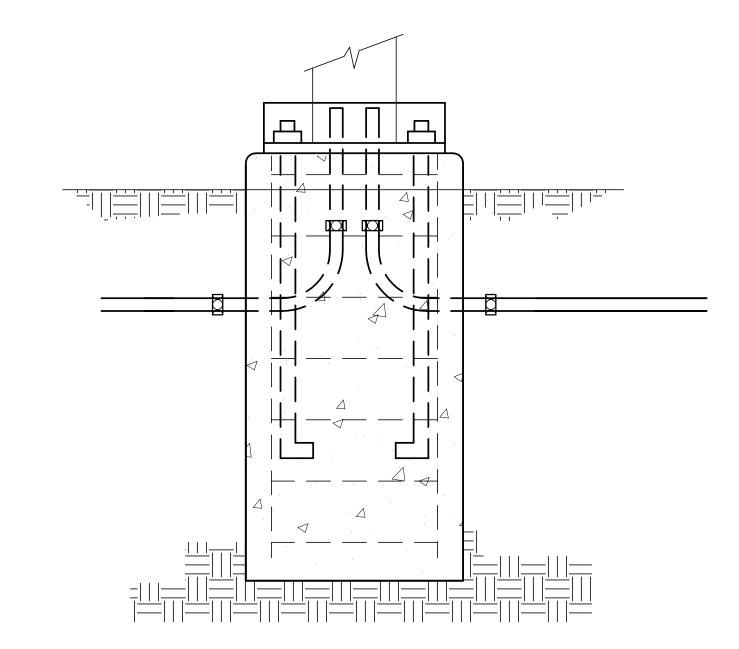

POLE BASE DETAIL

NOTES: A. PROVIDE ALL HOLLOW POLES WITH VIBRATION DAMPERS BY THE FACTORY.	
STATISTICS	2.5 1.2 0.4 1.6 2.0 2.1 2.1 2.2 2.1 2.0 2.0 1.8 1.3 1.0 1.1 1.4 1.6 1.5 1.3 1.2 1.1 1.0 0.9 0.8 C C C C C C C C C C C C C C C C C C C
DESCRIPTION SYMBOL AVG MAX MIN MAX/MIN AVG/MIN 120th St./Emma St. + 1.02 FC 6.6 FC 0.0 FC NA NA	1.1 2 0.8 0.5 0.3 0.4 1 1 1 1 1 1 1 1 1 1 1 1 1 1 1 1 1 1 1
120th St./Emma St. + 1.02 FC 6.6 FC 0.0 FC NA NA Caterbury Ave + 1.03 FC 4.9 FC 0.1 FC 49:1 10:1	1 8 0 0 0 1 0 1 0 1 0 1 0 1 0 1 0 1 0 1
Large Park Walkway + 2.00 FC 5.3 FC 0.0 FC NA NA	
Large Parking Lot + 1.33 FC 5.5 FC 0.1 FC 55:1 13:1	** ** ** ** ** ** ** ** ** ** ** ** **
Small Park Walkway + 2.00 FC 5.8 FC 0.2 FC 29:1 10:1	
Small Parking Lot + 1.98 FC 5.4 FC 0.5 FC 11:1 4:1	
Willoughby Drive + 1.53 FC 3.8 FC 0.2 FC 19:1 8:1	D 3.7 19 1.1 1.4 0.6 0.3 0.5 0.9 1.6 1.6 1.8 1.4 0.6 0.3 0.2 0.5 0.8 0.3
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	5.1 5.2 5.2 5.2 5.2 5.2 5.2 5.2 5.2 5.2 5.2

LOTS 161, 164, 165, 166 & 167, & OUTLOTS F, I, J, K, L & N OF THE WILLOUGHBY CORNER SUBDIVISION,


CITY OF LAFAYETTE, COUNTY OF BOULDER, STATE OF COLORADO

NORRIS DESIGN
Planning | Landscape Architecture | Branding

1101 Bannock Street

Denver, Colorado 80204



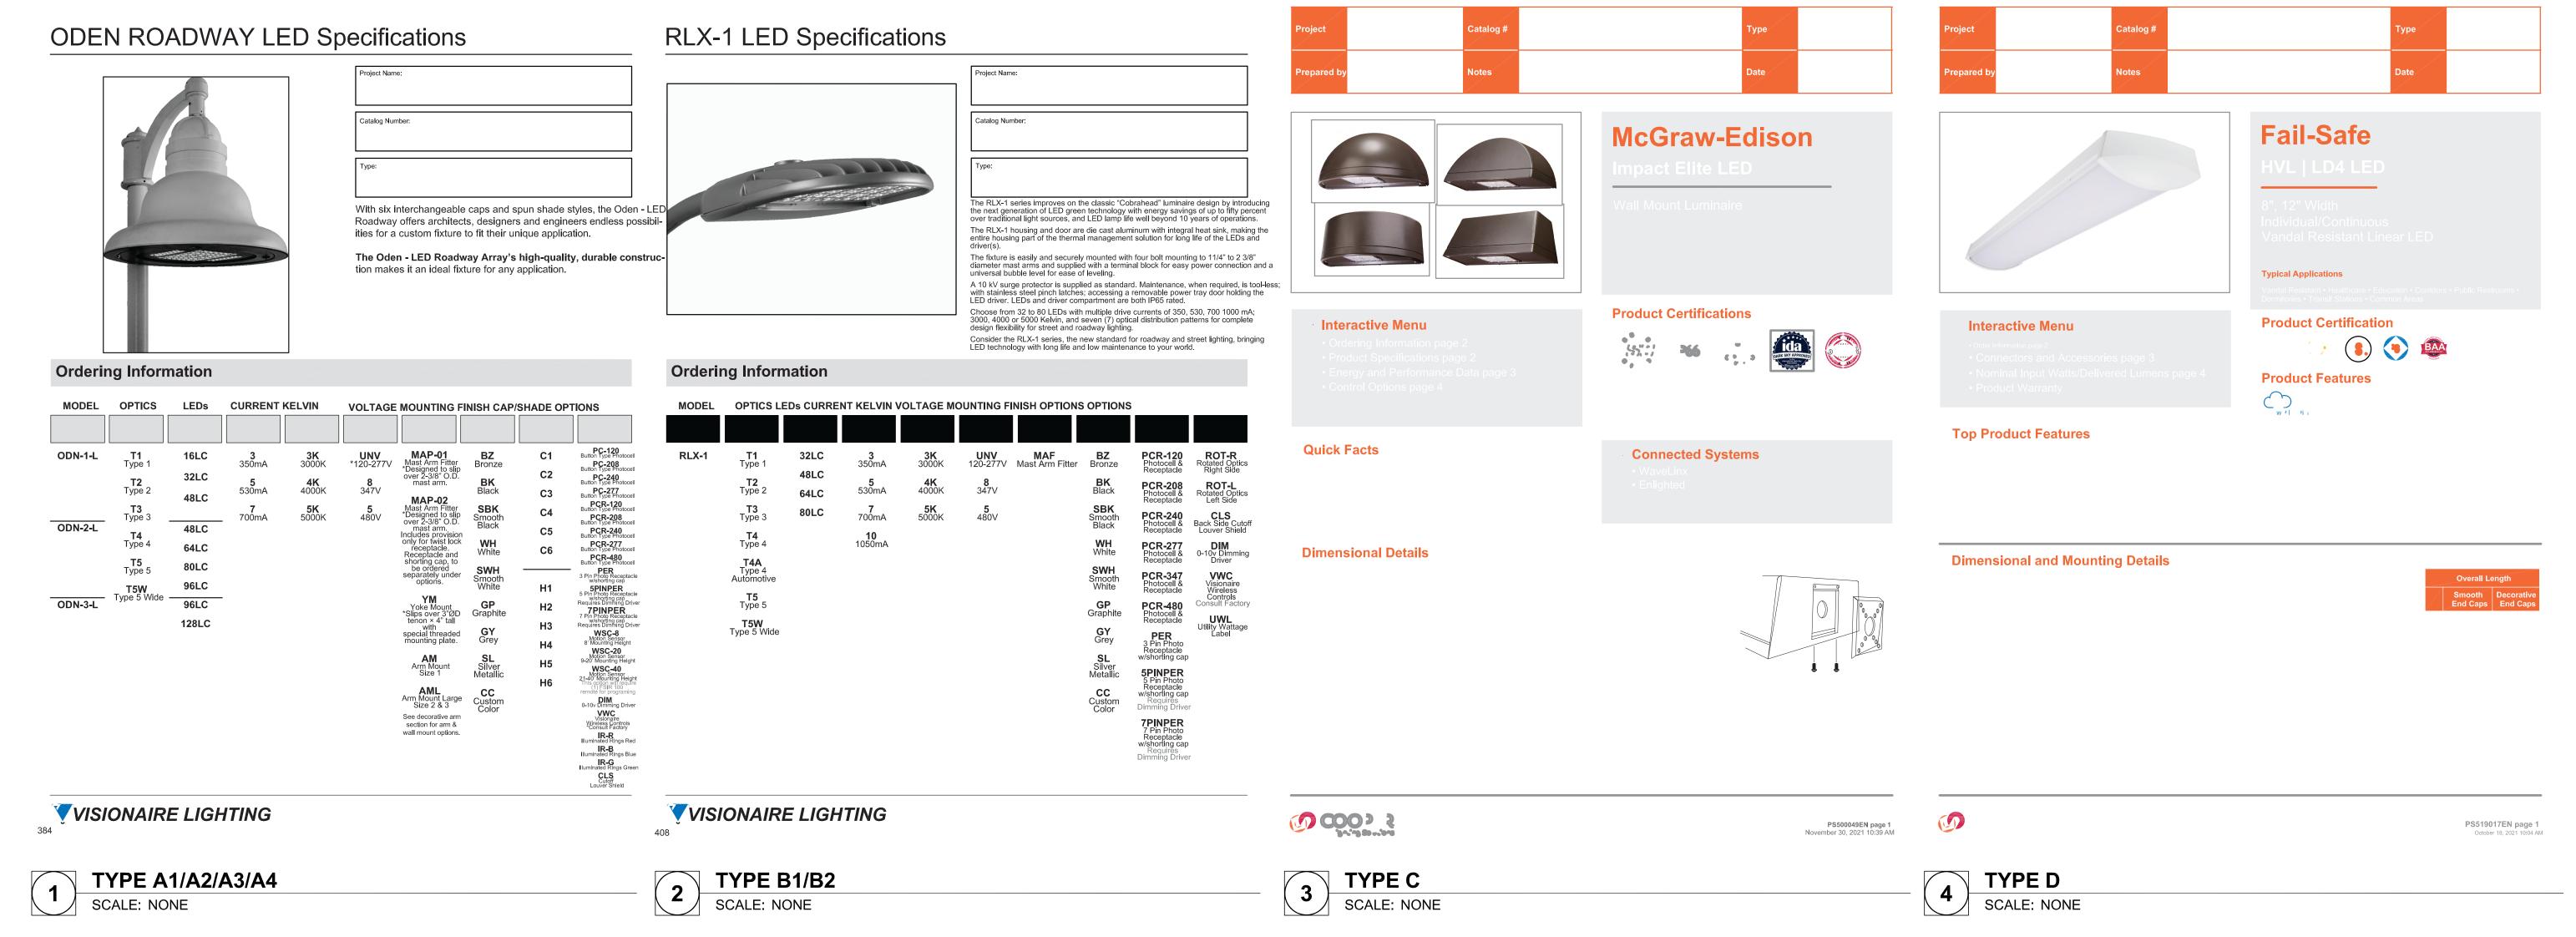

DATE: 06.17.22 - SITE PLAN 01 09.15.22 - SITE PLAN 02

OWNER:

BOULDER COUNTY HOUSING

AUTHORITY 3400 BROADWAY BOULDER, CO - 80304

303.441.3861 CONTACT: MOLLY CHIANG

SHEET TITLE: PHOTOMETRIC

DATAILS